Oversight / NHS			
FHWA REGION VIII OVERSIGHT?	0	NO	YES
NATIONAL HIGHWAY SYSTEM?		NO	YES

PROJECT DESCRIPTION

REMOVAL AND DISPOSAL OF EXISTING TILE BLOCK PANELS, FABRICATION AND INSTALLATION OF NEW TILE-FACED PRECAST CONCRETE PANELS, AND INCIDENTAL WORK.

DEPARTMENT OF TRANSPORTATION STATE OF COLORADO


HIGHWAY CONSTRUCTION BID PLANS OF PROPOSED FINIT FEDERAL AID PROJECT NO. IM-0703-322 **STATE HIGHWAY NO. 70** EISENHOWER/JOHNSON MEMORIAL TUNNEL PANEL REPLACEMENT PROJECT-ESMT-South Tunnel SUMMIT AND CLEAR CREEK COUNTIES



	1-70 EA	STBOUND
STATION	ROADWAY	MAJOR STR.
	LIN FT	LIN FT
APPROACH TO PROJECT (WEST) BEGIN PROJECT IM-0703-322 STA. 30+97.82 EB ON 1-70 STRUCTURE F-13-X M.P. 213.65 END PROJECT IM-0703-322 STA. 130+57.28 EB ON 1-70 APPROACH TO PROJECT (EAST)	5280 500 8976 500 5280	8976
SUMMARY OF PROJECT LENGTH	FEET	MILES
ROADWAY (NET LENGTH) MAJOR STRUCTURE	11560 8976	2.19 1.70
PROJECT GROSS LENGTH	20536	3.89

DESIGN DATA	
MINIMUM RADIUS OF CURVE (EXISTING)	3° 30'
MAXIMUM GRADE (EXISTING)	2.23%
MINIMUM S.S.D. HORIZONTAL (EXISTING)	350'
MINIMUM S.S.D. VERTICAL (EXISTING)	490'
MAXIMUM DESIGN SPEED	*65 MPH

* POSTED SPEED LIMIT . 50MPH

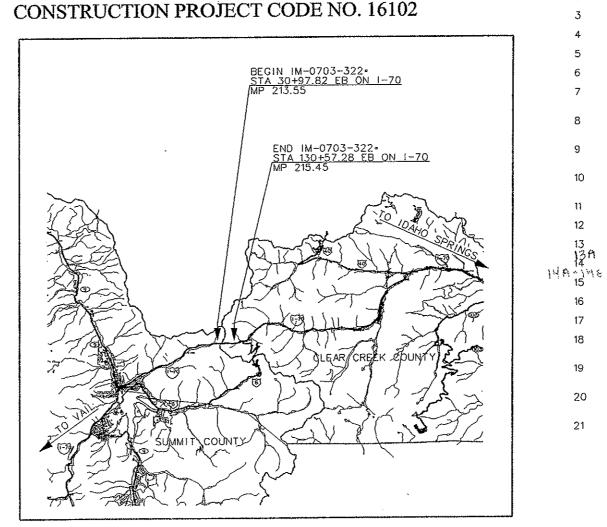



As Constructed Sheet Revisions Colorado Department of Transportation Print Date: 2/14/2008 Contrac File Name:EJMT_TO_01_TitleSheet.dgn Init. Comments Date: No Revisions P.O. Box 399 Dumont, CO 80436 Phone: (303) 512-5750 Fax: (303) 512~5775 Residen DOTVert. Scole: As Noted \square Horiz. Scale: As Noted Project Revised: 9/30/ Unit Leader STW \square Unit 0221 PROJECT 1700 Broadway Suite 900 Denver, CO 80290 (303) 863-7900 \square Region 1 Mountain Residency R.M.S. Void: PPARSONS. Comments $\overline{}$

Related Projects: P. E. UNDER PROJECT: Project Number Project Code:	IM-0703-254 12982
R.O.W. Projects:	
R.O.W. Project Description	

SHEET NO. INDEX OF SHEETS

TITLE SHEET STANDARD PLANS LIST GENERAL INFORMATION SUMMARY OF APPROXIMATE QUANTITIES SURVEY TABULATION SITE PLAN SOUTH TUNNEL SCHEMATIC PANEL LAYOUT (WEST PORTAL TO STA 56+90.43) SOUTH TUNNEL SCHEMATIC PANEL LAYOUT (STA 56+90.43 TO STA 81+02.43) SOUTH TUNNEL SCHEMATIC PANEL LAYOUT (STA 81+02.43 TO STA105+14.43) SOUTH TUNNEL SCHEMATIC PANEL LAYOUT (STA 105+14.43 TO EAST PORTAL) SOUTH TUNNEL TYPICAL SECTIONS (EXISTING) (1) SOUTH TUNNEL TYPICAL SECTIONS (EXISTING) (11) TILE-FACED PRECAST CONCRETE PANEL DETAILS (1) NEVISED DETAILS TILE-FACED PRECAST CONCRETE PANEL DETAILS (11) REVISED DE TAILS SPECIAL PANEL DETAILS (1) DETAILS FOR RESET LUMINAIRE DETAILS FOR RESET HANDRAIL TABLE OF SPECIAL PANELS SOUTH WALL TABLE OF SPECIAL PANELS NORTH WALL (1) TABLE OF SPECIAL PANELS NORTH WALL (11) TABLE OF SPECIAL PANELS NORTH WALL (111)

NEW AND REVISED STANDARDS

S-630-1 TRAFFIC CONTROLS FOR HIGHWAY CONSTRUCTION (03/05/2007)

Contract Information	Project No./Code
ctor: FLATIBONS CONSTRUCTORS INC.	IM-0703~322
t Engineer: MARK VESSELY	
Engineer: GARY KACZYNSKI	16102
STARTED: 612108 ACCEPTED: 9_13009	Sheet Number 1
s:	Sileer Nomber

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PL AN NUMBE R M-100-1 M-203-1 M-203-12 M-203-12 M-206-1 M-206-2 M-208-1 M-206-1 M-601-1 M-601-1 M-601-10 M-601-12 M-601-10 M-601-12 M-603-1 M-603-1 M-603-2 M-603-1 M-603-10 M-603-10 M-603-10 M-604-12 M-604-12 M-604-13 M-604-12 M-604-13 M-604-25 M-605-1 M-606-13 M-606-13	APPRO DITCH SUPER SUPER EXCAV EXCAV M STANDARD TITLE ARD SYMBOLS (3 SHEETS) IACH ROADS TYPES ELEVATION CROWNED AND DIVIDED HIGHWAYS (2 ELEVATION STREETS (2 SHEETS) IACH NAND BACKFILL FOR STRUCTURES (2 SHEE IATION AND BACKFILL FOR BRIDGES (2 SHEETS) IATION AND BACKFILL FOR BRIDGES (2 SHEETS) ING DETAILS STURAL PLATE PIPE H-20 LOADING ING CONCRETE BOX CULVERT (2 SHEETS) INALL FOR PIPES "S' SADDLE HEADWALLS FOR PIPE WALLS AND PLASTIC PIPE (2 SHEETS) AND PLASTIC PIPE (2 SHEETS) </td <td>NUMBER 1-3 4 5 5 SHEETS) 6-8 9-10 ISJ 11-12 13-14 15-21 22-23 24 25-29 30 31-32 33-34 35-36 37 38 39 40 41-42 43 44 45-46 47 48 49-50 51 52-54 55-59 60 61-76 77-80</td> <td>PLAN NUMBER M-607-1 M-607-2 M-607-3 M-607-4 M-607-10 M-607-15 M-607-15 M-608-1 M-608-1 M-613-1 M-614-1 M-614-2 M-614-2 M-615-1 M-615-1 M-615-2 M-615-1 M-620-12 M-620-12 M-620-12 M-629-1</td> <td>C CI C CI</td> <td>D TITLE NUMBER IRE FENCES AND GATES (3 SHEETS) 84-86 HAIN LINK FENCE (3 SHEETS) 87-89 ARRIER FENCE 90 EAR FENCE AND GATES (2 SHEETS) 91-92 ICKET SNOW FENCE 93 DAD CLOSURE GATE (9 SHEETS) 94-102 JRB RAMPS (4 SHEETS) 94-102 JRB RAMPS (4 SHEETS) 103-106 JRSS, GUTTERS, AND SIDEWALKS (3 SHEETS) 107-109 ATTLE GUARD (2 SHEETS) 107-109 ATTLE GUARD (2 SHEETS) 107-109 ATTLE GUARD (2 SHEETS) 110-111 DAD MWAY LIGHTING (4 SHEETS) 112-115 UMBLE STRIPS (3 SHEETS) 110-118 AND BARREL ARRAYS (2 SHEETS) 110-118 AND BARREL ARRAYS (2 SHEETS) 119-120 WBANKMENT PROTECTOR TYPE 3 121 WBANKMENT PROTECTOR TYPE 5 122 IVERTED SIPHON 123 IELD LABORATORY CLASS 1 124 IELD OFFICE CLASS 1 125 IELD OFFICE CLASS 2 127 URVEY MONUMENTS (2 SHEETS) 128-129 INDARD PLAN SHEETS INDICATED HEREON BY A BOX ARE TO BE USED TO CONSTRUCT THIS</td> <td>PLAN NUMBER S-612-1 S-614-2 S-614-2 S-614-3 S-614-4 S-614-5 S-614-6 S-614-6 S-614-10 S-614-10 S-614-12 S-614-12 S-614-20 S-614-21 S-614-21 S-614-20 S-614-20 S-614-20 S-614-20 S-614-50 S-614-50 S-614-50 S-630-2 S-630-3</td> <td>- - </td>	NUMBER 1-3 4 5 5 SHEETS) 6-8 9-10 ISJ 11-12 13-14 15-21 22-23 24 25-29 30 31-32 33-34 35-36 37 38 39 40 41-42 43 44 45-46 47 48 49-50 51 52-54 55-59 60 61-76 77-80	PLAN NUMBER M-607-1 M-607-2 M-607-3 M-607-4 M-607-10 M-607-15 M-607-15 M-608-1 M-608-1 M-613-1 M-614-1 M-614-2 M-614-2 M-615-1 M-615-1 M-615-2 M-615-1 M-620-12 M-620-12 M-620-12 M-629-1	C CI C CI	D TITLE NUMBER IRE FENCES AND GATES (3 SHEETS) 84-86 HAIN LINK FENCE (3 SHEETS) 87-89 ARRIER FENCE 90 EAR FENCE AND GATES (2 SHEETS) 91-92 ICKET SNOW FENCE 93 DAD CLOSURE GATE (9 SHEETS) 94-102 JRB RAMPS (4 SHEETS) 94-102 JRB RAMPS (4 SHEETS) 103-106 JRSS, GUTTERS, AND SIDEWALKS (3 SHEETS) 107-109 ATTLE GUARD (2 SHEETS) 107-109 ATTLE GUARD (2 SHEETS) 107-109 ATTLE GUARD (2 SHEETS) 110-111 DAD MWAY LIGHTING (4 SHEETS) 112-115 UMBLE STRIPS (3 SHEETS) 110-118 AND BARREL ARRAYS (2 SHEETS) 110-118 AND BARREL ARRAYS (2 SHEETS) 119-120 WBANKMENT PROTECTOR TYPE 3 121 WBANKMENT PROTECTOR TYPE 5 122 IVERTED SIPHON 123 IELD LABORATORY CLASS 1 124 IELD OFFICE CLASS 1 125 IELD OFFICE CLASS 2 127 URVEY MONUMENTS (2 SHEETS) 128-129 INDARD PLAN SHEETS INDICATED HEREON BY A BOX ARE TO BE USED TO CONSTRUCT THIS	PLAN NUMBER S-612-1 S-614-2 S-614-2 S-614-3 S-614-4 S-614-5 S-614-6 S-614-6 S-614-10 S-614-10 S-614-12 S-614-12 S-614-20 S-614-21 S-614-21 S-614-20 S-614-20 S-614-20 S-614-20 S-614-50 S-614-50 S-614-50 S-630-2 S-630-3	- -

COLORADO DEPARTMENT OF TRANSPORTATION
STANDARD PLANS LIST
M&S STANDARDS
JULY 4,2006

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1700 Brogdway Suite 900	$\exists \vdash$						Detailer:
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	CLASS IL SIGNS	
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SENHOWER/JOHNS	ON MEMORIA	AL TUNNEL JECT	Project No./Co	de
STANDARD	PLANS LIST	r	IM-0703~322	
	J. BRAAKSMA Structure		16102	
r: J. SPANIER	Numbers			
Subset:	Subset Shee	ts:	Sheet Number 2	

GENERAL NOTES

ALL WORK SHALL BE DONE ACCORDING TO THE STANDARD SPECIFICATIONS OF THE COLORADO DEPARTMENT OF TRANSPORTATION, APPLICABLE TO THE PROJECT.

EXPANSION JOINT MATERIAL SHALL MEET AASHTO SPECIFICATION M-213.

ALL STRUCTURAL STEEL SHALL BE AASHTO M-270 (ASTM A709), UNLESS OTHERWISE NOTED AND SHALL BE INCLUDED IN THE COST OF ITEMS LISTED IN THE "SUMMARY OF QUANTITIES."

GRADE 60 REINFORCING STEEL IS REQUIRED.

ALL REINFORCING STEEL SHALL BE NON-EPOXY COATED UNLESS OTHERWISE NOTED AND SHALL BE INCLUDED IN THE COST OF ITEMS LISTED IN THE "SUMMARY OF QUANTITIES."

THE FOLLOWING TABLE GIVES THE MINIMUM LAP SPLICE LENGTH FOR REINFORCING BARS PLACED IN ACCORDANCE WITH SUBSECTION 602.06. LENGTHS SHALL BE INCREASED BY 25% FOR BARS SPACED AT LESS THAN 6" ON CENTER.

BAR SIZE	#4	#5	#6	#7	#8	#9	#10	#11
SPLICE LENGTH FOR CLASS D CONCRETE EPOXY COATED REINFORCING BARS	1'-3''	1'-7"	2'-5"	2'~10''	3'-8"	4'~8"	5'-11"	7'-3"
SPLICE LENGTH FOR CLASS S35 CONCRETE BLACK REINFORCING BARS	\$'-4"	1'→4 "	₽-7"	1'-10"	2'~4"	2'-11"	3'-9"	4'-7"

CONCRETE SHALL BE SUITABLE FOR SULFATE PROTECTION AGAINST EXPOSURE CLASS 0.

ALL CONSTRUCTION JOINTS NOT SHOWN ON THE PLANS SHALL BE APPROVED BY THE ENGINEER.

THE MINIMUM COVER, MEASURED FROM THE FACE OF THE CONCRETE TO THE SURFACE OF ANY REINFORCING BAR SHALL BE 2", EXCEPT WHERE OTHERWISE NOTED.

ANY REINFORCING STEEL SPLICES NOT SHOWN SHALL BE APPROVED BY THE ENGINEER. THE SPLICE LOCATIONS SHALL BE ALTERNATED WHEN POSSIBLE.

THE CONTRACTOR SHALL BE RESPONSIBLE FOR THE STABILITY OF THE PANELS DURING CONSTRUCTION.

THE INFORMATION SHOWN ON THESE DRAWINGS CONCERNING TYPE AND LOCATION OF UTILITIES IS NOT GAURANTEED TO BE ACCURATE OR ALL INCLUSIVE. THE CONTRACTOR IS RESPONSIBLE FOR MAKING HIS OWN DETERMINATION AS TO THE TYPE AND LOCATION OF UTILITIES AS MAY BE NECESSARY TO AVOID DAMAGE TO THEM.

ALL STATIONS AND DIMENSIONS CONTAINED IN THESE PLANS ARE CALCULATED FROM THE "AS CONSTRUCTED PLANS" AND FIELD SURVEYS. THE CONTRACTOR SHALL VERIFY ALL DEPENDENT DIMENSIONS IN THE FIELD BEFORE ORDERING OR FABRICATING ANY MATERIALS OR PANELS, AND DIMENSIONS SHALL BE ADJUSTED TO MEET THE EXISTING STRUCTURE.

ANY ELECTRICAL WORK INVOLVING EXISTING TUNNEL ELECTRICAL SYSTEMS OR CONNECTION TO EXISTING TUNNEL ELECTRICAL SYSTEMS SHALL HAVE PRIOR APPROVAL OF THE TUNNEL ELECTRICIAN. THE CONTRACTOR SHALL PROVIDE A WRITTEN METHOD/PROCEDURE DETAILING EACH TYPE OF ELECTRICAL RESET, FOR TUNNEL ELECTRICIAN APPROVAL. THE CONTRACTOR SHALL COMPLY WITH ALL INSPECTION REQUIREMENTS OF ELECTRICAL WORK IMPOSED BY THE TUNNEL ELECTRICIAN. ALL ELECTRICAL RESET WORK SHALL RESULT IN REINSTALLATIONS THAT OPERATE THE SAME AS OR BETTER THAN THEIR ORIGINAL FUNCTIONS.

THE CONTRACTOR SHALL PROVIDE ALL ELECTRICAL POWER NEEDED TO PERFORM THE WORK.

ALL EXTERIOR CONCRETE CORNERS SHALL BE CONSTRUCTED WITH 3/4" CHAMFERS. UNLESS OTHERWISE NOTED.

	DES	IGN	DATA
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TILE-FACED PRECAST CONCRETE PANELS LIVE LOAD : 20 POUNDS PER SQUARE FOOT DEAD LOAD ; SELF WEIGHT ERECTION LOADS : BY CONTRACTOR REINFORCED CONCRETE: CLASS D CONCRETE: f'c = 4,500 psi CLASS S35 CONCRETE: f'c = 5.000 psi REINFORCING STEEL: fy = 60,000 psi STRUCTURAL STEEL: AASHTO M-270 (ASTM A709) GRADE 36 fy = 36,000 psi DESIGN METHOD: AASHTO LRFD BRIDGE DESIGN SPECIFICATIONS, 4TH EDITION.

ABBREVIATIONS

CL - CLEAR EW · EACH WAY EF * EACH FACE FF = FAR FACE NF . NEAR FACE CONT . CONTINUOUS CIP = CAST-IN-PLACE EXIST - EXISTING

EQ SPA = EQUAL SPACES HCL = HORIZONTAL CONTROL LINE PGL - PROFILE GRADE LINE EL OR ELEV . ELEVATION (TYP) = TYPICAL CONC - CONCRETE REINF . REINFORCING

Print Date: 2/14/2008			Sheet Revisions		Colorado Department of Transportation	As Constructed	EISENHOWER/JOHNSI PANEL REPLAC	ON MEMORIAL TUNNEL EMENT PROJECT	Project No./Code
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Unit 0221 Unit Leader STW					Phone: (303) 512-5750 Fax: (303) 512-5775	Revised:	Designer: J. BRAAKSMA Detailer: J. SPANIER	·	16102
■ PARSONS 1700 Broadway Suite 900 Denver, CO 80290 (303) 863-7900	8				Region 1 Mountain Residency R.M.S.	Void:		Subset Sheets: S-1 OF S-19	Sheet Number 3

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	(STA 56+90.43 TO STA 81+02.43)
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			REMOVAL OF EXISTING WALL PANELS	LF	8,405																8,405	0	
			RESET PIPE HANDRAILING	EACH	12																12	2	
-	$\left - \right - $	1	RESET TV CAMERAS	EACH	128																128	128	
			RESET LUMINAIRE	LF	1,200					•											1,200	541.5	
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		700-70011	F/A PARTNERING	FA	1																(0	
		700-70022	F/A OJT COLORADO TRAINING PROGRAM	FA	1							-											1
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		700-7003	F/A ANTICIPATED CMO	FA																			
		900-00014	NEW PIPE HANDRATH ANGLES, WALK CAMERA CABENETS AND FLEER	15				 	<u> </u>													+	
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ment Marking (Section 627)

- Striping (Temp)
 Striping (Perm)
 Symbols

- 🗂 Other: .
- porary Lighting and Construction Traffic Control Devices (Section 630)
- Signal pole locations and elevations (Temp) Light pole locations and elevations (Temp)
- ☐ Sign Locations (Temp) ☐ Other: _____

ements (Temp Staking by P.L.S. Only)

t of Way (Temp Staking by P.L.S. Only)

D BY THE CONTRACTOR'S SURVEYOR UNDER SECTION 629:

mentation (Section 629)

- Right of Way
- Land corners, Aliquot corners
- Easements
- Reference the specified existing monuments: **
- Replace the specified existing monuments: **
 Locate monuments. It is estimated hours are required.
- Al 629 items shall include adequate research, calculations, and evaluations of evidence for manuments to be set.
- Tabulation of Survey Monuments may be provided on the plans.

erwise on this Survey Tabulation Sheet, all survey work and staking intervals shall nce with the latest edition of the CDDT Survey Manual.

for establishing lines, grades, and locations for all work items have been specified lditional information required to stake the item or element shall be generated by rveyor.

veyar shall provide an estimate of the man-hours necessary to complete the work his sheet. A copy of this sheet, with the estimated mon-hours written on the of the specified items, shall be submitted with the Survey Schedule to the s prior to the Presurvey Conference - Construction Survey.

nts which are damaged or destroyed by the progress of construction shall be ntractor at no additional cost to the Department.

furnish an As Staked earthwork quantity to the Engineer prior to completion of (2) of the planned earthwork in any phase as per the CDUT Survey Manual. A printed ked earthwork data and a computer disk in the specified format shall be submitted Contractor shall field verify original ground cross sections at a maximum 500 feet

rork on any subsequent operation, such as placing base course or paving, the lify in writing to the Engineer that the final grade is within specified tolerance. veyor shall perform all field surveying and calculations necessary to the plan grades

coordinate construction staking on the project with any utility work.

ain daily records of points set and or measurements observed. The information recorded rew members' names, point no., description, staking information, and sketches. If the survey ted electronically, information recorded shall be provided to the Project Engineer in a hard intuitive, clear and related to the supplemental information recorded in the field books. All as slope stokes and blue tops, shall have the station and offset information related to the n. Non-linear surveys such as structures staking shall have sketches relating electronic point numbers, to the sketch.

rveyor shall submit the following fieldbooks to the Engineer:

rol (Primary & Secondary)


(i.e. Benchmarks)

ies

ment


for each work category shown on this sheet (s):

SURVEY 7	ABULA	TION	Project No./Code
SH	EET		IM 0703-322
er: B. Claybrook	Structure	F-13-X	16102
: B. Claybrook	Numbers		
Subset:	Subset Sh	eets: 1 of 1	Sheet Number

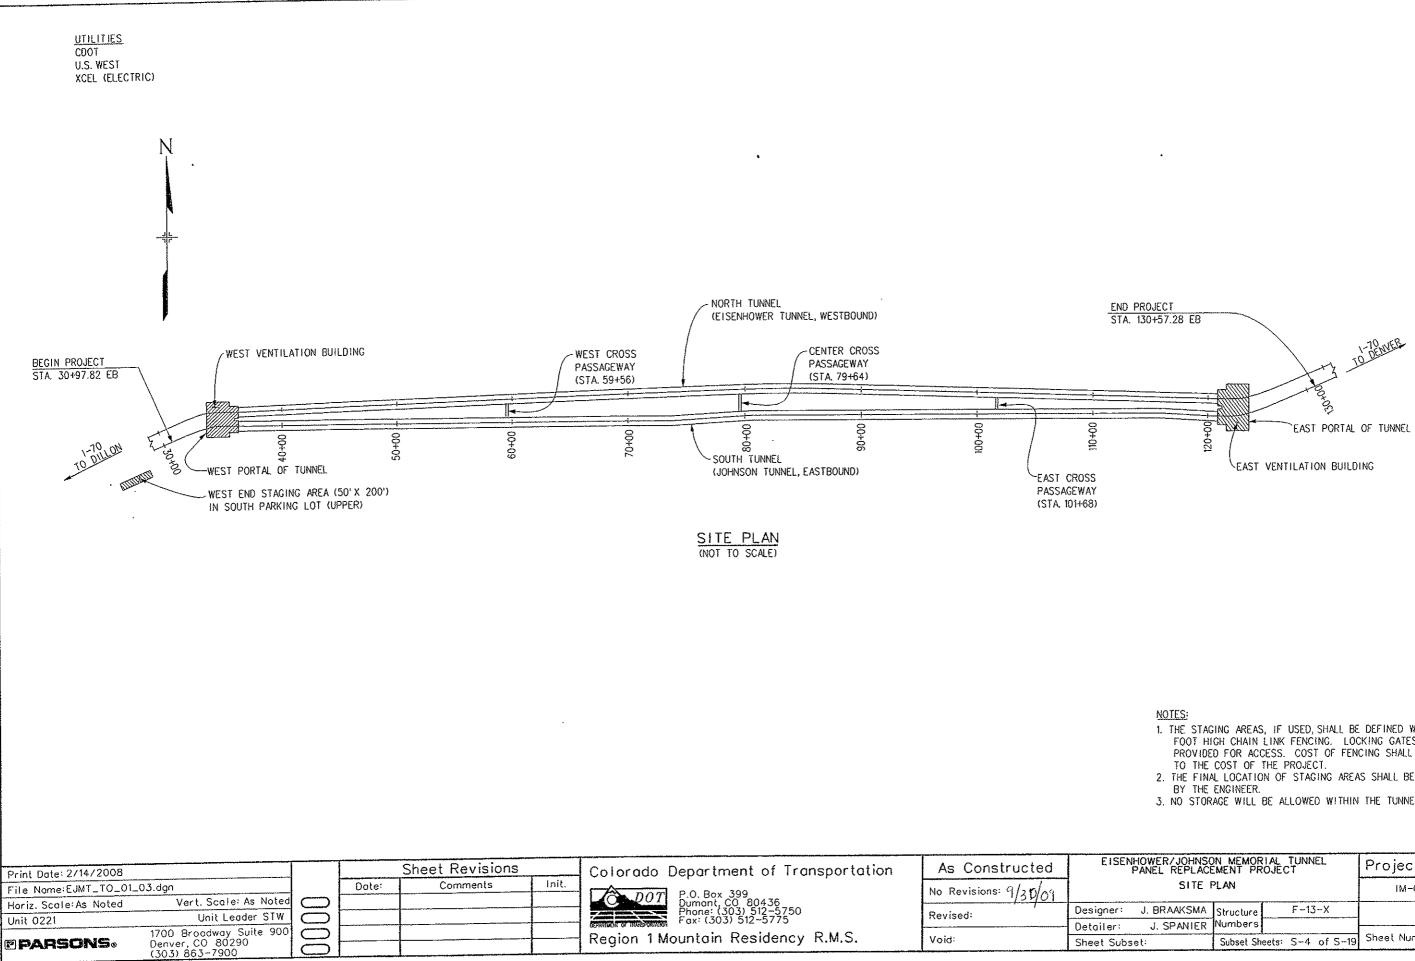



- 1. THE STAGING AREAS, IF USED, SHALL BE DEFINED WITH EIGHT FOOT HIGH CHAIN LINK FENCING. LOCKING GATES SHALL BE PROVIDED FOR ACCESS. COST OF FENCING SHALL BE INCIDENTAL
- 2. THE FINAL LOCATION OF STAGING AREAS SHALL BE APPROVED
- 3. NO STORAGE WILL BE ALLOWED WITHIN THE TUNNEL FACILITIES.


SENHOWER/JOHNSO PANEL REPLACE	N MEMOR	Project No./Code		
SITE	PLAN		IM-0703-322	
er: J. BRAAKSMA	Structure	F-13-X	16102	
r: J. SPANIER	Numbers			
Subset:	Subset Sh	eets: S-4 of S-19	Sheet Number 6	

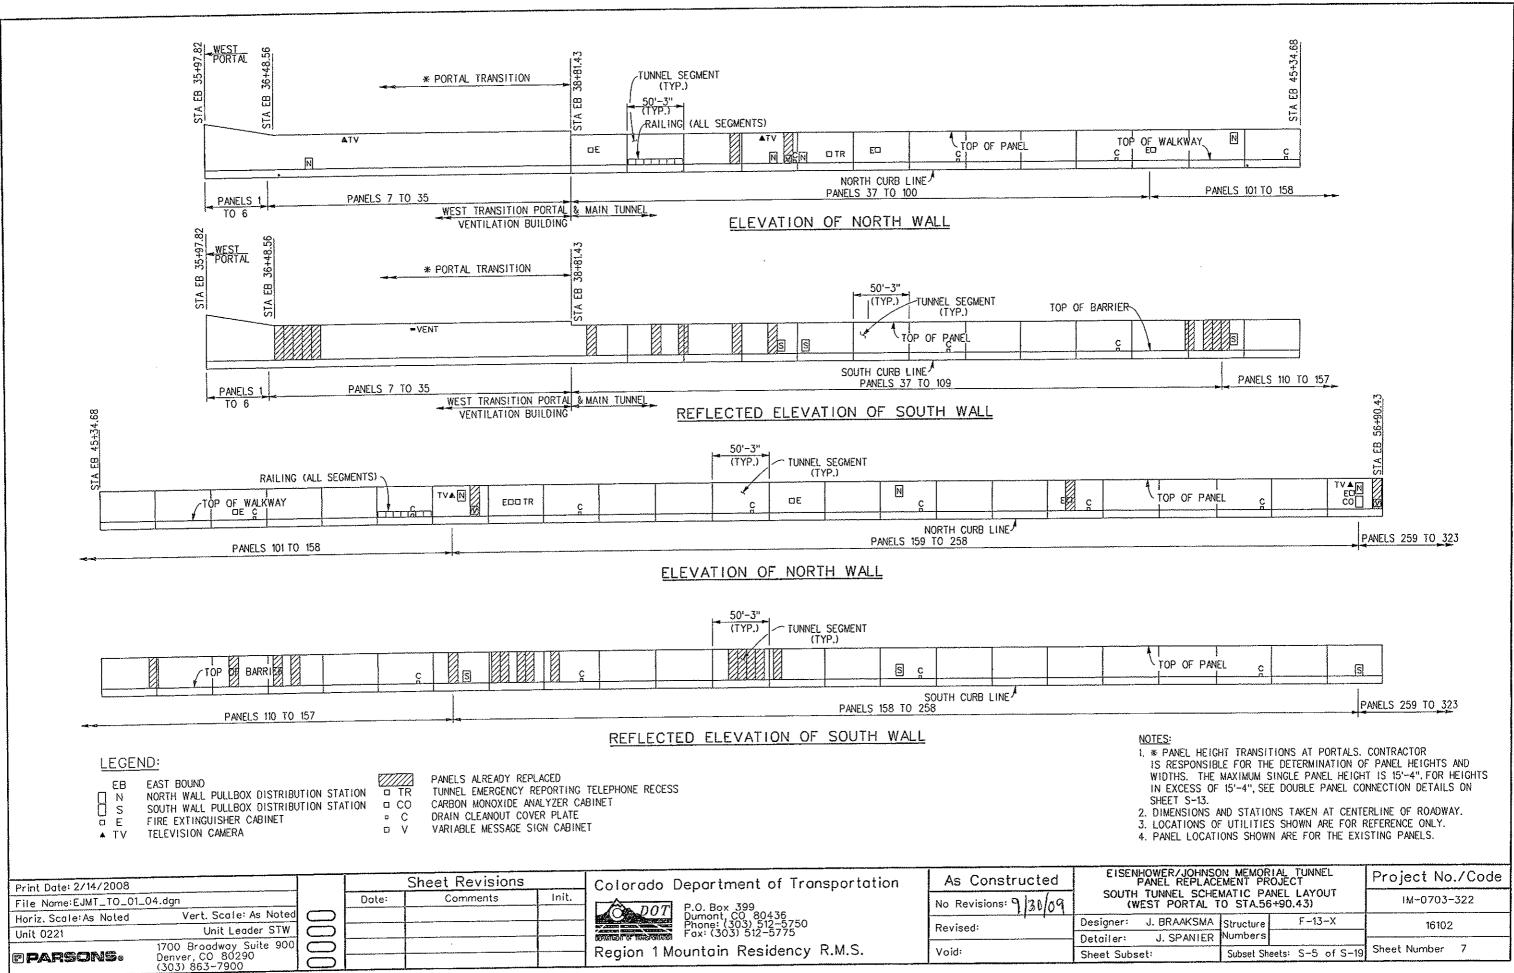


J. BRAAKSMA	Structure	F	-13-X		16102	
J. SPANIER	Numbers	_				
oset:	Subset Sh	eets: S	-5 of	S-19	Sheet Number	7

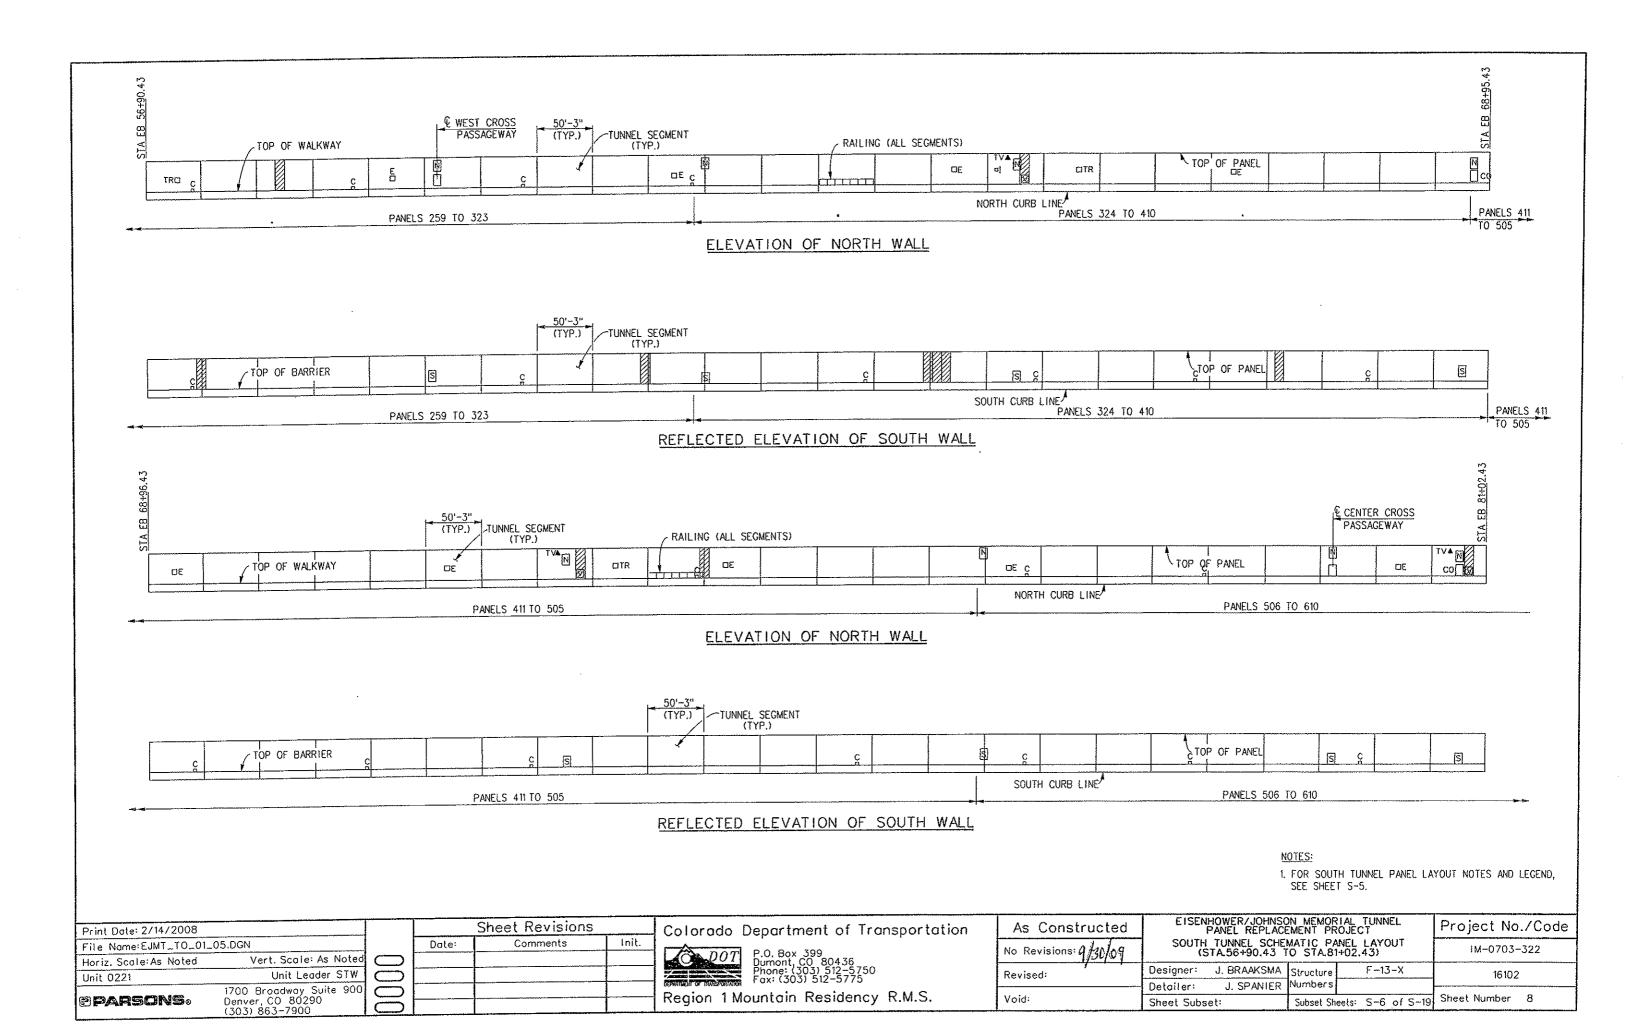

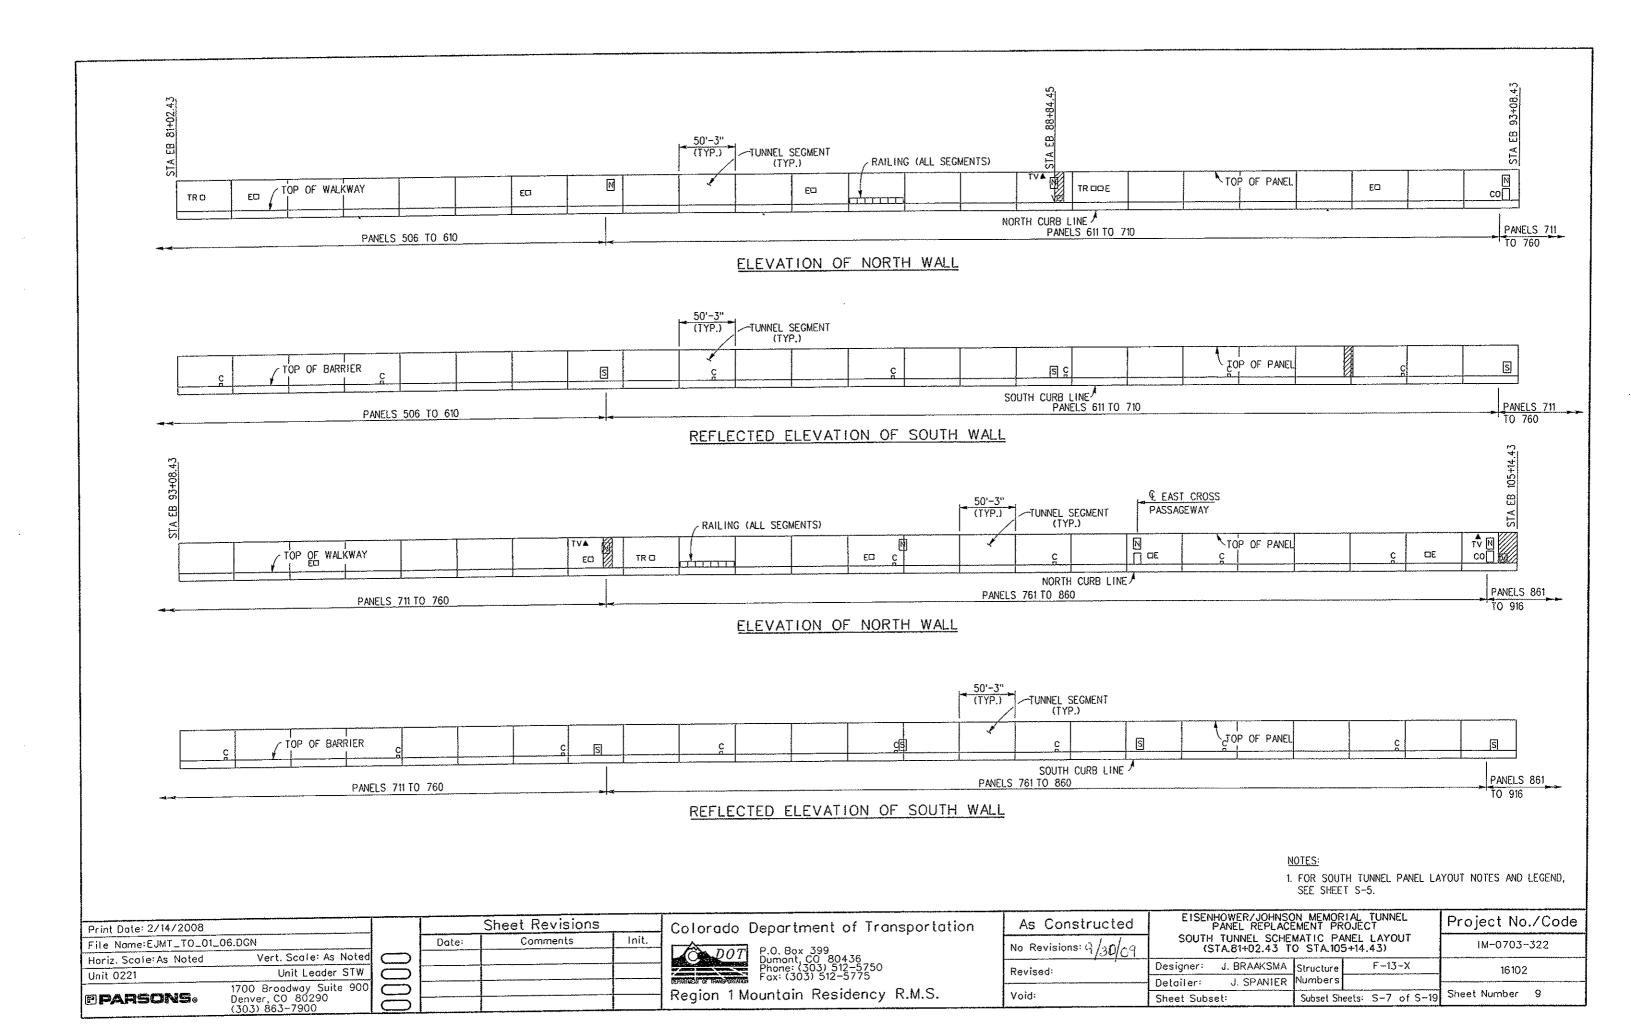

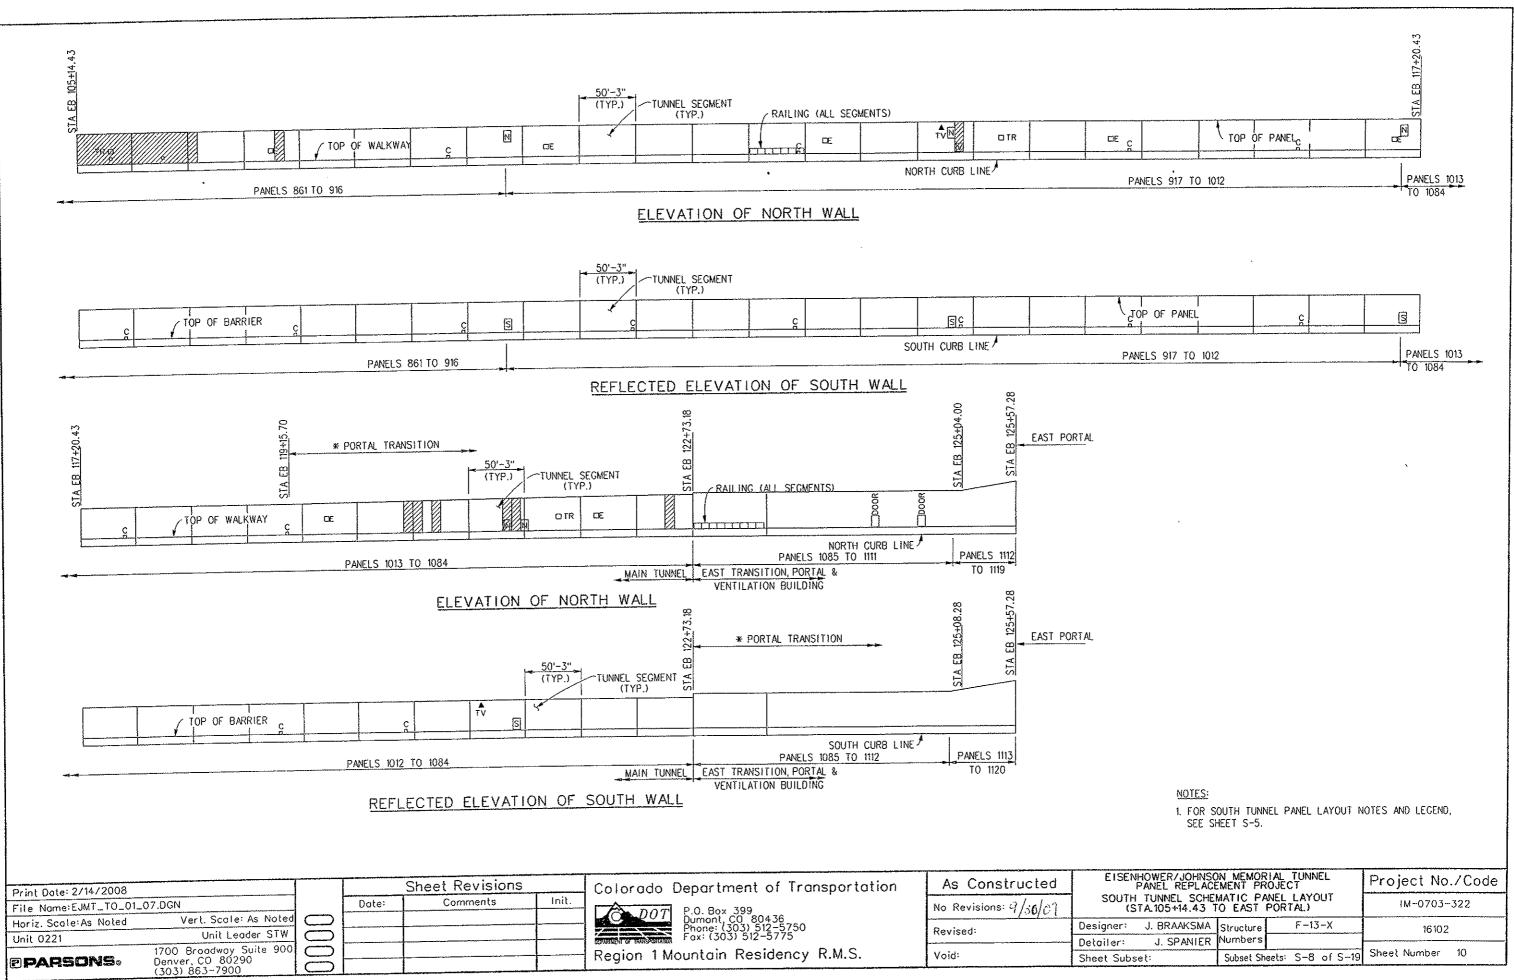


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·· J. SPANIER	Numbers				
ubset:	Subset Sh	eels: S-8	of S-19	Sheet Number	10

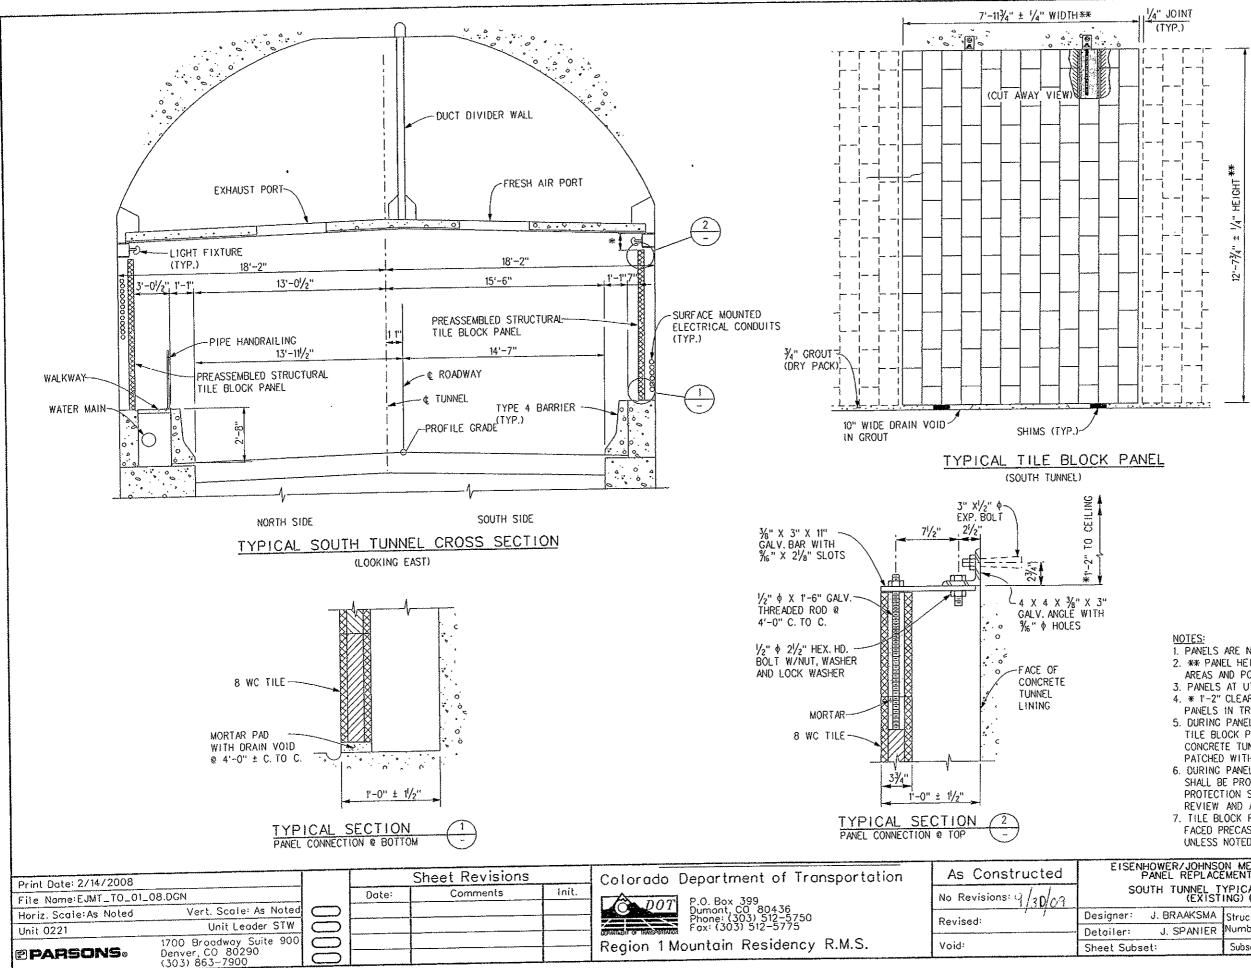

- 1. PANELS ARE NORMAL TO ROADWAY PROFILE GRADE.
- 2. ** PANEL HEIGHTS VARY IN TRANSITION
- AREAS AND PORTALS.
- 3. PANELS AT UTILITY BLOCKOUTS VARY.
- 4. * 1'-2" CLEARANCE TYPICAL. LIGHTS ARE MOUNTED ON PANELS IN TRANSITION AREAS.
- 5. DURING PANEL REMOVAL, ALL ANCHOR BOLTS FOR EXISTING TILE BLOCK PANELS SHALL BE CUT OFF TO 1/4" BELOW CONCRETE TUNNEL LINING AND THE HOLE SHALL BE PATCHED WITH EPOXY GROUT.
- 6. DURING PANEL REMOVAL, THE WALKWAY AND BARRIER SHALL BE PROTECTED FROM DAMAGE. THE METHOD OF PROTECTION SHALL BE SUBMITTED TO THE ENGINEER FOR REVIEW AND APPROVAL.
- 7. TILE BLOCK PANELS THAT HAVE BEEN REPLACED WITH TILE FACED PRECAST CONCRETE PANELS SHALL BE LEFT IN PLACE UNLESS NOTED OTHERWISE.

ENHOWER/JOHNSO	N MEMOR	Project No./Code		
SOUTH TUNNEL T	YPICAL S ING) (1)	ECTIONS	IM-0703-322	
: J. BRAAKSMA			16102	
: J. SPANIER				
ubset:	Subset She	eets: S-9 of S-19	Sheet Number 11	

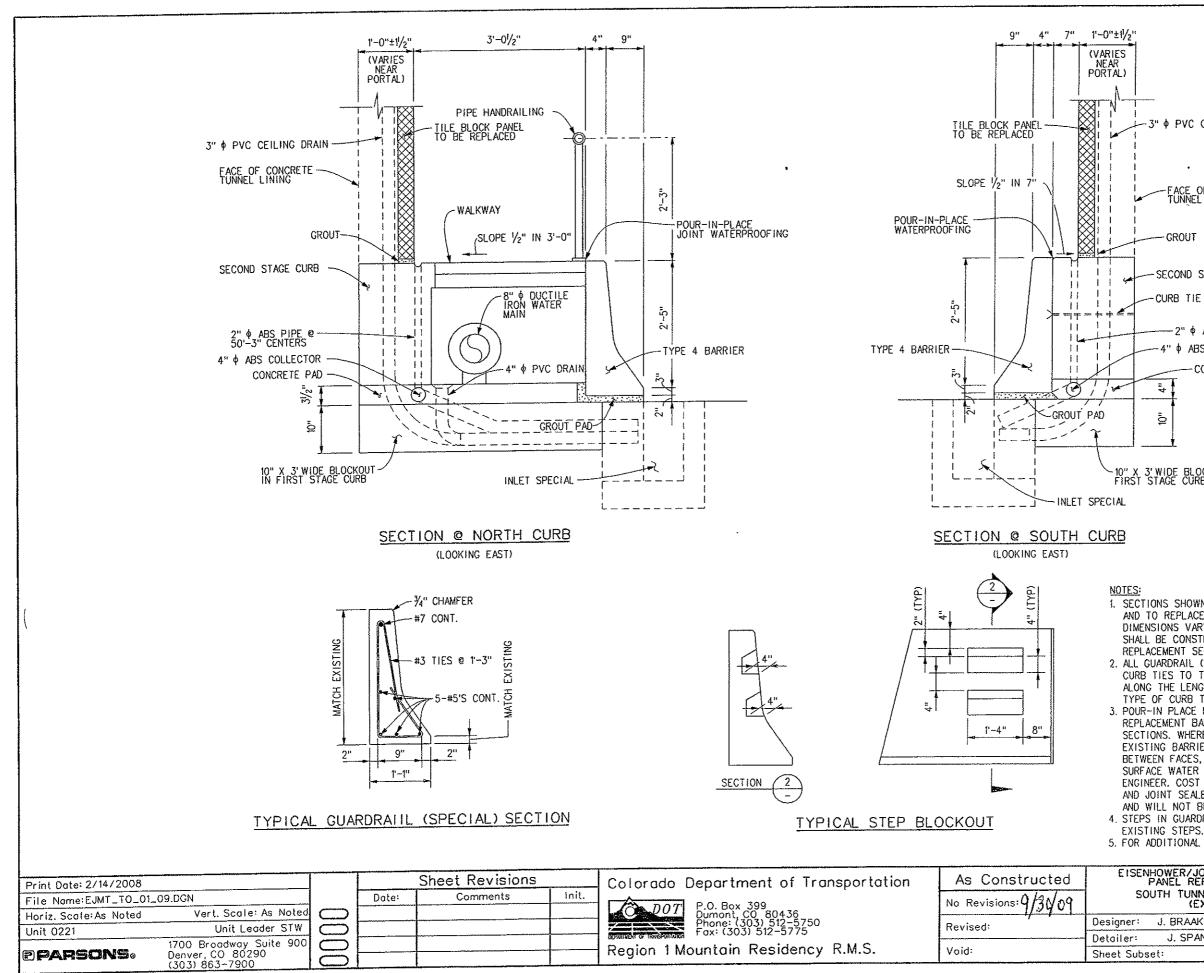

ENHOWER/JOHNSO PANEL REPLACE		Project No./Code			
SOUTH TUNNEL T	YPICAL SE NG) (11)	CTIONS	IM-0703-	·322	
: J. BRAAKSMA	Structure	F –13 – X	16102		
J. SPANIER					
bset: Subset Sheets: S-10 of S-19			Sheet Number 12		

5. FOR ADDITIONAL NOTES SEE SHEET S-9.

SHALL BE CONSTRUCTED COMPLETE WITH HARDWARE TO JOIN THE REPLACEMENT SECTIONS TO THE STRUCTURE BEHIND THEM. 2. ALL GUARDRAIL (SPECIAL) REINFORCING SHALL BE EPOXY COATED REINFORCING. CURB TIES TO THE TUNNEL LINING SHALL BE AT MAXIMUM 4 FOOT INTERVALS ALONG THE LENGTH OF THE BARRIER. THE CONTRACTOR SHALL PROPOSE THE TYPE OF CURB THE TO BE USED, FOR REVIEW AND APPROVAL BY THE ENGINEER. 3. POUR-IN PLACE MASTIC JOINT WATERPROOFING SHALL BE USED AT TOP OF REPLACEMENT BARRIER [GUARDRAIL (SPECIAL)] AS SHOWN IN EXISTING SECTIONS, WHERE REPLACEMENT BARRIER (GUARDRAIL (SPECIAL)] ABUTS EXISTING BARRIER, 1/2" EXPANSION JOINT MATERIAL SHALL BE PLACED BETWEEN FACES, RECESSED 1/2", AND SEALED AGAINST INTRUSION OF SURFACE WATER BY A WATERPROOF JOINT SEALER APPROVED BY THE ENGINEER. COST OF JOINT WATERPROOFING, EXPANSION JOINT MATERIAL, AND JOINT SEALER SHALL BE INCLUDED IN THE COST OF GUARDRAIL (SPECIAL) AND WILL NOT BE PAID FOR SEPARATELY. 4. STEPS IN GUARDRAIL (SPECIAL) SHALL BE FORMED TO MATCH LOCATION OF

1. SECTIONS SHOWN AT NORTH AND SOUTH CURB APPLY TO EXISTING BARRIER AND TO REPLACEMENT BARRIER [GUARDRAIL (SPECIAL)]. AS-CONSTRUCTED DIMENSIONS VARY SLIGHTLY FROM THOSE SHOWN. GUARDRAIL (SPECIAL)

10" X 3' WIDE BLOCKOUT IN FIRST STAGE CURB

E.

CURB THE TO TUNNEL LINING

4" \$ ABS COLLECTOR

CONCRETE PAD


-2" \$ ABS PIPE @ 50'-3" CENTERS

-SECOND STAGE CURB

GROUT

FACE OF CONCRETE TUNNEL LINING

3" & PVC CEILING DRAIN

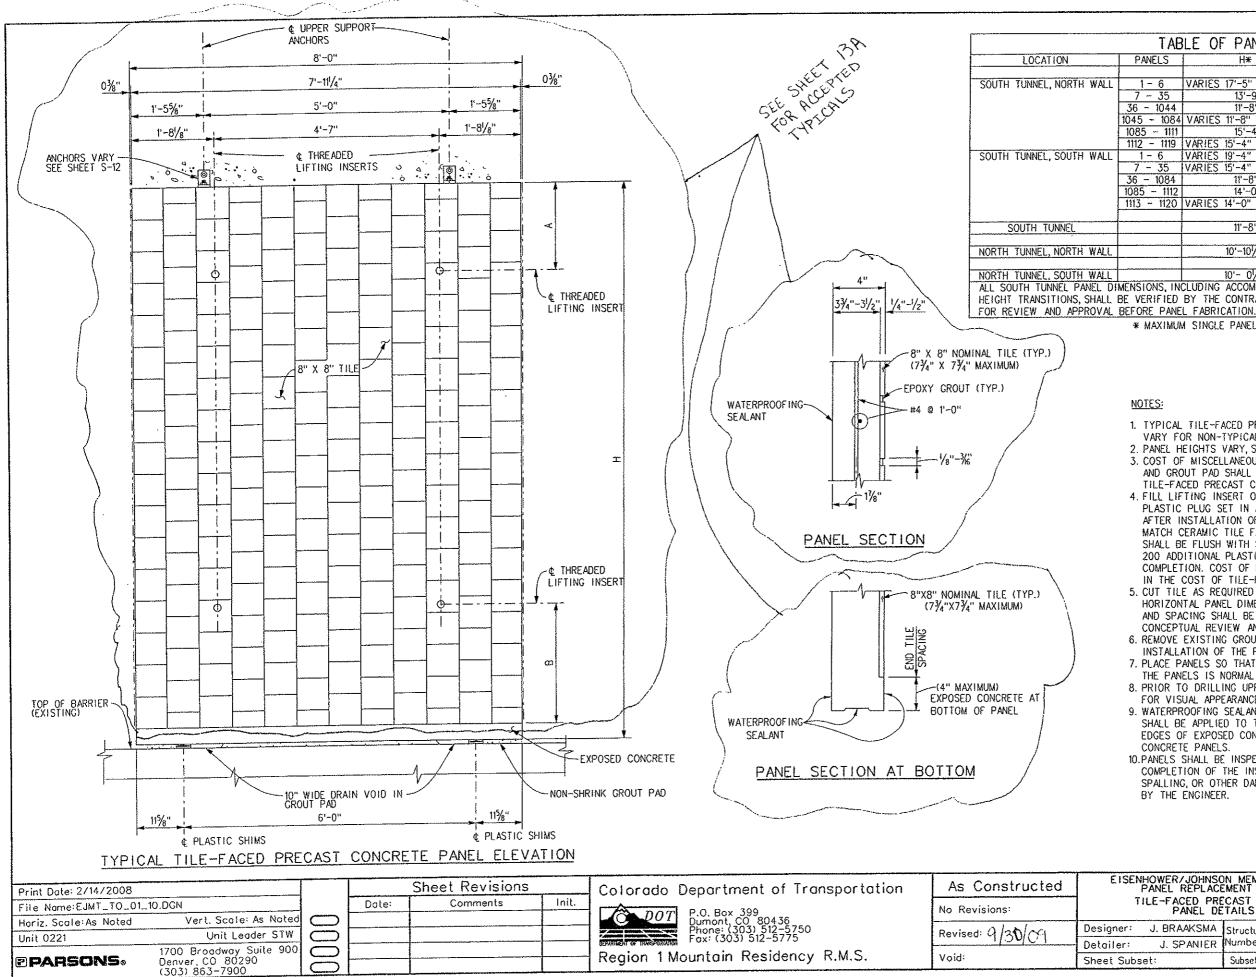


TAB	ILE OF PANEL HEI	GHTS						
PANELS	H *	A	В	COMMENTS				
				1				
1-6	VARIES 17'-5" TO 13'-9"	2'-10"	2'-10"	PORTAL				
7 - 35	13'-9"	2'-10"	2'-10"					
36 - 1044	11'-8"	1'~10"	2'-6"	INTERIOR ZONE				
045 - 1084	VARIES 11'-8" TO 13'-0"	1'-10"	2'-6"	INTERIOR ZONE				
1085 - 1111	15'-4''	2'-10"	2'-10"	TRANSITION AREA				
1112 - 1119	VARIES 15'-4" TO 20'-8"	2'-10"	2'-10"	PORTAL				
1-6	VARIES 19'-4" TO 15'-4"	2'-10"	2'-10"	PORTAL				
7 - 35	VARIES 15'-4" TO 14'-0"	2'-10"	2'10"	TRANSITION AREA				
36 - 1084	11'~8"	1'-10"	2'~6"	INTERIOR ZONE				
1085 - 1112	14'-0"	2'-10"	2'10"	TRANSITION AREA				
1113 - 1120	VARIES 14'~0" TO 18'-8"	2'~10"	2'-10"	PORTAL				
	11'-8"	1'~10"	2'-6"	20 TOTAL SPARE PANELS				
		_						
	10'-101/2"	1'-10"	2'-6"	10 TOTAL SPARE PANELS				
	10'- 01/2"	1'-10"	2'-6"	10 TOTAL SPARE PANELS				
ENSIONS, INC	CLUDING ACCOMMODATIONS	S FOR A	LL OPEN	INGS AND				
E VERIFIED	BY THE CONTRACTOR AND) SUBMIT	ITED TO	THE ENGINEER				

* MAXIMUM SINGLE PANEL HEIGHT SHALL BE 15'-4".


NOTES:


- 1. TYPICAL TILE-FACED PRECAST CONCRETE PANEL SHOWN, DIMENSIONS VARY FOR NON-TYPICAL TILE-FACED PRECAST CONCRETE PANELS.
- 2. PANEL HEIGHTS VARY, SEE TABLE OF PANEL HEIGHTS FOR DETAILS.
- 3. COST OF MISCELLANEOUS STEEL, SHIMS, REINFORCEMENT,
- AND GROUT PAD SHALL BE INCLUDED IN THE COST OF TILE-FACED PRECAST CONCRETE PANELS
- 4. FILL LIFTING INSERT OPENING WITH SCREW-IN TYPE PLASTIC PLUG SET IN AN APPROVED SILICONE SEALANT AFTER INSTALLATION OF PANEL. PLUG COLOR SHALL MATCH CERAMIC TILE FACE COLOR. SURFACE OF PLASTIC PLUG SHALL BE FLUSH WITH SURFACE OF PANEL FACE. PROVIDE 200 ADDITIONAL PLASTIC PLUGS PRIOR TO PROJECT COMPLETION, COST OF PLASTIC PLUGS SHALL BE INCLUDED IN THE COST OF TILE-FACED PRECAST CONCRETE PANELS.
- 5. CUT TILE AS REQUIRED TO MATCH BOTH VERTICAL AND HORIZONTAL PANEL DIMENSIONS. FINAL TILE LAYOUT AND SPACING SHALL BE SUBMITTED TO THE ENGINEER FOR CONCEPTUAL REVIEW AND APPROVAL
- 6. REMOVE EXISTING GROUT PAD AT PANEL BASE PRIOR TO INSTALLATION OF THE PANEL.
- 7. PLACE PANELS SO THAT THE CENTERLINE OF THE JOINT BETWEEN THE PANELS IS NORMAL TO THE ROADWAY GRADE.
- 8. PRIOR TO DRILLING UPPER ANCHORS, SET PANELS AND ADJUST FOR VISUAL APPEARANCE.
- 9. WATERPROOFING SEALANT (SILOXANE-BASED OR APPROVED EQUAL) SHALL BE APPLIED TO THE BACKFACE, TOP, BOTTON, AND EDGES OF EXPOSED CONCRETE SURFACES OF TILE-FACED PRECAST CONCRETE PANELS.
- 10. PANELS SHALL BE INSPECTED BY THE ENGINEER UPON THE COMPLETION OF THE INSTALLATION. PANELS WITH CRACKING, SPALLING, OR OTHER DAMAGE SHALL BE REPLACED AS DIRECTED BY THE ENGINEER.


ENHOWER/JOHNSO PANEL REPLAC			Project No./Code
TILE-FACED PRI PANEL DE	CAST CO	NCRETE	IM-0703-322
: J. BRAAKSMA	Structure	F-13-X	16102
J. SPANIER			
ubset:	Subset She	ets: S-11 of S-19	Sheet Number 13

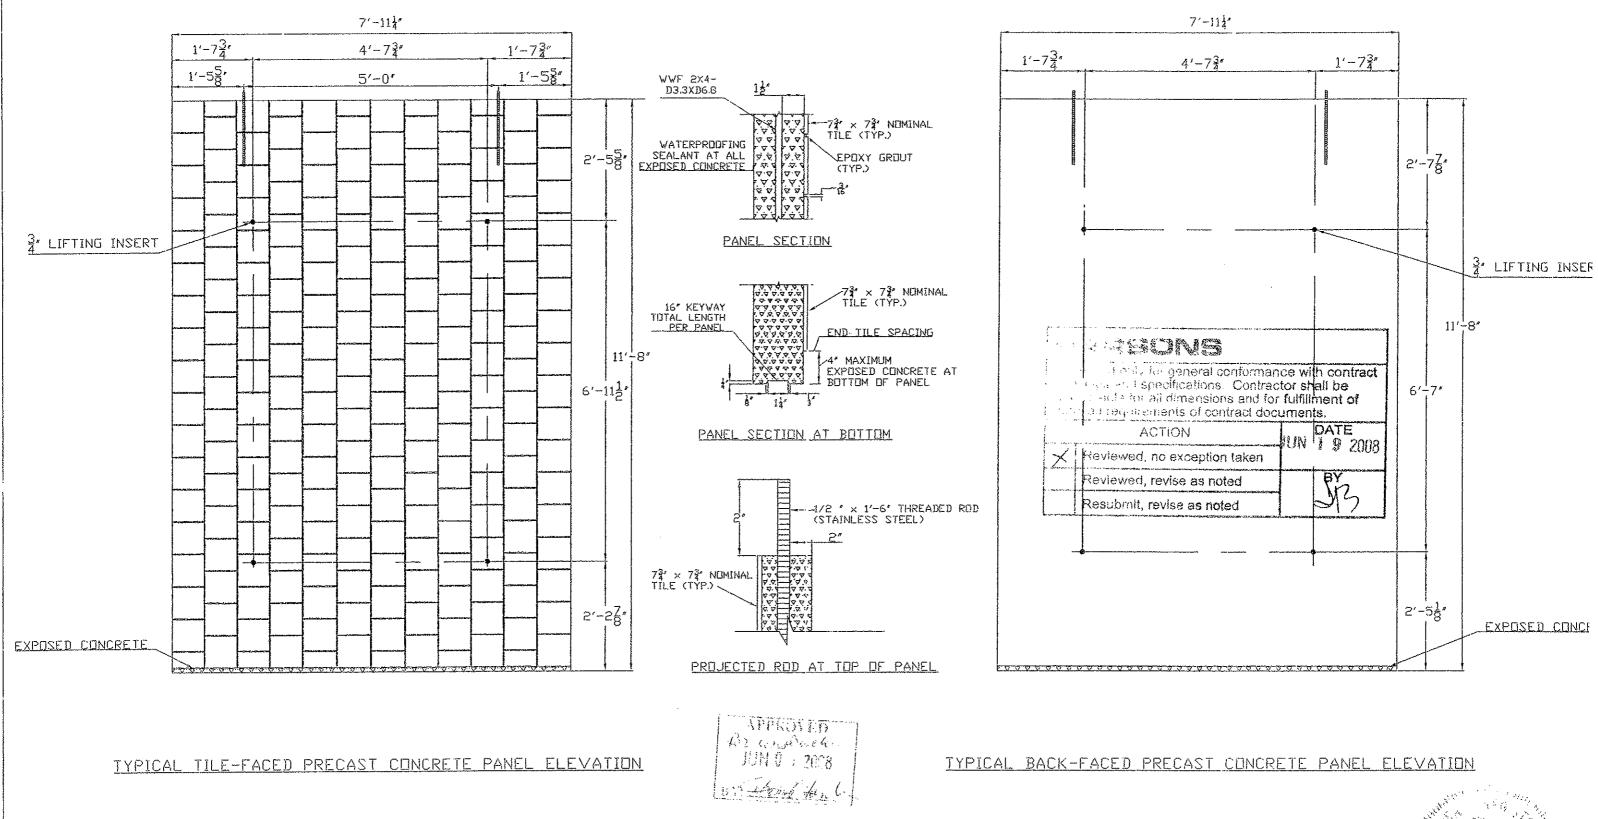



A	Scale Details		Sheet Revisions		EISENHOWER/JOHNSON MEMORIAL TUNNEL PANEL REPLACEMENT PROJECT	Proje
	Horiz, Scale: As Noted -	Date:	Comments	Init.	TILE-FACED PRECAST CONCRETE PANEL DETAILS	IM-07
	Horiz, scale, as noted				Engineer: Norman Kirk	Construction
	Vert. Scale: As Noted -				Brafter: Josh Chun	Sheet Number

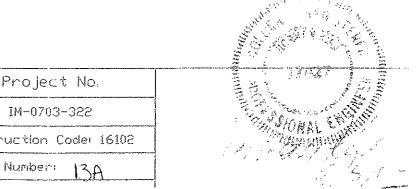

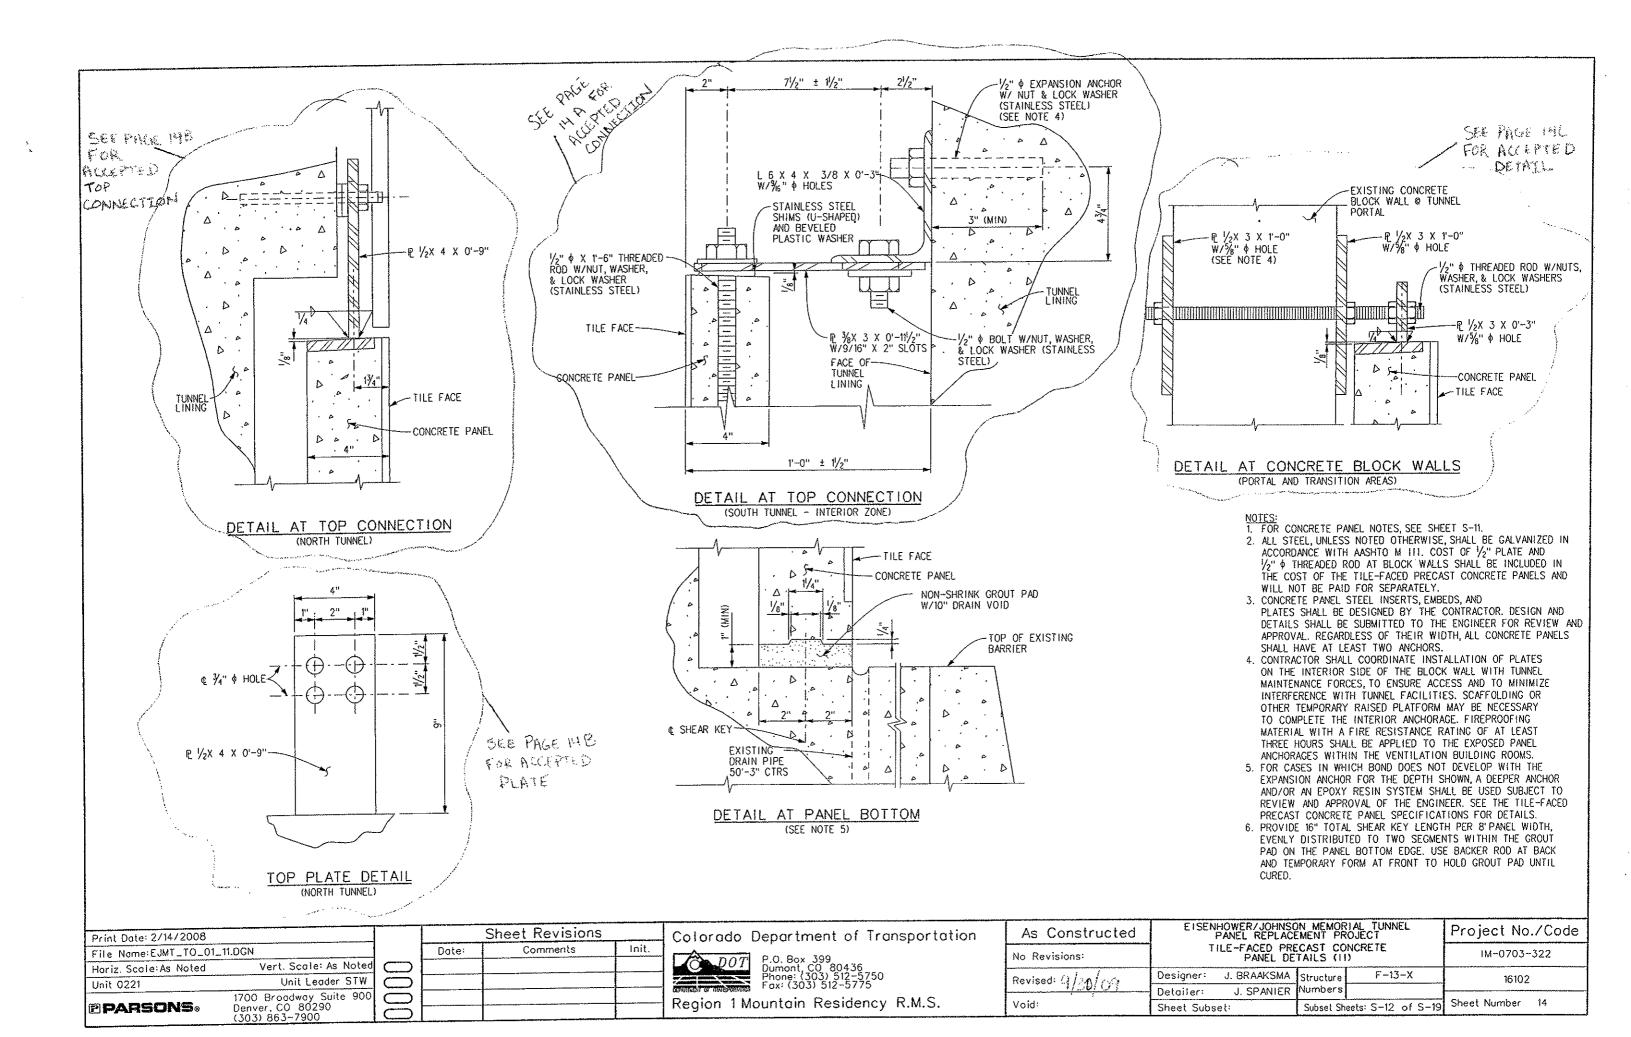

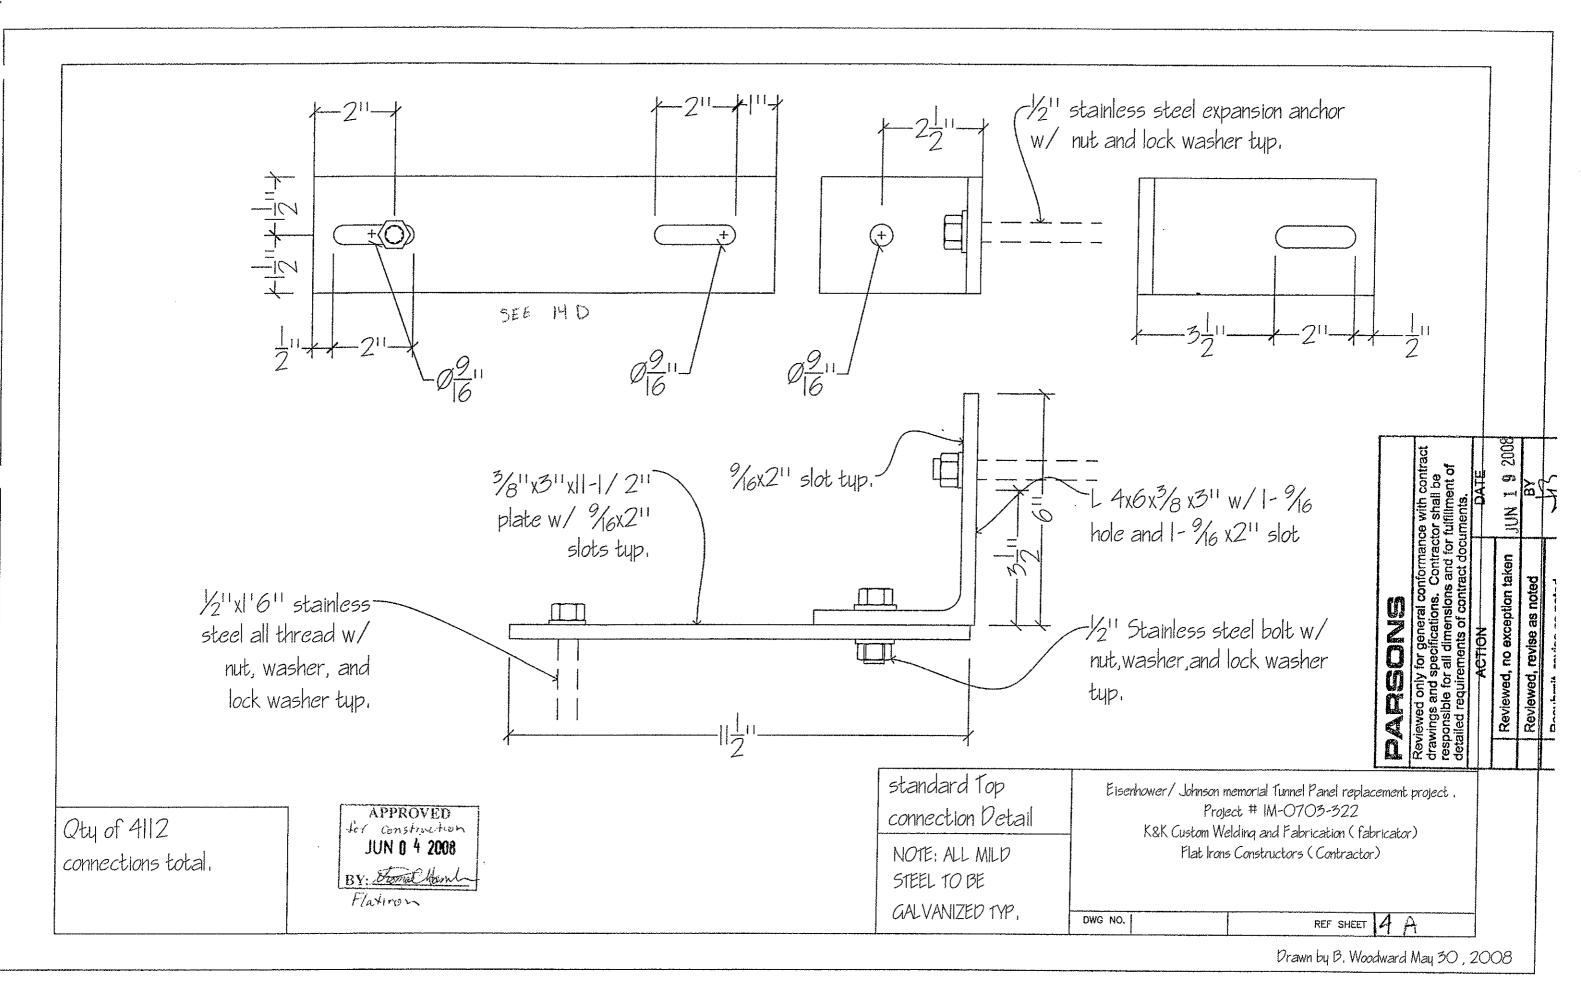


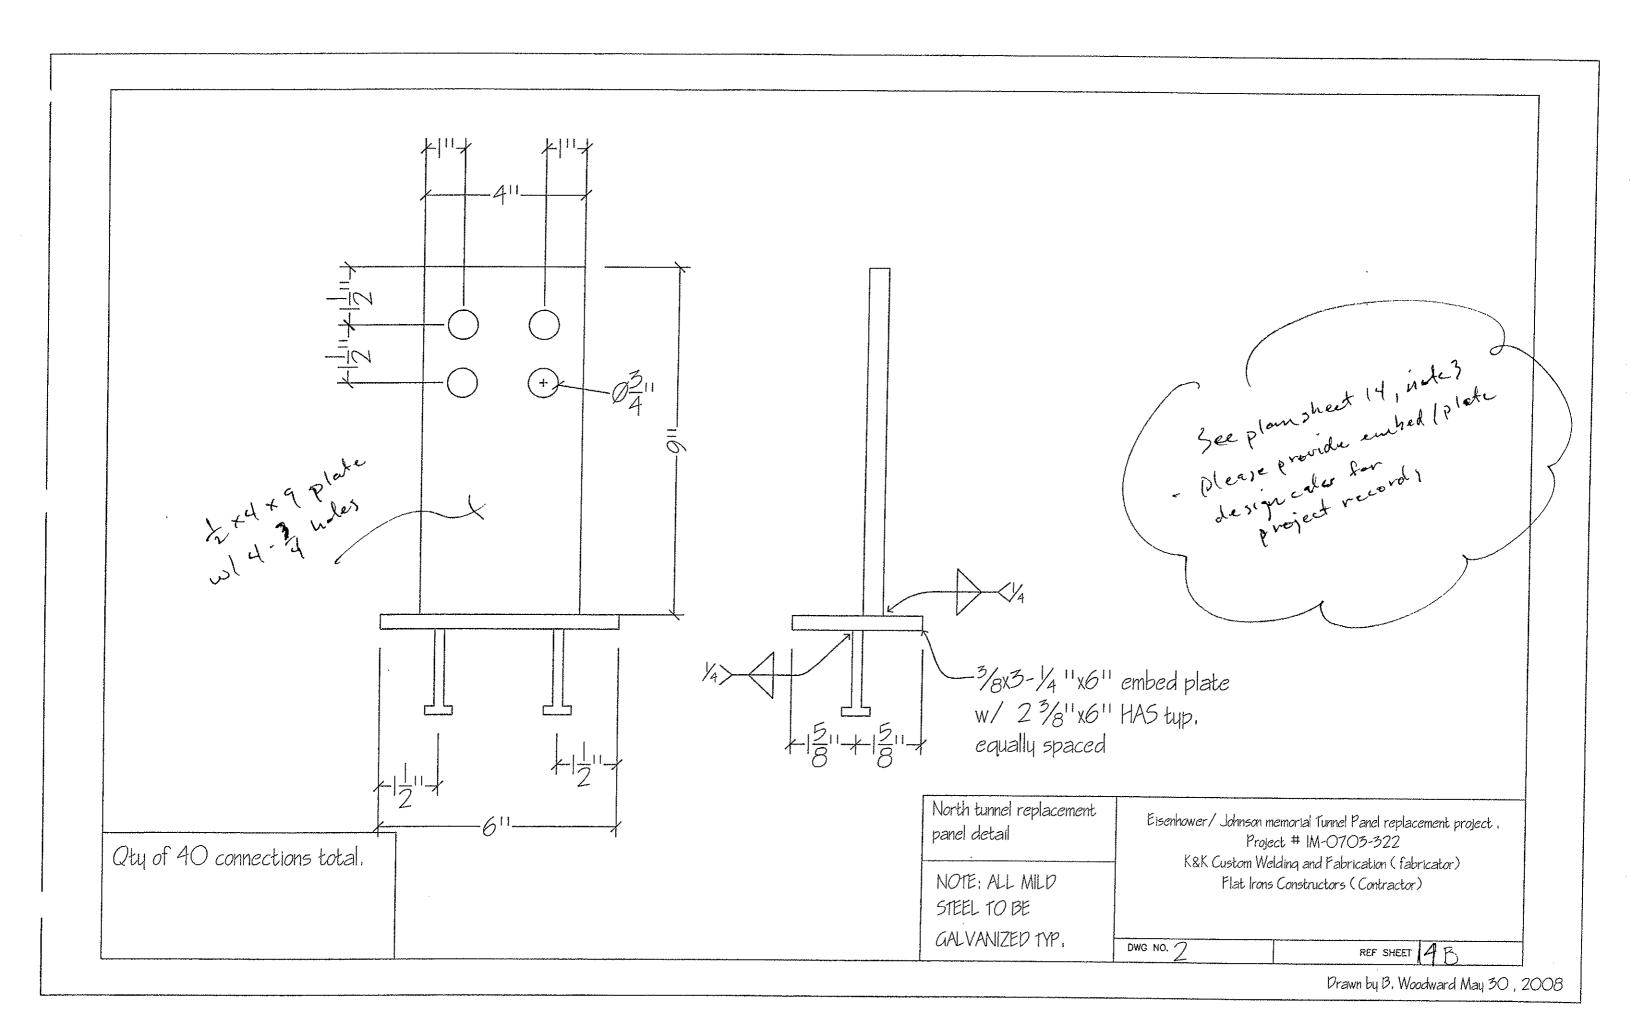

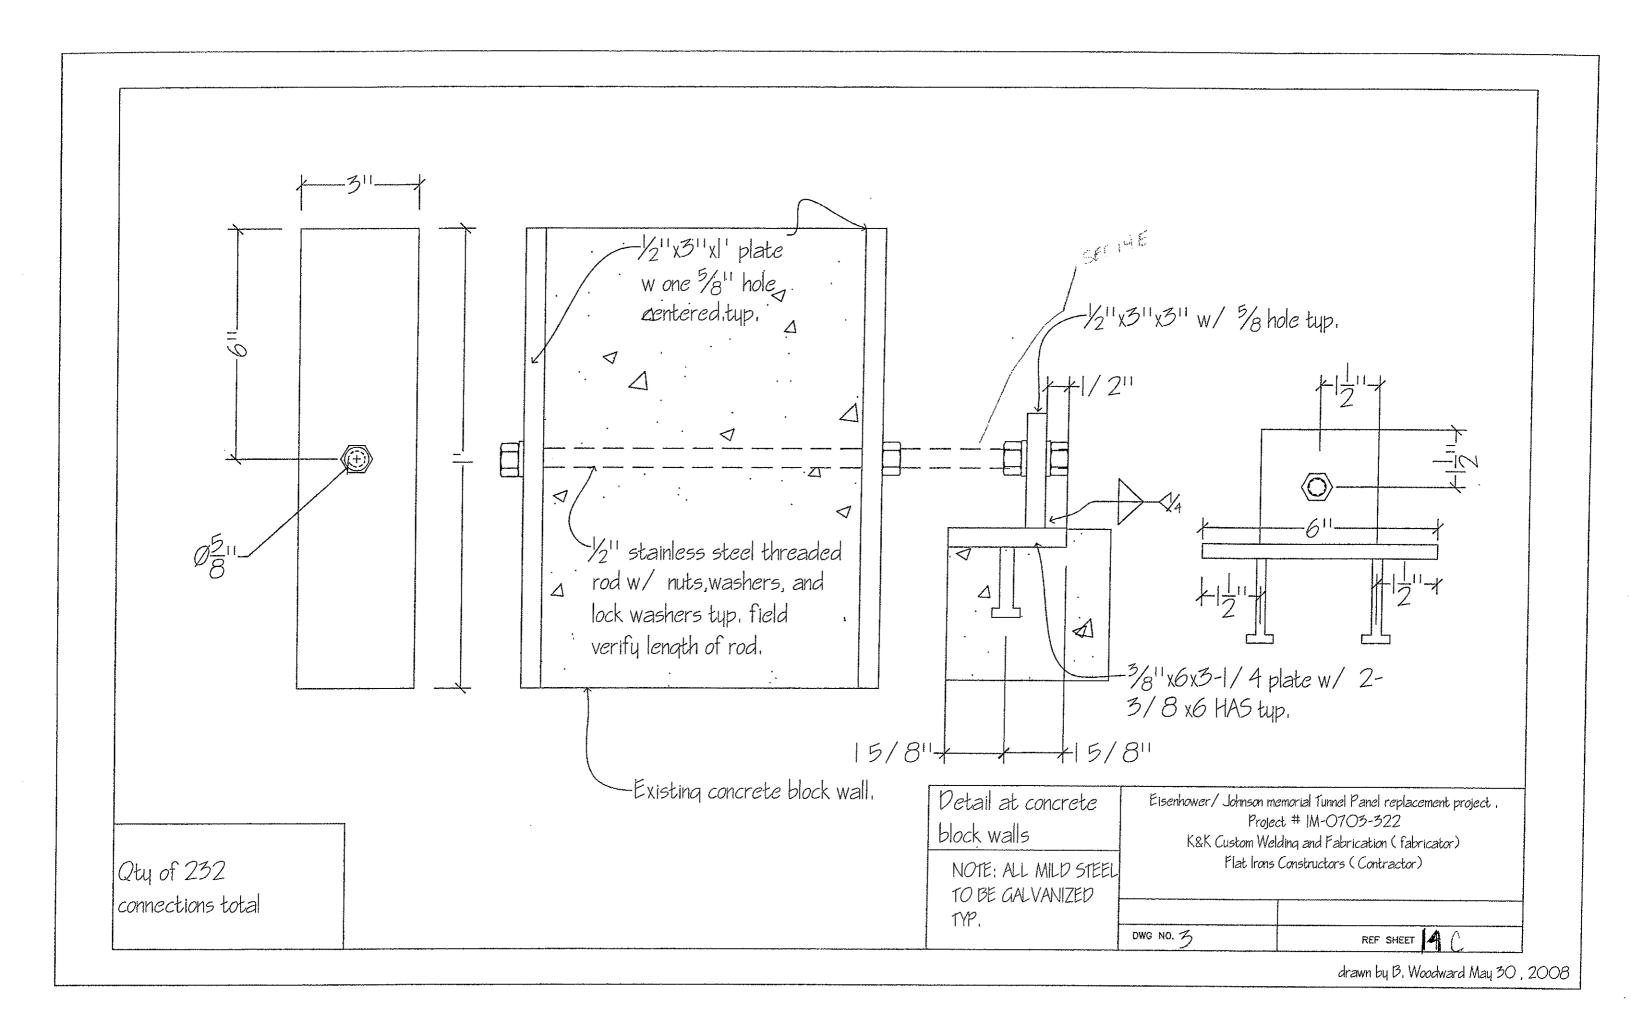


-1/2¹¹ x 3¹¹ x| ' plate w/ 5/8¹¹ hole . V^{III} stainless steel nuts, washers, and lock washers tup. threaded rod w, 119 tup. ()0 21-Ш ſГЛ Ø -<u>[</u>0 117 Ш Ш Ш E E Ø 5 -<u>|</u>0 % x 2" slot typ

	Stacked panel Elsenh I connection detail	tions total NOTE: AL MILD STEEL K&K Custom Welding and Fabrication (fabricator) TO BE GALVANIZED Flat Irons Constructors (Contractor)	DWG NO. 4 REF SHEET	Drawn by B. Woodward May 30 , 2008
//" xl"6" stainless steel threaded rod w/ nut, washer,	and lock washer tup.	116 Connections total		

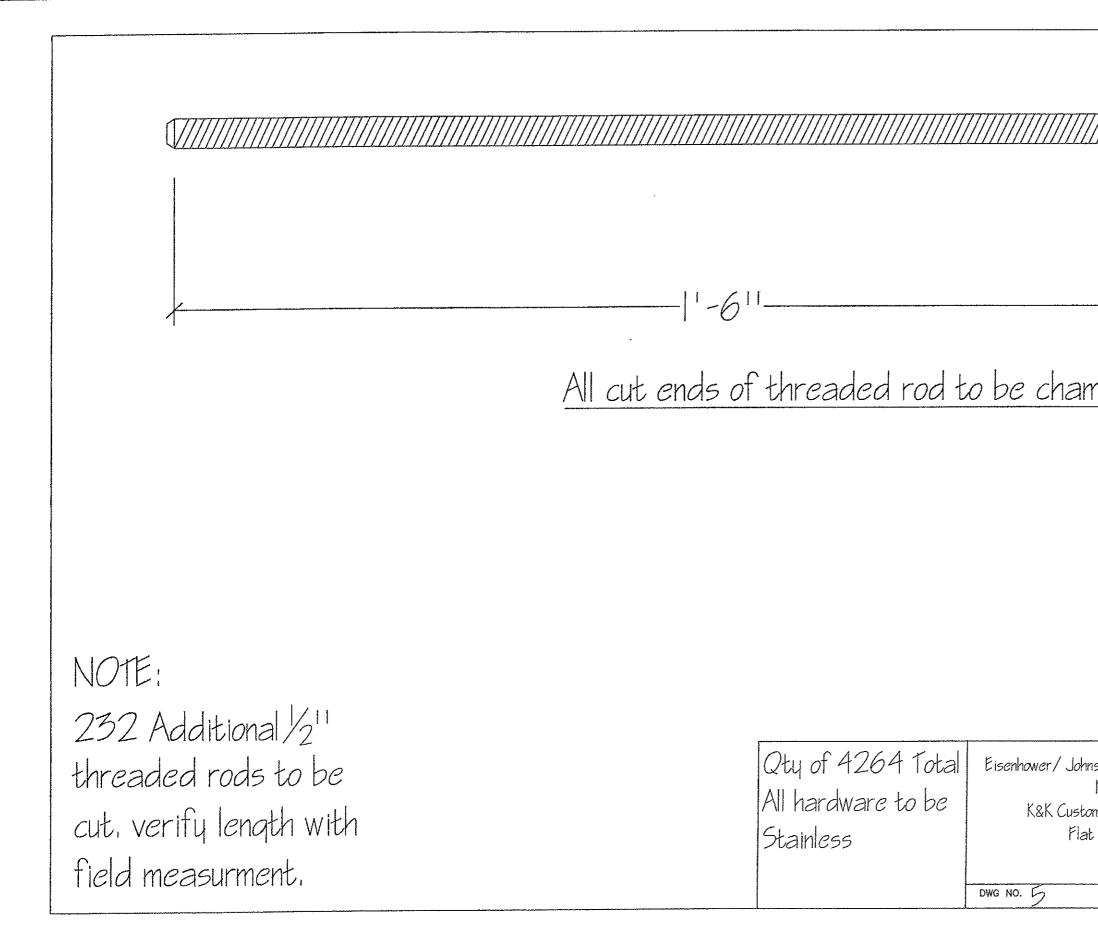

nfered typ,	
son memorial Tunnel Panel replacement project . Project # IM-0703-322	
n Welding and Fabrication (fabricator) Irons Constructors (Contractor)	
REF SHEET 4	
Drawn by B. Woodward May 30 , 2008	

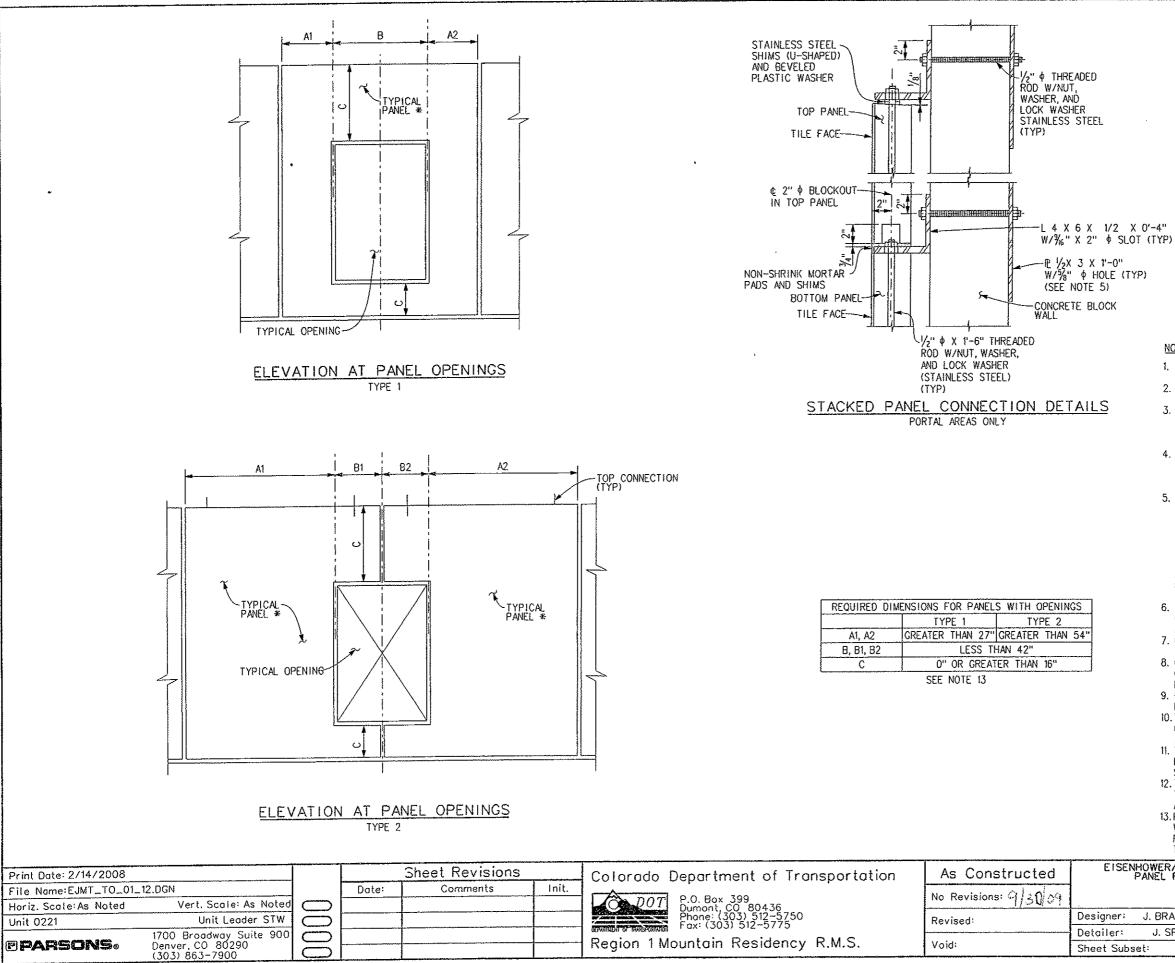


	15 5-11 ANU 5-12
ALL STEEL, UNLESS OTHERWISE NOTED	, SHALL BE
GALVANIZED IN ACCORDANCE WITH AA	SHTO M III.
3. COST OF 1/2" PLATE AND 1/2" THREAD	EU ROD AI
BLOCK WALLS SHALL BE INCLUDED IN	
OF TILE-FACED PRECAST CONCRETE P	ANELS AND
WILL NOT BE PAID FOR SEPARATELY.	
4. CONCRETE PANEL STEEL INSERTS, EMB	
AND PLATES SHALL BE DESIGNED BY	
DESIGN AND DETAILS SHALL BE SUBMI	
ENGINEER FOR REVIEW AND APPROVAL	
5. CONTRACTOR SHALL COORDINATE INST	ALLATION OF
PLATES ON THE INTERIOR SIDE OF TH	
WITH TUNNEL MAINTENANCE FORCES, T	
AND TO MINIMIZE INTERFERENCE WITH	
SCAFFOLDING OR OTHER TEMPORARY I	
MAY BE NECESSARY TO COMPLETE TH	E INTERIOR
ANCHORAGE, FIREPROOFING MATERIAL	
RESISTANCE RATING OF AT LEAST THE	
BE APPLIED TO THE EXPOSED PANEL A	NCHORAGES WITHIN
THE VENTILATION BUILDING ROOMS.	
6. THE CONTRACTOR IS RESPONSIBLE FO	RALL
CONCRETE PANEL LAYOUTS AND DIMEN	
AT THE UTILITY OPENINGS.	[
7. CONCRETE PANELS MAY BE SAW CUT	IN
THE FIELD. ALL SAW CUTS SHALL BE	FULL DEPTH
8. OPENINGS LESS THAN 3'-O" X 3'-O" M	AY HE SAW
CUT OUT OF THE CONCRETE PANELS A	
NECESSARY.	5
9. * ADJUST WIDTHS OF ADJACENT CONC	PETE DANELS AS
REQUIRED.	NETE FANLES AS
10. THE CONTRACTOR IS RESPONSIBLE FO	
OF TYPE AND LOCATION OF UTILITIES	
INSTALLATION OF CONCRETE PANEL AN	
11. THE REMOVAL AND RESETTING OF ALL	
EXISTING PANELS TO CONCRETE PANEL	15, 15 INCIDENTAL AND
SHALL BE INCLUDED IN THE WORK.	
12. THE REMOVAL AND RESETTING OF UTIL	
TO REMOVE AND REPLACE CONCRETE F	ANELS IS INCIDENTAL
AND SHALL BE INCLUDED IN THE WORK	
13. PANELS THAT DO NOT MEET THESE DI	
WITHIN THE EXISTING PANEL LAYOUT	
PANELS. FOR A LISTING OF SPECIAL F	ANELS, SEE SHEETS S-16
THROUGH S-19.	
NHOWERZJOHNSON MEMORIAL TUNNEL	
NHOWER/JOHNSON MEMORIAL TUNNEL PANEL REPLACEMENT PROJECT	Project No./Code
SPECIAL PANEL	
DETAILS (I)	IM-0703-322
	·
J. BRAAKSMA Structure F-13-X	16102
	1 1
J. SPANIER Numbers	
······································	Sheet Number 15

<u>NOTES</u>

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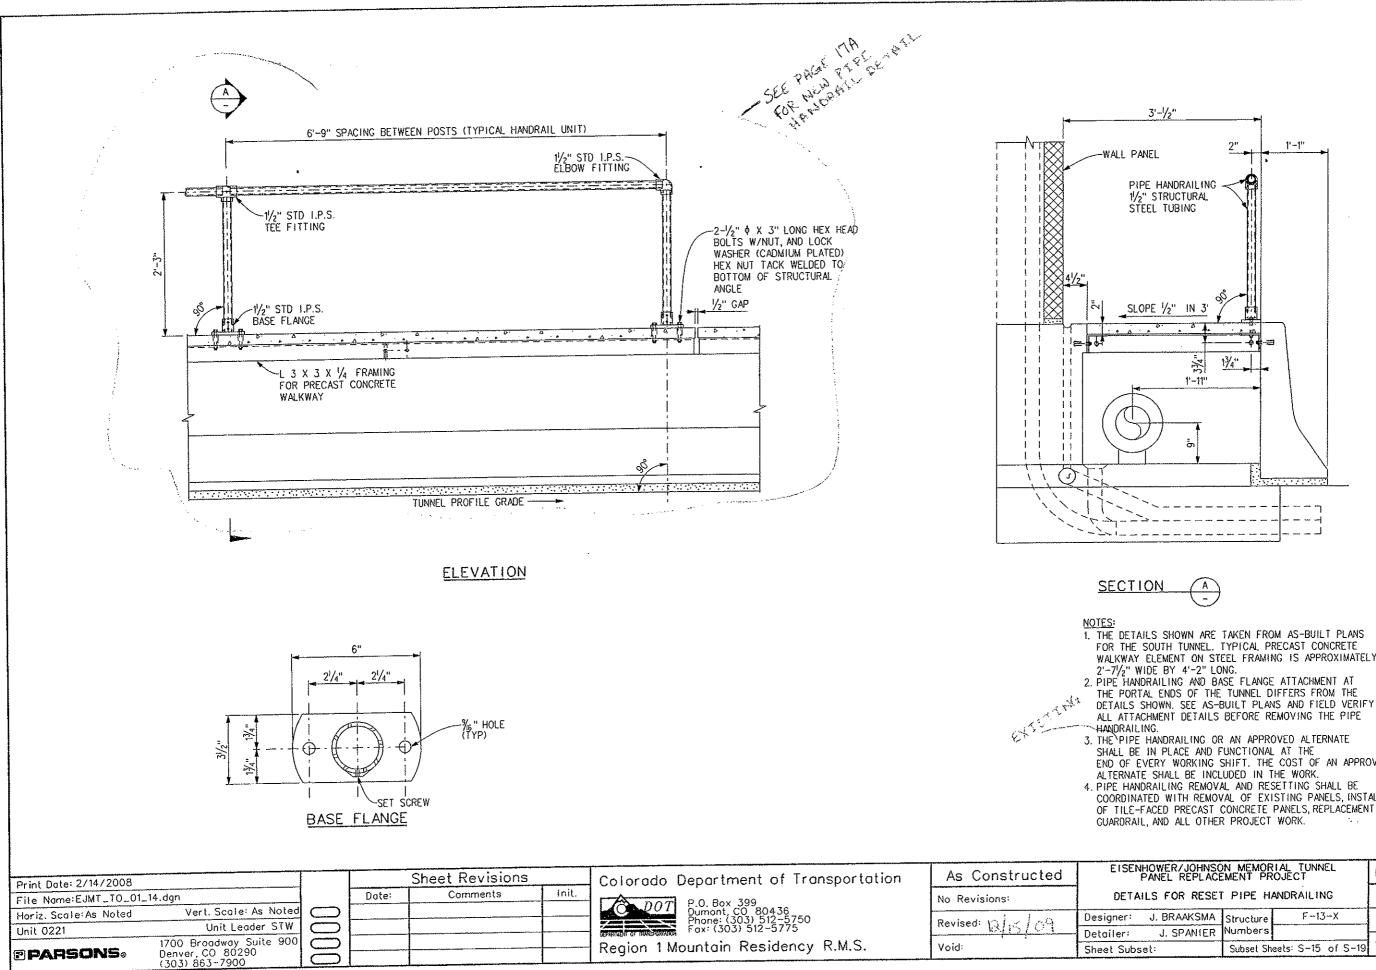
1. FOR ADDITIONAL NOTES AND DETAILS OF TILE-FACED

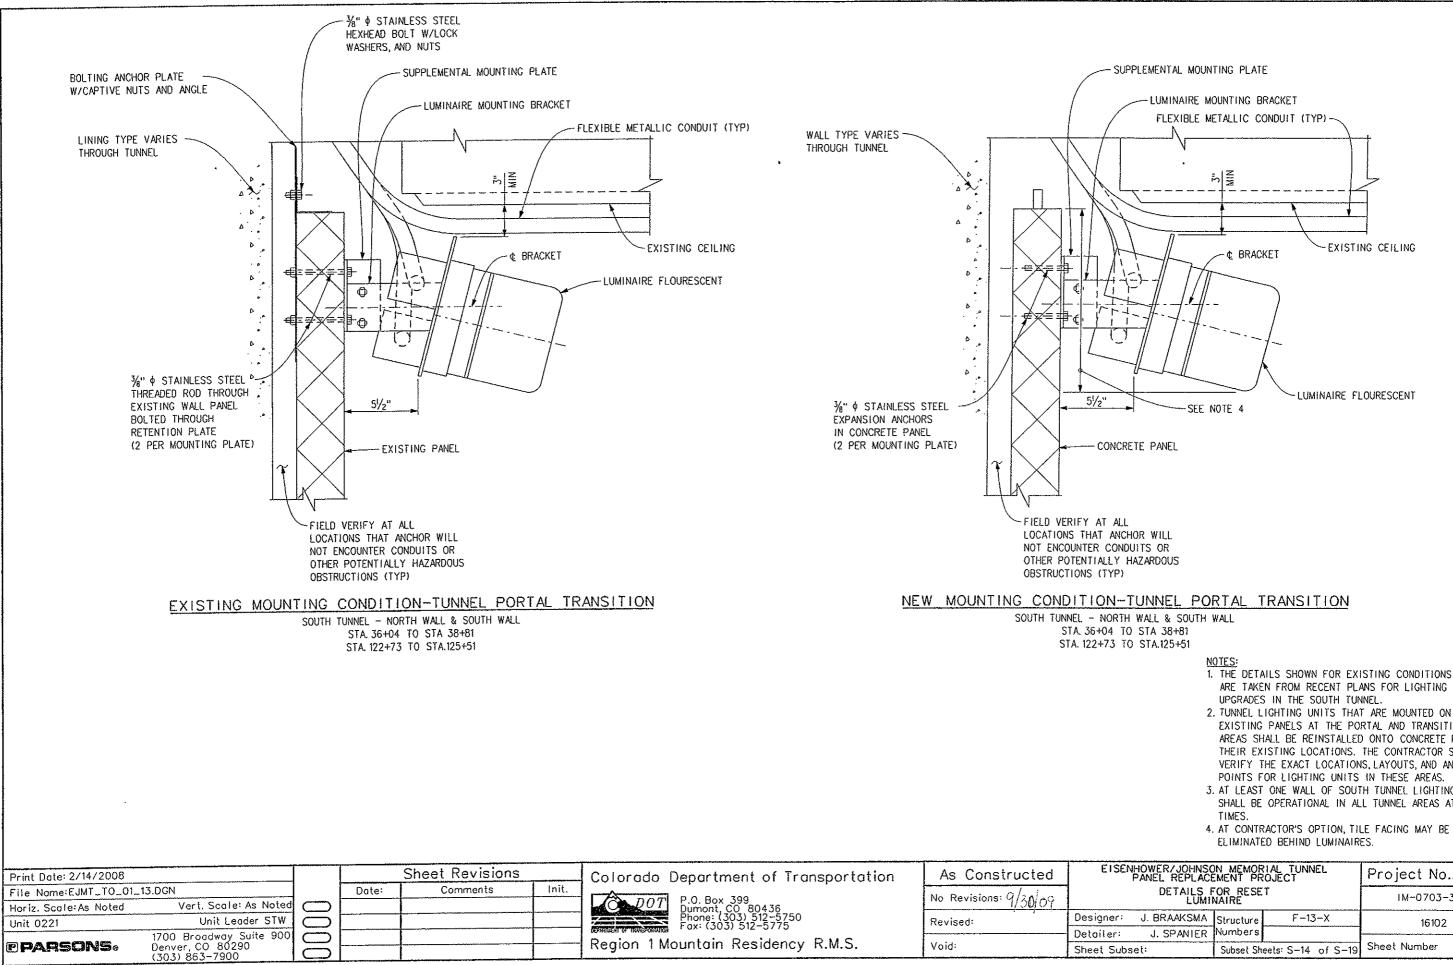

 \frown


- 1. THE DETAILS SHOWN FOR EXISTING CONDITIONS ARE TAKEN FROM RECENT PLANS FOR LIGHTING
- 2. TUNNEL LIGHTING UNITS THAT ARE MOUNTED ON EXISTING PANELS AT THE PORTAL AND TRANSITION AREAS SHALL BE REINSTALLED ONTO CONCRETE PANELS AT THEIR EXISTING LOCATIONS. THE CONTRACTOR SHALL VERIFY THE EXACT LOCATIONS, LAYOUTS, AND ANCHOR POINTS FOR LIGHTING UNITS IN THESE AREAS.
- 3. AT LEAST ONE WALL OF SOUTH TUNNEL LIGHTING UNITS SHALL BE OPERATIONAL IN ALL TUNNEL AREAS AT ALL

ENHOWER/JOHNSO PANEL REPLACE	IN MEMOR	IAL TUNNEL OJECT	Project No./Code		
DETAILS F	OR RESE	Г	IM-0703-322		
J. BRAAKSMA	Structure	F-13-X	16102		
J. SPANIER	Numbers				
bset:	Subset She	ets: S-14 of S-19	Sheet Number 16		



WALKWAY ELEMENT ON STEEL FRAMING IS APPROXIMATELY END OF EVERY WORKING SHIFT. THE COST OF AN APPROVED COORDINATED WITH REMOVAL OF EXISTING PANELS, INSTALLATION OF TILE-FACED PRECAST CONCRETE PANELS, REPLACEMENT OF

SENHOWER/JOHNSO PANEL REPLACE	N MEMOR	NAL TUNNEL OJECT	Project No./Code
TAILS FOR RESE	F PIPE H	ANDRAILING	IM-0703-322
r: J, BRAAKSMA		F-13-X	16102
J. SPANIER	Numbers		
ubset:	Subset Sh	eets: S-15 of S-19	Sheet Number 17

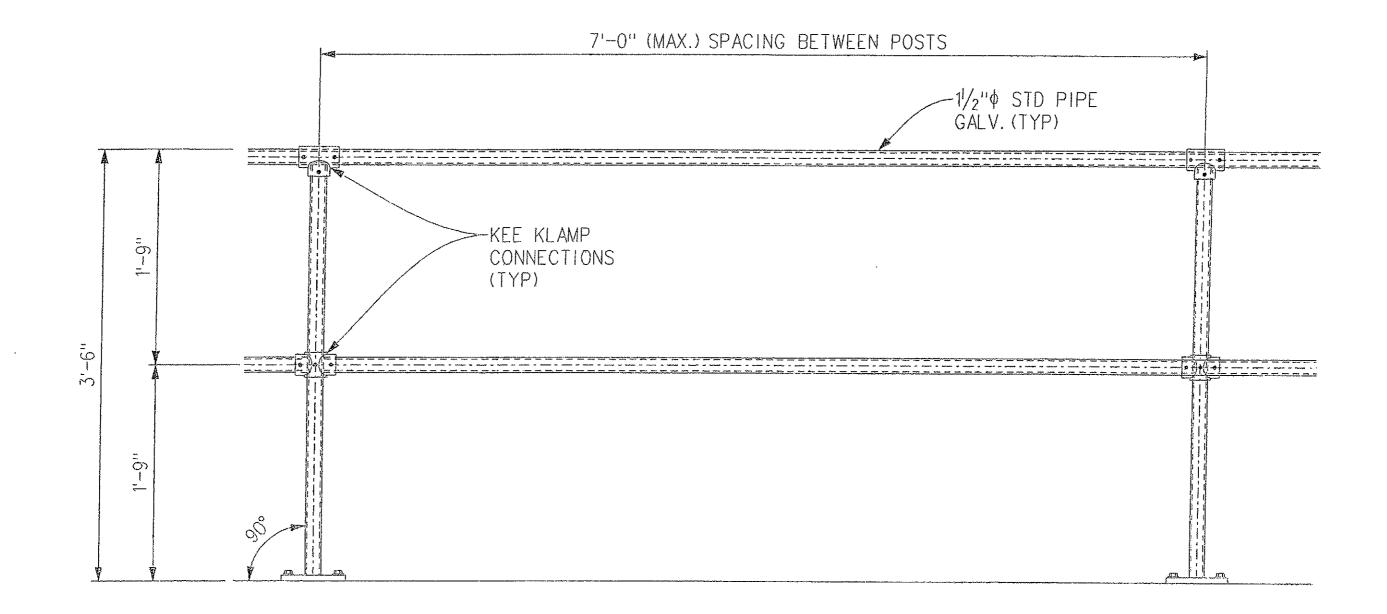

NEW HANDRAIL DETAIL

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PANEL NUMBER	UTILITY/APPURTENANCE	RE-INSTALL	ABANDON	SPECIAL PANEL REQUIRED	COMMENT
20, 21	VENT	X			
55	ANCHOR	1	Х		
59	AC PULLBOX / TELEPHONE PULLBOX	X		X	
61, 62	AC PULLBOX / TELEPHONE PULLBOX / MESSAGE BOARD DISCONNECT	X			
78	DRAIN CLEANOUT COVER PLATE	X			
86	ANCHOR		X		
97	DRAIN CLEANOUT COVER PLATE	X			
110	AC PULLBOX / TELEPHONE PULLBOX / MESSAGE BOARD DISCONNECT	X		X	
153	DRAIN CLEANOUT COVER PLATE	X		X	SEE NOTE
158	ANCHOR	- [· · · · · ·	Х		
158, 159	AC PULLBOX / TELEPHONE PULLBOX / MESSAGE BOARD DISCONNECT	X			
	ANCHOR	1	X		
<u>159</u> 172	DRAIN CLEANOUT COVER PLATE	X		X	SEE NOTE
	AC PULLBOX / TELEPHONE PULLBOX / MESSAGE BOARD DISCONNECT	X		Х	
207, 208	DRAIN CLEANOUT COVER PLATE	X		X	SEE NOTE
210	ANCHOR		X		
214	DRAIN CLEANOUT COVER PLATE	X		Х	SEE NOTE
248	ANCHOR	1	Х		
259 TOP	AC PULLBOX / TELEPHONE PULLBOX / MESSAGE BOARD DISCONNECT	X		X	
259 BTM	AC POLLBOX 7 TELEPHONE POLLBOX 7 MEDSAGE DONNO STOOSTMEDT		X		
260	DRAIN CLEANOUT COVER PLATE	X		X	SEE NOTE
267		X		X	
295	AC PULLBOX / TELEPHONE PULLBOX / MESSAGE BOARD DISCUNNECT DRAIN CLEANOUT COVER PLATE	<u> </u>			
304		X		·	
324, 325	AC PULLBOX / TELEPHONE PULLBOX / MESSAGE BOARD DISCONNECT	x l			
342	ANCHOR	^	X		
359		X	K	X	
359, 360	AC PULLBOX / TELEPHONE PULLBOX / MESSAGE BUARD DISCONNECT		X	<u> </u>	
360	DRAIN CLEANOUT COVER PLATE	X		Х	SEE NOTE
361	DRAIN CLEANOUT COVER PLATE	X		X	SEE NOTE
379	DRAIN CLEANOUT COVER FLATE	X		<u> </u>	SEE NOTE
398	DRAIN CLEANOUT COVER PLATE ANCHOR PLATE		Х	<u> </u>	OLC NOTE
409, 410 TOP		X			
409, 410 BTM	AC PULLBOX / TELEPHONE PULLBOX / MESSAGE BUARD DISCONNECT	X		Х	SEE NOTE
417	DRAIN CLEANOUT COVER PLATE	X		X	SEE NOTE
436	DRAIN CLEANOUT COVER PLATE	X I		X	SEE NOTE
455	ANCHOR	<u> </u>	X		0CL
459	ANCHON AC PULLBOX / TELEPHONE PULLBOX / MESSAGE BOARD DISCONNECT	x I	^	Х	
459, 460	AC PULLBUX / TELEPHONE PULLBUX / MESSAGE BUAND DISCOMPLET	<u> </u>	X		
460	ANCHOR		X		
480	ANCHOR		X		
486	DRAIN CLEANOUT COVER PLATE	X		Х	SEE NOTE
492	AC PULLBOX / TELEPHONE PULLBOX / MESSAGE BOARD DISCONNECT	$\frac{\hat{x}}{\hat{x}}$			ore no re
506, 507	AC PULLBOX 7 TELEPHONE POLLBOX 7 MESSAGE DOWND DISCOMILEST	- ^	X		·
509	DRAIN CLEANOUT COVER PLATE	X		X	SEE NOTE
511	DRAIN CLEANOUT COVER PLATE	x			044 11074
530	UKAIN ULEANUUT UVER PLATE	Î x		X	
545, 546	AC PULLBOX / TELEPHONE PULLBOX / MESSAGE BOARD DISCONNECT	X			
549	DRAIN CLEANOUT COVER PLATE	· ^	X		
560 TOP	ANCHOR ANCHOR	X	^^	<u> </u>	
560 BTM	AC PULLBOX / TELEPHONE PULLBOX / MESSAGE BOARD DISCONNECT	·	X		
561	ANCHOR	X	^	[
568	DRAIN CLEANOUT COVER PLATE	<u>├^</u>	X		
581	CABINET AND LEAD WIRES FOR GAUGES	<u> </u>	^	X	SEE NOTE
586	DRAIN CLEANOUT COVER PLATE	<u>├^</u>	<u>x</u>		SEC NOTE
589	ANCHOR		- Â		
610	ANCHOR	x		<u>x</u>	
611	AC PULLBOX / TELEPHONE PULLBOX / MESSAGE BOARD DISCONNECT	X			<u></u>
623	DRAIN CLEANOUT COVER PLATE	<u> ^</u>]	X		
638	ANCHOR	<u>├</u>	^	X	SEE NOTE
643	DRAIN CLEANOUT COVER PLATE	X	<u>x</u>		JEE NUIE
660	ANCHOR ANCHOR	<u>x</u>	^		
660, 661	AC PULLBOX / TELEPHONE PULLBOX / MESSAGE BOARD DISCONNECT	<u> </u>	<u>x</u>		
661	ANCHOR	4	- A (i	

PANEL NUMBER	UTILITY/APPURTENANCE	RE-INSTALL	ABANDON	SPECIAL PANEL REQUIRED	COMMENTS
662	DRAIN CLEANOUT COVER PLATE	X		Х	SEE NOTE
680, 681	DRAIN CLEANOUT COVER PLATE	X			
700	DRAIN CLEANOUT COVER PLATE	X		X	SEE NOTE (
711, 712	AC PULLBOX / TELEPHONE PULLBOX / MESSAGE BOARD DISCONNECT	X			
718	DRAIN CLEANOUT COVER PLATE	X			
737	DRAIN CLEANOUT COVER PLATE	X			
756	DRAIN CLEANOUT COVER PLATE	X		X	SEE NOTE (
760	ANCHOR		X		
761 TOP	ANCHOR		X		
761 BTM	AC PULLBOX / TELEPHONE PULLBOX / MESSAGE BOARD DISCONNECT	X		Х	
774	DRAIN CLEANOUT COVER PLATE	X		Х	SEE NOTE
781	ANCHOR		Х		
794	DRAIN CLEANOUT COVER PLATE	X		X	SEE NOTE
795	AC PULLBOX / TELEPHONE PULLBOX / MESSAGE BOARD DISCONNECT	X		X	
812	DRAIN CLEANOUT COVER PLATE	X			
821, 822	AC PULLBOX / TELEPHONE PULLBOX / MESSAGE BOARD DISCONNECT	X		X	
831	DRAIN CLEANOUT COVER PLATE	Х		X	SEE NOTE
850	DRAIN CLEANOUT COVER PLATE	X		X	SEE NOTE
861	ANCHOR		Х		
861, 862	AC PULLBOX / TELEPHONE PULLBOX / MESSAGE BOARD DISCONNECT	X		X	
862	ANCHOR		Х		
869	DRAIN CLEANOUT COVER PLATE	Х			
888	DRAIN CLEANOUT COVER PLATE	Х		X	SEE NOTE
907	DRAIN CLEANOUT COVER PLATE	X		X	SEE NOTE
911, 912	AC PULLBOX / TELEPHONE PULLBOX / MESSAGE BOARD DISCONNECT	X			
926	DRAIN CLEANOUT COVER PLATE	X		X	SEE NOTE
944	DRAIN CLEANOUT COVER PLATE	X		X	SEE NOTE
961	ANCHOR		X		
961, 962	AC PULLBOX / TELEPHONE PULLBOX / MESSAGE BOARD DISCONNECT	X		X	
962	ANCHOR		Х		
963	DRAIN CLEANOUT COVER PLATE	X			
973	ANCHOR		X		
982	DRAIN CLEANOUT COVER PLATE	X			
1001	DRAIN CLEANOUT COVER PLATE	X			SEE NOTE (
1012, 1013	AC PULLBOX / TELEPHONE PULLBOX / MESSAGE BOARD DISCONNECT	X		X	
1038	DRAIN CLEANOUT COVER PLATE	X			
1052, 1053	DRAIN CLEANOUT COVER PLATE	X			
1060, 1061	CAMERA AND TWO EXTERNAL BOXES - ELECTRIC, TELEPHONE, COAX	X		1	
1065 TOP	TWO ANCHORS		X		
1065 BTM	AC PULLBOX / TELEPHONE PULLBOX / MESSAGE BOARD DISCONNECT	X	1	X	
1069	ANCHOR		X		
1119	SIGNAL HORN / ELECTRIC		X		

NOTES:

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1. THE PANEL NUMBER SHOWN INCLUDES BOTH THE UPPER AND LOWER PANEL SECTIONS AT THE PORTALS. 2. FOR DETAILS AT SPECIAL PANELS AND AT STACKED PANELS AT PORTAL AREAS, SEE SHEET S-13. 3. THE CONTRACTOR SHALL VERIFY ALL LOCATIONS AND DIMENSIONS FOR CONCRETE PANELS PRIOR TO PANEL FABRICATION AND INSTALLATION. ALL ON-SITE PANEL SURVEY EFFORTS SHALL BE COORDINATED WITH TUNNEL MAINTENANCE AND THE ENGINEER.

ALL ON-SITE PANEL SURVEY EFFORTS SHALL BE CONTINUENTAL DIVIDE MARKER AND SIGNS SHALL BE REINSTALLED ONTO NEW PANELS AT THEIR EXISTING LOCATIONS. HARDWARE FOR REINSTALLATION SHALL BE NEW AND SHALL MATCH EXISTING SIGN HARDWARE.
 DURING PANEL REMOVAL, ALL ANCHOR BOLTS THROUGH THE EXISTING TILE BLOCK PANELS SHALL BE CUT OFF TO ¼" BELOW THE SURFACE OF THE CONCRETE OF THE TUNNEL LINING, AND THE HOUSE SHALL BE PATCHED WITH AN APPROVED EPOXY GROUT. ANCHOR BOLTS THROUGH EXISTING

TILE BLOCK PANELS ARE LOCATED IN PANELS NUMBERED 55, 158, 159, 214, 259, 260, 359, 360, 409, 410, 459, 460, 480, 486, 509, 560, 561, 589, 638, 660, 661, 760, 761, 781, 861, 862, 961, 962, 973, 1065, AND 1069 ON THE SOUTH WALL. 6. THE CONTRACTOR SHALL COORDINATE WITH THE ENGINEER THE FINAL SIZE AND LOCATION OF DRAIN CLEANOUTS UNDER COVER PLATES TO

MINIMIZE THE NUMBER OF SPECIAL PANELS WITH DRAIN CLEANOUT COVER PLATES.

7. THE CONTRACTOR MAY ADJUST THE EXISTING PANEL LAYOUT TO REDUCE THE NUMBER OF SPECIAL PANELS AND TO INCREASE THE NUMBER OF PANELS THAT MEET THE DIMENSIONAL REQUIREMENTS SHOWN ON SHEET S-13. REVISIONS TO THE PANEL LAYOUT SHALL BE PROVIDED TO THE ENGINEER FOR REVIEW AND APPROVAL BEFORE THE PANEL SHOP DRAWINGS.

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File Name:EJMT_TO_01_15.dgn	Date: Comments Init.	· · · · ·	No Revisions: 9/2 No9	
Horiz, Scale: As Noted Vert, Scale: As Noted		P.0. Box 399 Dumont C0 80436 Phone: (303) 512-5750 Fox: (303) 512-5775	No Revisions: 9/3409	Designer:
1700 Broadway Suite 900			Revised:	Detailer:
PARSONS Denver, CO 80290 (303) 863-7900		Region 1 Mountain Residency R.M.S.	Void:	Sheet Sub

ENHOWER/JOHNSO PANEL REPLACE		+ + + = .	Project No./Code
TABLE OF SP SOUTH	ECIAL PA WALL	NELS	IM~0703-322
J. BRAAKSMA Structure F-13-X			16102
J. SPANIER	Numbers		
bset:	Subset Sheets: S-16 of S-19		Sheet Number 18

PANEL NUMBER	UTILITY/APPURTENANCE	RE-INSTALL	ABANDON	SPECIAL PANEL REQUIRED	COMMENT
	CO ANALYZER, ELECTRIC		X		
4	DOORWAY	X		L	
10, 11	CAMERA AND TWO EXTERNAL BOXES - ELECTRIC, TELEPHONE, COAX	X			
14	HEAT TRACE / ELECTRIC	Х		<u> </u>	
17	FIRE*EXTINGUISHER	Х			SEE NOTE
38	HFAT TRACE / ELECTRIC	X		<u> </u>	
42	ANCHOR		Χ		ļ
50	CAMERA AND THREE EXTERNAL BOXES - ELECTRIC, TELEPHONE, COAX	X			
57	AC PULLBOX / DC PULLBOX / TELEPHONE PULLBOX / COAX PULLBOX	X		X	<u> </u>
58, 59	VMS PANEL	PANEL WI	LL NOT BE	REPLACED	
<u>60</u>	DRAIN CLEANOUT COVER PLATE	X		<u> </u>	
61 BTM	ANCHOR		X		
61 TOP	AC PULLBOX / DC PULLBOX / TELEPHONE PULLBOX / COAX PULLBOX	X		[<u> </u>
61, 62	TELEPHONE CABINET	X			<u>) see note</u>
65 BTM	ELECTRIC LIGHT		X	[
65 TOP	FLECTRIC BOX	[·····	Х		
67	FIRE EXTINGUISHER CABINET	X		X	SEE NOTE
70	CABINET, LEAD WIRES FOR GAUGES		Х	1	
71	DRAIN CLEANOUT COVER PLATE	X		X	SEE NOTE
79	ELECTRIC BOX		X		
92	ANCHOR		Х		
96	DRAIN CLEANOUT COVER PLATE	X		X	SEE NOTE
97		X		1	SEE NOTE
101		1	Х	1	
104		X	<u>_</u> ,	1	
105	HEAT TRACE / ELECTRIC			X	
110	AC PULLBOX / DC PULLBOX / TELEPHONE PULLBOX / COAX PULLBOX	X		1	
116	DRAIN CLEANOUT COVER PLATE	<u>^</u>	X		1
117	ELECTRIC_BOX		X		
129	ELECTRIC BOX	X	······	X	SEE NOTE
133	FIRE EXTINGUISHER CABINET	X		<u></u>	
135	DRAIN CLEANOUT COVER PLATE	<u> ^-</u>	X	1	
142	ELECTRIC BOX	X	^	X	SEE NOTE
153	DRAIN CLEANOUT COVER PLATE	·	χ		
154	ELECTRIC BOX	X	<u>^</u>	1	
157	CAMERA AND TWO EXTERNAL BOXES - ELECTRIC, TELEPHONE, COAX	<u>x</u>		X	
158, 159	AC PULLBOX / DC PULLBOX / TELEPHONE PULLBOX / COAX PULLBOX		LL NOT BE		
160	VMS PANEL	Χ		X	SEE NOTE
164	FIRE EXTINGUISHER CABINET	X		1	SEE NOTE
165 BTM	TELEPHONE CABINET	<u> </u>	X		300 11010
165 TOP	ELECTRIC LIGHT	X		1	
166	ELECTRIC BOX	X			
168	HEAT TRACE / ELECTRIC	X		X	SEE NOTE
172	DRAIN CLEANOUT COVER PLATE	<u>^</u>	X		<u> </u>
179	ELECTRIC BOX	X	<u>^</u>		
191 BTM	DRAIN CLEANOUT COVER PLATE	<u> </u>	X		
191 TOP	ELECTRIC BOX	X	·		SEE NOTE
195, 196	FIRE EXTINGUISHER CABINET	<u> </u>	X	+	JUL NOIC
200	CABINET, LEAD WIRES FOR GAUGES		X		
203	ELECTRIC BOX		·	X	
207, 208	AC PULLBOX / DC PULLBOX / TELEPHONE PULLBOX / COAX PULLBOX	X X		X	SEE NOTE
210	DRAIN CLEANOUT COVER PLATE	+	X	+	JULL HUIL
216	ELECTRIC BOX		LL NOT BE		
227	FIRE EXTINGUISHER CABINET	PANEL WI		T	<u> </u>
228	ELECTRIC BOX		X	<u>γ</u>	SEE NOTE
229	DRAIN CLEANOUT COVER PLATE	<u>X</u>		<u> </u>	JEL NUTE
230	HEAT TRACE / ELECTRIC	X	······		<u> </u>
240	ELECTRIC BOX		<u>X</u>		CET NOTE
248	DRAIN CLEANOUT COVER PLATE	X		X	SEE NOTE

PANEL NUMBER	UTILITY/APPURTENANCE	RE-INSTALL	ABANDON	SPECIAL PANEL REQUIRED	COMMENT
253	ELECTRIC BOX		X		
258 TOP	CAMERA AND TWO EXTERNAL BOXES - ELECTRIC, TELEPHONE, COAX	X			
258 BTM	FIRE EXTINGUISHER CABINET	X		X	SEE NOTE
259 TOP	AC PULLBOX / DC PULLBOX / TELEPHONE PULLBOX / COAX PULLBOX	X		Х	
259 MOL	CO ANALYZER, ELECTRIC	χ.		X	-
259 BTM	CO ANALYZER, ELECTRIC		Х		
259 51	VMS PANEL	PANEL WI	LL NOT BE	REPLACED	
265 BTM	TELEPHONE CABINET	X		X	SEE NOTE
265 TOP	ELECTRIC BOX		X		
265	ELECTRIC LIGHT		X		
265	DRAIN CLEANOUT COVER PLATE	X		X	SEE NOTE
277	ELECTRIC BOX	PANEL WI	LL NOT BE	REPLACED	
285	DRAIN CLEANOUT COVER PLATE	X		X	SEE NOTE
287	CABINET, LEAD WIRES FOR GAUGES	<u>_</u>	X	1	
289, 290	FIRE EXTINGUISHER CABINET	X			SEE NOTE
290	ELECTRIC BOX		X		
	HEAT TRACE / ELECTRIC	Х			
293	FIRE EXIT LIGHT / ELECTRIC	X		1	[
294	AC PULIBOX / DC PULLBOX / TELEPHONE PULLBOX / COAX PULLBOX	Ŷ			<u> </u>
	WEST CROSSOVER	X		X	
295 L	CO ANALYZER, ELECTRIC	·	Х		
295 R	ELECTRIC BOX		X		
302	DRAIN CLEANOUT COVER PLATE	X		1	
304	ELECTRIC BOX		X	1	
314	FIRE EXTINGUISHER CABINET	Х		X	SEE NOTE
321	DRAIN CLEANOUT COVER PLATE	X		1	
323	HEAT TRACE / ELECTRIC	X		1	
324	AC PULLBOX / DC PULLBOX / TELEPHONE PULLBOX / COAX PULLBOX	X		X	
324, 325	ELECTRIC BOX		X		
327	CABINET, LEAD WIRES FOR GAUGES		X		
338	CABINET, LEAD WIRES FOR GAUGES		X		
339	ELECTRIC BOX		X	1	
345	CABINET, LEAD WIRES FOR GAUGES		X		
350 BTM	CABINET, LEAD WIRES FOR GAUGES		X	1	
350 TOP	ANCHOR		X		
352 BTM	FIRE EXTINGUISHER CABINET	X		X	SEE NOTE
352 TOP	ELECTRIC BOX		Х		
356 BTM	HEAT TRACE / ELECTRIC		X	[·····································	
356 TOP	ANCHOR		X X	1	
357	CABINET, LEAD WIRES FOR GAUGES		X		
	CAMERA AND TWO EXTERNAL BOXES - ELECTRIC, TELEPHONE, COAX	Х	<u> </u>		
<u> </u>	AC PULLBOX / DC PULLBOX / TELEPHONE PULLBOX / COAX PULLBOX	X		X	
and the second sec	VMS PANEL		L NOT BE	REPLACED	
360 364 BTM	CABINET, LEAD WIRES FOR GAUGES	<u> </u>	X		
364 TOP	FIFCTRIC BOX		X	1	

NOTES:

NOTES: 1. FOR ADDITIONAL NOTES AND DETAILS OF SPECIAL PANELS, SEE SHEETS S-13 AND S-16. 2. TUNNEL SEGMENT SIGNS SHALL BE REINSTALLED ONTO NEW PANELS AT THEIR EXISTING LOCATIONS AT THE BEGINNING AND ENDING OF ALL TUNNEL SEGMENTS. HARDWARE FOR REINSTALLATION SHALL BE NEW AND SHALL MATCH EXISTING HARDWARE. 3. DURING PANEL REMOVAL, ALL ANCHOR BOLTS THROUGH THE EXISTING TILE BLOCK PANELS SHALL BE CUT OFF TO 1/4" BELOW THE SURFACE OF THE CONCRETE OF THE TUNNEL LINING, AND THE HOLE SHALL BE PATCHED WITH AN APPROVED EPOXY GROUT. ANCHOR BOLTS THROUGH EXISTING TILE BLOCK PANELS ARE LOCATED IN PANELS NUMBERED 50, 61, 96, 350, 356,

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400, 404, 486, 615, 672, 741, 824,931, 934, 943, 959, AND 1047 ON THE NORTH WALL. 4. THE CONTRACTOR SHALL CORDINATE WITH THE ENGINEER THE FINAL SIZE AND LOCATION OF HOLES FOR DRAIN CLEANOUTS UNDER COVER PLATES, TO MINIMIZE THE NUMBER OF SPECIAL PANELS WITH DRAIN CLEANOUT COVER PLATES. 5. HOLE LOCATIONS OF CABINETS FOR FIRE EXTINGUISHERS AND EMERGENCY TELEPHONES MAY BE SHIFTED UP TO THREE FEET

LATERALLY, TO MINIMIZE THE NUMBER OF SPECIAL PANELS WITH THOSE CABINETS. 6. THE CONTRACTOR MAY ADJUST THE EXISTING PANEL LAYOUT TO REDUCE THE NUMBER OF SPECIAL PANELS AND TO INCREASE THE NUMBER OF PANELS THAT MEET THE DIMENSIONAL REQUIREMENTS SHOWN ON SHEET S-13. REVISIONS TO THE PANEL

LAYOUT SHALL BE PROVIDED TO THE ENGINEER FOR REVIEW AND APPROVAL BEFORE THE PANEL SHOP DRAWINGS.

SENHOWER/JOHNSC PANEL REPLACE		Project No./Code			
TABLE OF SP NORTH	ECIAL PAI WALL (I)	IM-0703-322			
: J. BRAAKSMA		F-13-X	16102		
J. SPANIER	Numbers				
ubset:	Subset She	eets: S-17 of S-19	Sheet Number 19		

PANEL NUMBER	UTILITY/APPURTENANCE	RE-INSTALL	ABANDON	SPECIAL PANEL REQUIRED	COMMENTS
366 BTM	TELEPHONE CABINET	X		X	SEE NOTE
366 TOP	ELECTRIC LIGHT		X		
	ELECTRIC BOX		X		
376	FIRE EXTINGUISHER CABINET	X			SEE NOTE
383, 384	ELECTRIC BOX	^	X		
	ANCHOR		X		
400			X		
401	ELECTRIC BOX		X		
404	ANCHOR				}
409, 410 BTM	CO ANALYZER, ELECTRIC		<u> X </u>		
409, 410 TOP	CO_ANALYZER. ELECTRIC	<u>X</u>			
410, 411	AC PULLBOX / DC PULLBOX / TELEPHONE PULLBOX / COAX PULLBOX	X		X	[
413	ELECTRIC BOX		X		
415	FIRE EXTINGUISHER CABINET	X			SEE NOTE
419	HEAT TRACE / ELECTRIC	X			
419 426	ELECTRIC BOX		X		
	CABINET, LEAD WIRES FOR GAUGES		X		
428	CABINET, LEAD WIRES FOR GAUGES		X		
438 BTM			X		
438 TOP	ELECTRIC BOX	X	<u> </u>		SEE NOTE
446	FIRE EXTINGUISHER CABINET	À	Y		SEC NOTE .
450	ELECTRIC BOX		<u>X</u>		
456	CABINET, LEAD WIRES FOR GAUGES		<u>X</u>		
458, 459	CAMERA AND TWO EXTERNAL BOXES - ELECTRIC, TELEPHONE, COAX	Χ			
459, 460	AC PULLBOX / DC PULLBOX / TELEPHONE PULLBOX / COAX PULLBOX	X		X	
461	VMS PANEL	PANEL WI	LL NOT BE	REPLACED	
463	ELECTRIC BOX		Х		
465 BTM	TELEPHONE CABINET	Х		Х	SEE NOTE S
	FLECTRIC LIGHT		Х		
465 TOP	CABINET, LEAD WIRES FOR GAUGES		X		
469	DRAIN CLEANOUT COVER PLATE	X		Х	SEE NOTE 4
474		X			SEE NOTE S
477, 478	FIRE EXTINGUISHER CABINET	X			<u> </u>
481	HEAT TRACE / ELECTRIC	····· ^	Х		
486	ANCHOR		- Â		
488	ELECTRIC BOX	···	X		
493	DRAIN CLEANOUT COVER PLATE	X			
500	ELECTRIC BOX		X		
506, 507	AC PULLBOX / DC PULLBOX / TELEPHONE PULLBOX / COAX PULLBOX	<u>X</u>		X	
509	FIRE EXTINGUISHER CABINET	X			SEE NOTE 5
511	DRAIN CLEANOUT COVER PLATE	X			
512	ELECTRIC BOX		X		
	ELECTRIC BOX		Х		
525	DRAIN CLEANOUT COVER PLATE	X		X	SEE NOTE 4
531	ELECTRIC BOX	·····	X		X.; M
537	HEAT TRACE / ELECTRIC	X			
544	FIRE EXIT LIGHT / ELECTRIC	X			
545		X			
545, 546 BTM	CENTER CROSSOVER				
545, 546 TOP	AC PULLBOX / DC PULLBOX / TELEPHONE PULLBOX / COAX PULLBOX	Χ			
546	CO_ANALYZER, ELECTRIC		<u>X</u>		
547	ANEMOMETER	<u> </u>			
549	ELECTRIC BOX		X		
553	FIRE EXTINGUISHER CABINET	X		<u> </u>	SEE NOTE 5
559	CAMERA AND TWO EXTERNAL BOXES - ELECTRIC, TELEPHONE, COAX	X			
560 BTM	CO ANALYZER, ELECTRIC		X		
	CO ANALYZER, ELECTRIC	Х		X	
<u>560_MOL</u>	AC PULLBOX / DC PULLBOX / TELEPHONE PULLBOX / COAX PULLBOX	X		X	
560 TOP	VMS PANEL	PANEL WIL	L NOT BE F		
561			<u>X</u>		
562	ELECTRIC BOX			·	
566	ELECTRIC LIGHT		X	X	SEE NOTE 5
566, 567	TELEPHONE CABINET	X		5 I	SEE NUBE 5

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PANEL NUMBER	UTILITY/APPURTENANCE	RE-INSTALL	ABANDON	SPECIAL PANEL REQUIRED	COMMENTS
569	CABINET, LEAD WIRES FOR GAUGES	1	X		}
572	FIRE EXTINGUISHER CABINET	X		X	SEE NOTE
574	ELECTRIC BOX		X		
576	HEAT_TRACE / ELECTRIC	<u> </u>			[
580	CABINET, LEAD WIRES FOR GAUGES		X		
581 L	CABINET, LEAD WIRES FOR GAUGES		<u> </u>		
581 R	CABINET, LEAD WIRES FOR GAUGES		<u> X </u>	<u> </u>	
586	ELECTRIC BOX		<u> X </u>		
593	CABINET, LEAD WIRES FOR GAUGES		<u> </u>		
599	ELECTRIC BOX		<u> </u>	<u></u>	
600	CABINET, LEAD WIRES FOR GAUGES	·····	<u> </u>		OFF NOTE
602,603	FIRE EXTINGUISHER CABINET	X X			SEE NOTE
611 BTM 611 TOP	AC PULLBOX / DC PULLBOX / TELEPHONE PULLBOX / COAX PULLBOX ELECTRIC BOX		v	X	
615	ANCHOR		<u>X</u> X		
624 BTM	CABINET, LEAD WIRES FOR GAUGES		<u> </u>		
624 TOP	ELECTRIC BOX		<u> </u>		
634, 635	FIRE EXTINGUISHER CABINET	X	<u>^</u>		SEE NOTE
636	ELECTRIC BOX		X		JEL NOTE .
638	HEAT TRACE / ELECTRIC	X	~		
648	ELECTRIC BOX	^	X		
652	CABINET, LEAD WIRES FOR GAUGES		X		
659,660	CAMERA AND TWO EXTERNAL BOXES - ELECTRIC, TELEPHONE, COAX	X			
660, 661	AC PULLBOX / DC PULLBOX / TELEPHONE PULLBOX / COAX PULLBOX	X		х	· • ·
661	ELECTRIC BOX		X	······	
662	VMS PANEL	PANEL WIL		REPLACED	
666	FIRE EXTINGUISHER CABINET	X			SEE NOTE S
667 BTM	TELEPHONE CABINET	Х		Х	SEE NOTE S
667 TOP	ELECTRIC LIGHT		Х		
671	CABINET, LEAD WIRES FOR GAUGES		Х		
672	ANCHOR		Х		
673	ELECTRIC BOX		X		
675	CABINET, LEAD WIRES FOR GAUGES		X		
681	CABINET, LEAD WIRES FOR GAUGES		X		
685	ELECTRIC BOX		X		
697	FIRE EXTINCUISHER CABINET	<u> </u>			SEE NOTE 5
698	ELECTRIC BOX		<u> </u>		
699, 700	CABINET, LEAD WIRES FOR GAUGES		X		····
701 710	HEAT TRACE / ELECTRIC ELECTRIC BOX	X	x		<u> </u>
710, 711	CO ANALYZER, ELECTRIC	x	<u> </u>		· · · · · · · · · · · · · · · · · · ·
711	CO ANALYZER, ELECTRIC	^	X		
711, 712	AC PULLBOX / DC PULLBOX / TELEPHONE PULLBOX / COAX PULLBOX	X	^!	X	
713	CABINET, LEAD WIRES FOR GAUGES		X		
722	ELECTRIC BOX		<u>x</u>		
726	CABINET, LEAD WIRES FOR GAUGES		X		
729	FIRE EXTINGUISHER CABINET	X			SEE NOTE 5
735	ELECTRIC BOX		X	İ	
741	ANCHOR		X		
747	ELECTRIC BOX		X		
759, 760	CAMERA AND TWO EXTERNAL BOXES - ELECTRIC, TELEPHONE, COAX	Х			
760 BTM	FIRE EXTINGUISHER CABINET	X		X	SEE NOTE 5
760 TOP	ELECTRIC BOX		X		
760, 761	AC PULLBOX / DC PULLBOX / TELEPHONE PULLBOX / COAX PULLBOX	X		X	
762	VMS PANEL	PANEL WILL	. NOT BE F	REPLACED	
763	CABINET, LEAD WIRES FOR GAUGES		<u>X</u>		
764	HEAT TRACE / ELECTRIC	X			
767 BTM	TELEPHONE CABINET	X	T	X	SEE NOTE 5

Print Date: 2/14/2008			Sheet Revisions		Colorado Department of Transportation	As Constructed	EISENHOWER/JOHNSC PANEL REPLACE		Project No./Code
File Name:EJMT_TO_01_16.dgn Hariz. Scale:As Noted Vert. Scale: As Noted	\square	Date:	Comments	Init.	DOT P.O. Box 399	No Revisions:9/30/09	TABLE OF SP NORTH V	ECIAL PANELS NALL (11)	IM-0703-322
Unit 0221 Unit Leader STW	\square				Phone: (303) 512-5750 Fax: (303) 512-5775	Revised:	Designer: J. BRAAKSMA Detailer: J. SPANIER		16102
PPARSONS 1700 Broadway Suite 900 Denver, C0 80290 (303) 863-7900	\square				Region 1 Mountain Residency R.M.S.	Void:		Subset Sheets: S-18 of S-19	Sheet Number 20

<u>NOTES:</u> 1. FOR NOTES, SEE SHEET S-17.

PANEL NUMBER	UTILITY/APPURTENANCE	RE-INSTAL		SPECIAL PANEL REQUIRED	COMMENTS
767 TOD	ELECTRIC LIGHT		X		
767 TOP	CABINET, LEAD WIRES FOR GAUGES		X		
769 772			<u> </u>		
784	ELECTRIC BOX		<u> </u>		
791, 792	FIRE EXTINGUISHER CABINET	X	<u></u>		SEE NOTE
794	DRAIN CLEANOUT COVER PLATE	<u>X</u>		<u>X</u>	SEE NOTE
795	AC PULLBOX / DC PULLBOX / TELEPHONE PULLBOX / COAX PULLBOX	<u>X</u>		<u> </u>	
797	ELECTRIC BOX		<u> </u>		
809	ELECTRIC BOX		<u> </u>		
812	DRAIN CLEANOUT COVER PLATE	X			
819, 820	CABINET, LEAD WIRES FOR GAUGES		<u> </u>		
820	CABINET, LEAD WIRES FOR GAUGES		<u> </u>		
821, 822 BTM	EAST CROSSOVER	<u>X</u>			
821, 822 TOP	AC PULLBOX / DC PULLBOX / TELEPHONE PULLBOX / COAX PULLBOX	X	+		
822 BTM	CO ANALYZER. ELECTRIC		- <u></u>		
822 TOP	FIRE EXIT LIGHT / ELECTRIC	<u>X</u>		X	SEE NOTE
823	FIRE EXTINGUISHER CABINET	Χ	+ x		JEC NU (C .
824	ANCHOR	~	<u> </u>		
827	HEAT TRACE / ELECTRIC	<u> </u>		X	SEE NOTE 4
831	DRAIN CLEANOUT COVER PLATE	^	<u>- х</u>		JEL NOIL -
831, 832	CABINET, LEAD WIRES FOR GAUGES		$\frac{1}{x}$		
834	ELECTRIC BOX		X		
837	CABINET, LEAD WIRES FOR GAUGES		X		
846	ELECTRIC BOX	X	- <u> </u> ^		
850	DRAIN CLEANOUT COVER PLATE	X		X	SEE NOTE S
854	FIRE EXTINCUISHER CABINET	<u> ^</u>	X		
858	CAMERA AND TWO EXTERNAL BOXES - ELECTRIC, TELEPHONE, COAX	Х	<u> </u>		[
860, 861	CO ANALYZER, ELECTRIC	<u> </u>	X		
861 BTM	CO ANALYZER, ELECTRIC	Х			
861, 862	AC PULLBOX / DC PULLBOX / TELEPHONE PULLBOX / COAX PULLBOX	X		X	
861 TOP	AC POLLBOX 7 OC POLLOUX 7 HELEINANE 7 OLLOUX 901	PANEL W	ILL NOT B	E REPLACED	
863	TELEPHONE CABINET	PANEL W	ILL NOT B	E REPLACED	
868 L	ELECTRIC LIGHT	PANEL W	ILL NOT B	E REPLACED	
868 868 R		PANEL W	ILL NOT B	E REPLACED	
874	CABINET	PANEL W	ILL NOT B	E REPLACED	
879, 880	CABINET, LEAD WIRES FOR GAUGES		<u> </u>		
883	ELECTRIC BOX	<u> </u>	<u> </u>		
885, 886	FIRE EXTINGUISHER CABINET	X			SEE NOTE !
889	HEAT TRACE / ELECTRIC	Х			
895, 896	ELECTRIC BOX		<u> </u>		055 1070
906	DRAIN CLEANOUT COVER PLATE	<u>X</u>		X	SEE NOTE
908 BTM	CABINET, LEAD WIRES FOR GAUGES		<u> </u>		
908 TOP	ELECTRIC BOX		<u> </u>		
912, 913	AC PULLBOX / DC PULLBOX / TELEPHONE PULLBOX / COAX PULLBOX	X		X	SEE NOTE S
917	FIRE EXTINGUISHER CABINET	<u> X </u>			JUL NOTE
920	ELECTRIC BOX		X		
931	ANCHOR				
933	ELECTRIC BOX		$\frac{1}{x}$		
934	ANCHOR		$\frac{1}{x}$		
943	ANCHOR	X			
945 BTM	DRAIN CLEANOUT COVER PLATE	·			
945 TOP	ELECTRIC BOX	<u> </u>	X		
947	CABINET, LEAD WIRES FOR GAUGES		<u>+</u> −− <u>x</u> ̂−		
947, 948	CABINET, LEAD WIRES FOR GAUGES	X			SEE NOTE
948, 949	FIRE EXTINGUISHER CABINET	X			Jee nyre
952	HEAT TRACE / ELECTRIC	<u> </u>	+ x		i
957	ELECTRIC BOX	<u>!</u>			L

PANEL NUMBER	UTILITY/APPURTENANCE	RE-INSTALL	ABANDON	SPECIAL PANEL REQUIRED	COMMENTS
959	ANCHOR		X	1	
960, 961	CAMERA AND TWO EXTERNAL BOXES - ELECTRIC, TELEPHONE, COAX	Х			
961, 962	AC PULLBOX / DC PULLBOX / TELEPHONE PULLBOX / COAX PULLBOX	X		X	
963	VMS PANEL	PANEL WI	LL NOT BE	REPLACED	
968 BTM	TELEPHONE CABINET	х •			SEE NOTE
968 TOP	ELECTRIC LIGHT	-	Х]
970	ELECTRIC BOX		Х		
973	CABINET, LEAD WIRES FOR GAUGES		X		
980	FIRE EXTINGUISHER CABINET	Х		X	SEE NOTE
982 BTM	DRAIN CLEANOUT COVER PLATE	Х		X	SEE NOTE
982 TOP	ELECTRIC BOX		Х		
994	ELECTRIC BOX		X	1	
1001	DRAIN CLEANOUT COVER PLATE	X		X	SEE NOTE
1007	ELECTRIC BOX		Х	1	
1012	FIRE EXTINGUISHER CABINET	X		1	SEE NOTE
1012	AC PULLBOX / DC PULLBOX / TELEPHONE PULLBOX / COAX PULLBOX	X		X	
1015	HEAT TRACE / ELECTRIC	X		1	
1013	ELECTRIC BOX		X	1	
1020	DRAIN CLEANOUT COVER PLATE	X		X	SEE NOTE
1020	ELECTRIC BOX	^	X		
1034, 1035	CABINET, LEAD WIRES FOR GAUGES		<u>X</u>	1	
1038	ORAIN CLEANOUT COVER PLATE	х	<u> </u>		
	FIRE EXTINGUISHER CABINET	Ŷ		}	SEE NOTE
1042, 1043	CABINET, LEAD WIRES FOR GAUGES	r^	χ	1	
1043	FLECTRIC BOX		X		
	ANCHOR		X	f	
1047	ELECTRIC BOX		X		
1056	HEAT TRACE / ELECTRIC	X			
	VMS PANEL		LL NOT BE	REPLACED	
1063	AC PULLBOX / DC PULLBOX / TELEPHONE PULLBOX / COAX PULLBOX	X		X X	
1065 1065	TELEPHONE CABINET	X		· · · · · · · · · · · · · · · · · · ·	SEE NOTE
	ELECTRIC LIGHT		X		JUL HOIL
1069 TOP 1073	FIRE EXTINGUISHER CABINET	χ	<u> </u>	X	SEE NOTE
	HEAT TRACE / ELECTRIC	X		· · · · ·	
1078	HEAT TRACE / ELECTRIC	ŷ		1	
110.3	DOORWAY	X		Х	
1104	DOORWAT	X		X	
1109	VENT	X		·^^	
1109, 1110	CO ANALYZER, ELECTRIC	^	X		
<u>†114</u>	VENT	X	^	Х	

Print Date: 2/14/2008		Sheet Revisions	Colorado Department of Transportation	As Constructed	EISENHOWER/JOHNSC PANEL REPLACE	ON MEMORIAL TUNNEL EMENT PROJECT	Project No./Code
File Name:EJMT_TO_01_16.dgn		Date: Comments Init.	P.O. Box 399	No Revisions: 9/30/09	TABLE OF SP NORTH W	ECIAL PANELS VALL (111)	IM-0703-322
Horiz. Scale: As NotedVert. Scale: As NotedUnit 0221Unit Leader STW	0		Phone: (303) 512-5750 Fox: (303) 512-5775	Revised:	Designer: J. BRAAKSMA Detailer: J. SPANIER		16102
PARSONS 1700 Broadway Suite 900 Denver, CO 80290 (303) 863-7900			Region 1 Mountain Residency R.M.S.	Void:		Subset Sheets: S-19 of S-19	Sheet Number 21

<u>NOTES:</u> 1. FOR NOTES, SEE SHEET S-17.

- 1. ALL CONSTRUCTION ZONE TRAFFIC CONTROL DEVICES, INCLUDING BUT NOT LIMITED TO BARRICADES, SIGNS, ARROW PANELS, FLASHING BEACON (PORTABLE), AND CHANNELIZING DEVICES, SHALL BE FURNISHED, INSTALLED, MAINTAINED (INCLUDING WASHING), REPLACED IF DAMAGED, REMOVED WHEN TEMPORARILY NOT IN USE AND RETURNED WHEN REQUIRED, RESET AS NECESSARY DURING THE PROGRESS OF CONSTRUCTION, AND REMOVED ENTIRELY WHEN THE PROJECT IS COMPLETED. ALL DEVICES SHALL MEET THE REQUIREMENTS OF ATSSA "QUALITY STANDARDS FOR WORK ZONE TRAFFIC CONTROL - 1992"
- 2. WORK ON THE PROJECT SHALL NOT BE STARTED UNTIL ALL REQUIRED TRAFFIC CONTROL DEVICES ARE IN PLACE, AND APPROVED BY THE FNGINEER.
- 3. WHEN SPEED LIMIT REDUCTION IS REQUIRED, SUCH REDUCTION SHALL BE IN ACCORDANCE WITH COOT FORM 568, "AUTHORIZATION AND DECLARATION OF TEMPORARY SPEED LIMITS."

WHEN A CHANGE IN AN EXISTING SPEED LIMIT IS REQUIRED, THE R2-1 SIGNS, SHOWN ON THE SCHEDULE OF CONSTRUCTION TRAFFIC CONTROL DEVICES, SHOULD BE INSTALLED AT THE LOCATIONS SHOWN ON THE TYPICAL CASES BY R2-1 (OPTIONAL) SIGNS.

AN ADVISORY SPEED PLATE (W13-1) MAY BE USED WITH A WARNING SIGN WHEN THE MAXIMUM RECOMMENDED SPEED FOR CONDITION NAMED IS LOWER THAN THE POSTED SPEED LIMIT.

THE REGULATORY OR ADVISORY SPEED REDUCTION DISPLAYED SHALL NOT EXCEED 15 MPH PER SIGN INSTALLATION.

- 4. ANY TRAFFIC CONTROL DEVICE THAT IS DAMAGED, WEATHERED, WORN, OR OTHERWISE DEEMED UNACCEPTABLE BY THE ENGINEER, SHALL BE REPLACED.
- 5. CONTRACTOR AND PERSONAL VEHICLE PARKING IS PROHIBITED WITHIN THE RIGHT-OF-WAY UNLESS DESIGNATED ON THE PLANS, OR APPROVED BY THE ENGINEER.
- 6. CONSTRUCTION TRAFFIC SIGNS SHALL BE MEASURED BY THE FOLLOWING SIZES AND DESCRIPTIONS:

PANEL SIZE A	0.01 TO 9.00 SQ. FT. (INCLUDING TYPE 1 AND TYPE 2	2
	BARRICADES).	
PANEL SIZE B	9.01 TO 16.00 SQ. FT.	

GREATER THAN 16 SQ. FT. PANEL SIZE C

CONSTRUCTION TRAFFIC SIGN (SPECIAL), SQ. FT., MAY BE USED FOR SOME PROJECT SPECIFIC INFORMATION SIGNS.

FOR DETAILED DIMENSIONS OF SIGNS WITH SIGN CODE NUMBERS, SEE "STANDARD HIGHWAY SIGNS" AND THE "COLORADO SUPPLEMENT" THERETO. SIGN LAYOUTS FOR OTHER SIGNS WILL BE FURNISHED IN THE PLANS. TRANSMITTED TO THE ENGINEER AFTER AWARD, OR MAY BE AVAILABLE UPON REQUEST.

W20-5 WARNING SIGNS SHALL BE FURNISHED WITH EXCHANGEABLE PLAQUES READING "RIGHT", "LEFT", "CENTER", "RIGHT 2", ETC. AT NO ADDITIONAL COST.

- 7. ALL WARNING AND REGULATORY SIGNS SHALL BE POSTED ON BOTH SIDES OF THE ROADWAY ON DIVIDED HIGHWAYS, MULTI-LANE RAMPS, ONE-WAY STREETS, AND AS DIRECTED BY THE ENGINEER, EXCEPT WHERE ONLY ONE SHOULDER IS CLOSED (EX: CASE 11 ON SHEET 6).
- 8. ADDITIONAL TRAFFIC CONTROL DEVICES ADDRESSING FLAGGING, SPEED REDUCTION, ETC. WILL BE NECESSARY FOR SET-UP AND TAKE-DOWN OF MOST CASE APPLICATIONS; DAILY WORK SITE ACCESS; AND PAVEMENT MARKING REMOVAL AND INSTALLATION OPERATIONS.

GENERAL NOTES

- 9. BASED ON SIGHT DISTANCE AND OTHER CONSIDERATIONS, THE FINAL LOCATIONS OF SIGNS ARE SUBJECT TO APPROVAL OF THE ENGINEER.
- 10. IF CONSTRUCTION RELATED TRAFFIC CONGESTION BACKS UP BEYOND THE INSTALLED ADVANCE SIGN SEQUENCE, ADDITIONAL ADVANCE SIGNING SHALL BE PLACED BEYOND THE CONGESTION.
- 11. ALL SIGN MATERIAL SHALL BE SOUND AND DURABLE TO THE DEGREE NECESSARY FOR MAINTAINING EFFECTIVE AND NEAT APPEARING TRAFFIC CONTROLS, AND:
 - g. SIGN PANELS MAY BE FABRICATED FROM PLYWOOD, STEEL, ALUMINUM, OR OTHER SUITABLE MATERIAL.
 - REFLECTIVE SHEETING SHALL CONFORM TO ASTM D4956. THE TYPE SHALL BE AS DESCRIBED IN THE STANDARD SPECIFICATIONS AND/OR AS SHOWN ON THE PLANS.
 - C. SYMBOLS AND LEGEND SHALL BE OF GOOD WORKMANSHIP (UNEVEN OR HAND LETTERING WILL NOT BE ACCEPTED).
 - PORTABLE OR TEMPORARY MOUNTING SHALL NOT BE CONSTRUCTED OR WEIGHTED BY ANY METHOD OR MATERIAL THAT MAKES THEM HAZARDOUS TO TRAFFIC.
 - e. CERTAIN POST SIZES AND SHAPES REQUIRE A "BREAK-AWAY" DEVICE. SEE THE APPLICABLE STANDARD PLAN. OTHER POST DESIGNS OR SYSTEMS REQUIRE THE SUBMITTAL OF AN FHWA LETTER OF ACCEPTANCE. TO THE ENGINEER, AND MUST BE APPROVED BY THE ENGINEER PRIOR TO THEIR USE.
- 12. ALL CONSTRUCTION SIGN PLACEMENT SHALL BE IN ACCORDANCE WITH STANDARD PLAN "TYPICAL GROUND SIGN PLACEMENT" UNLESS OTHERWISE

SIGNS APPROVED TO BE MOUNTED ON PORTABLE SUPPORTS, OR APPROPRIATE SIGNS MOUNTED ON BARRICADES, MAY BE AT LOWER HEIGHTS, BUT THE BOTTOM OF THE SIGNS SHALL NOT BE LESS THAN ONE FOOT ABOVE THE PAVEMENT ELEVATION.

- SIGNS MOUNTED ON THE MEDIAN OF DIVIDED HIGHWAYS WHERE MEDIAN 13. BARRIER IS IN PLACE MAY BE MOUNTED ON THE BARRIER WITH A SADDLE TYPE BRACKET, IF THE BRACKET ALLOWS THE SIGN PANEL TO BE TURNED PARALLEL TO THE ROADWAY, THE SIGN MAY REMAIN IN PLACE WHEN NOT APPLICABLE, BUT LAYING THE SIGN PANEL DOWN IN A HORIZONTAL POSITION IS NOT PERMITTED.
- 14. TRAFFIC CONES SHALL BE AT LEAST 28 INCHES IN HEIGHT. HOWEVER, THE MINIMUM SIZE SHALL BE 36 INCHES WHEN THEY ARE USED ON FREEWAYS AND EXPRESSWAYS, OR DURING NIGHT TIME WORKING HOURS. THEY SHOULD ALSO BE 36 INCHES WHEN USED ON OTHER HIGH SPEED ROADWAYS (45 MPH OR MORE) WITH AN ADT OF 6,000 OR MORE.
- TYPE 1 BARRICADES AND VERTICAL PANELS SHALL NOT BE USED ON 15. FREEWAYS, EXPRESSWAYS, OR OTHER HIGH SPEED ROADWAYS (45 MPH OR MORE).
- 16. WHEN TWO-WAY TRAFFIC IS PLACED ON ONE ROADWAY OF A NORMALLY DIVIDED HIGHWAY, OPPOSING TRAFFIC SHALL BE SEPARATED EITHER WITH CONCRETE BARRIER (TEMPORARY), OR WITH CHANNELIZING DEVICES APPROVED FOR THIS APPLICATION, THROUGHOUT THE LENGTH OF TWO-WAY OPERATION. THE TRANSITION ZONES SHALL HAVE CONCRETE BARRIER (TEMPORARY). THE BARRIER SHALL BE TIED TO AN EXISTING STRUCTURE OR GUARD RAIL, FLARED OR EXTENDED TO MEET CLEAR ZONE REQUIREMENTS, OR FITTED WITH AN IMPACT ATTENUATION DEVICE.

- STANDARD PLANS.
- TO TRAFFIC.
- 20. AS DETAILED ON THE PLANS.

FOR ADDITIONAL PAVEMENT MARKING DETAILS, SEE STANDARD PLAN "TYPICAL PAVEMENT MARKINGS".

- 21.
- LANE USAGE.

ADDITIONAL ADVANCE WARNING SIGNAGE IS ENCOURAGED IN ALL CASES WHERE TRAFFIC VOLUMES AND SPEEDS ARE HIGH AND/OR WHERE THERE ARE INFREQUENT EXITS, ADDITIONAL SIGNAGE IS ALSO ENCOURAGED IN LOCATIONS WHERE DRIVERS' LINE OF SIGHT TO ADVANCE WARNING SIGNS IS OBSTRUCTED.

- USUAL COURSE.

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Creation Date: 07-04-06	Initials: KCM		Date:	Comments	4201 East Arkansas Aven Denver, Colorado 80222	le	FOR HIGH
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Full Path:www.dot.state.co.us/DesignS Drawing File Name: S-630-1 (1 of 1:		E			DEPARTMENT OF TRANSPORTATION FOX: (303) 757-9820		
CAD Ver.: MicroStation V8 Scale: Not to Sca		\Box			Staff Traffic Branch	KCM/JSW	Issued By: Traffic Engineering U

17. CHANNELIZING DEVICE SPACING, IN FEET, SHALL BE AS FOLLOWS: a. FOR TAPERS AND TRANSITIONS, SPACING EQUALS THE NUMERICAL VALUE OF THE SPEED LIMIT. (e.g. 45 MPH = 45 FEET) FOR TANGENTS ALONG THE BUFFER SPACE OR WORK AREA, SPACING MAY NOT BE GREATER THAN TWO TIMES THE SPEED LIMIT. (e.g. 50 MPH = 50 FEET TO 100 FEET MAXIMUM)

18. FOR DETAILS ON BARRICADES, CONCRETE BARRIER (TEMPORARY), VERTICAL PANELS, AND FLASHING BEACON (PORTABLE), SEE THE APPLICABLE

19. FLOOD LIGHTS SHALL BE USED TO ILLUMINATE FLAGGER STATIONS DURING THE HOURS OF DARKNESS UNLESS OTHERWISE APPROVED. A TYPICAL LIGHT SHOULD PROVIDE THE FOLLOWING: A FULLY DIRECTIONAL SWIVEL MOUNT QUARTZ LIGHT SOURCE (500 WATT MINIMUM), SELF-SUPPORTING STAND WITH VARIABLE LIGHT HEIGHT FROM OF MINIMUM OF EIGHT FEET ABOVE THE ROADWAY, AND A POWER SOURCE. IT SHALL ILLUMINATE THE STATION AREA AND A FLAGGER ESCAPE PATH, BUT SHALL NOT PRESENT ANY GLARE

IF WORK ON THE ROADWAY IS FOR AN EXTENDED PERIOD, INAPPLICABLE PAVEMENT MARKINGS ARE TO BE REMOVED, AND FULL COMPLIANCE PAVEMENT MARKINGS ARE TO BE INSTALLED IN ACCORDANCE WITH THE APPLICABLE SPECIFICATIONS, (PAVEMENT MARKING - GENERAL), ANO/OR


BUFFER SPACE IS OPTIONAL. NEED MUST BE DETERMINED ON A PROJECT OR SITE SPECIFIC BASIS AS DIRECTED BY THE ENGINEER. WHEN A BUFFER SPACE IS USED, DIMENSIONS AND/OR DEVICES USED ARE TO BE INCORPORATED IN THE TRAFFIC CONTROL PLAN (TCP) OR THE CONTRACTOR'S METHOD OF HANDLING TRAFFIC (MHT).


22. ADDITIONAL VMS SIGNAGE SHOULD BE CONSIDERED AT LEAST A MILE IN ADVANCE OF THE SIGNING SHOWN IN THE DETAIL FOR ANY LANE CLOSURES ON INTERSTATE AND OTHER HIGH SPEED FACILITIES ESPECIALLY WHEN THE LEVEL OF SERVICE IS SIGNIFICANTLY REDUCED AS A RESULT OF CONSTRUCTION. THE LEGENDS SHOULD BE CHANGED TO ADVISE MOTORISTS OF UPCOMING TRAFFIC CONDITIONS AND TO ALERT THEM OF UPCOMING


23. RAISED PAVEMENT MARKERS MAY BE USED TO SUPPLEMENT TEMPORARY STRIPING DURING NON-SNOW PERIODS. THEIR USE IS ENCOURAGED ON HIGHER SPEED FACILITIES WHEN TRAFFIC IS BEING DIVERTED FROM ITS

24. THE TYPICAL CASES DEPICTED IN THIS STANDARD REFLECT THE MINIMUM REQUIREMENTS, UNLESS AS OTHERWISE DIRECTED BY THE PROJECT PLANS AND SPECIFICATIONS, AND/OR THE PROJECT ENGINEER.

NO REVISIONS 9/30/09 XK

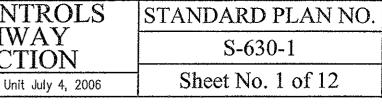

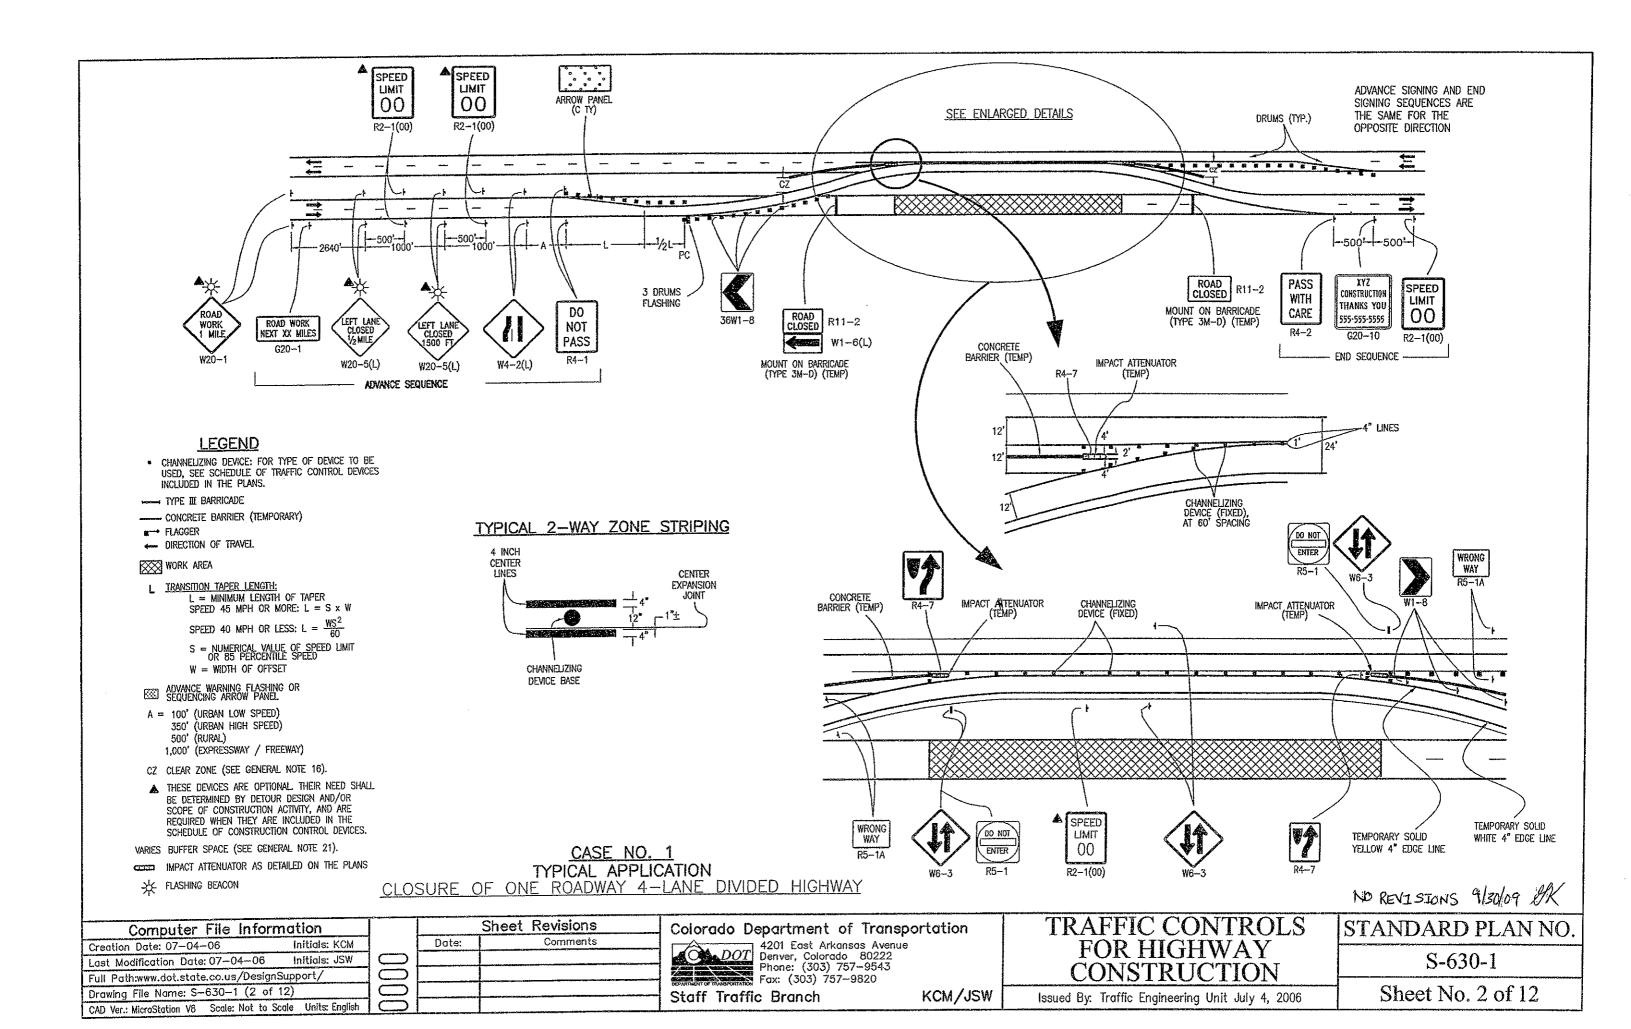


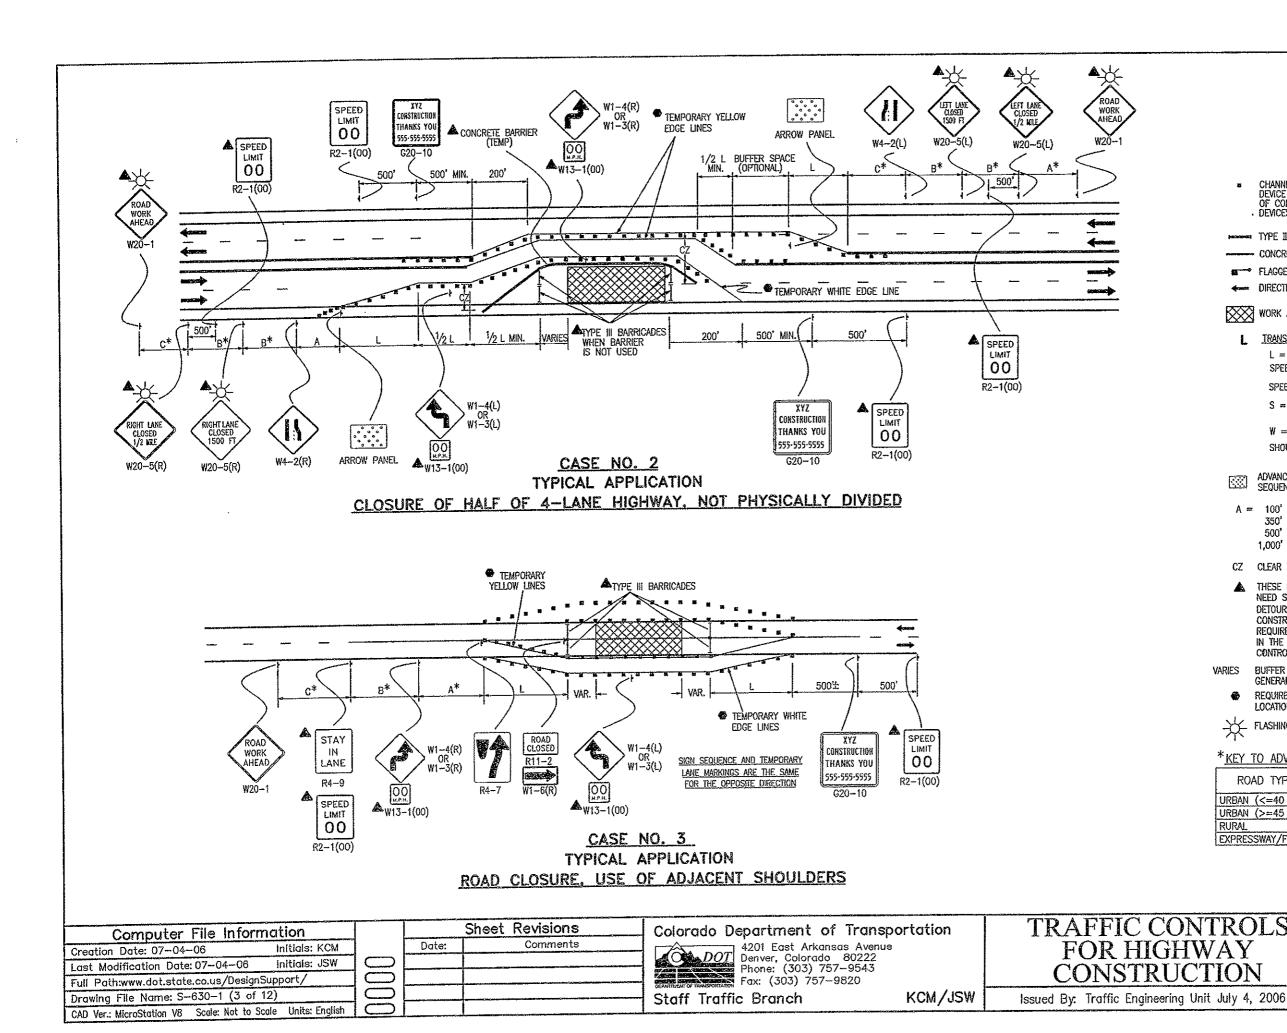

LEGEND

DEVICE TO BE OF CONSTRUCT	DEVICE: FOR TYPE OF USED, SEE THE SCHEDULE ION TRAFFIC CONTROL DED IN THE PLANS.
CONCRETE BAR	
FLAGGER	RAVEL
WORK AREA	
SPEED 45 M	<u>PER LENGTH</u> : A LENGTH OF TAPER PH OR MORE: L = S × W PH OR LESS: L = $\frac{WS^2}{60}$
s = numeri	CAL VALUE OF SPEED LIMIT PERCENTILE SPEED
W = WIDTH (Shoulder T/	OF OFFSET APER = 1/3 L
ADVANCE WARNI SEQUENCING AR	ng Flashing or Row Panel
A = 100' (URBAN 350' (URBAN 500' (RURAL) 1,000' (EXPRES	low speed) High speed) Sway / Freeway)
CZ CLEAR ZONE (S	EE GENERAL NOTE 16).
NEED SHALL BE DETOUR DESIGN CONSTRUCTION A REQUIRED WHEN	ARE OPTIONAL THEIR DETERMINED BY AND/OR SCOPE OF ACTIVITY, AND ARE THEY ARE INCLUDED LE OF CONSTRUCTION IS.
VARIES BUFFER SPACE GENERAL NOTE	21).
LOCATION FOR N	WORK OCCUPIES THE IORE THAN 3 DAYS.
-X FLASHING BEACO	N
* KEY TO ADVANCE	
ROAD TYPE	A B C
URBAN (<=40 MPH) URBAN (>=45 MPH)	100 100 100 350 350 350
RURAL	500 500 500
EXPRESSWAY/FREEWAY	1000 1500 2640
	NO REVISIONS 91/30/09
FROLS	STANDARD PLAN NO.
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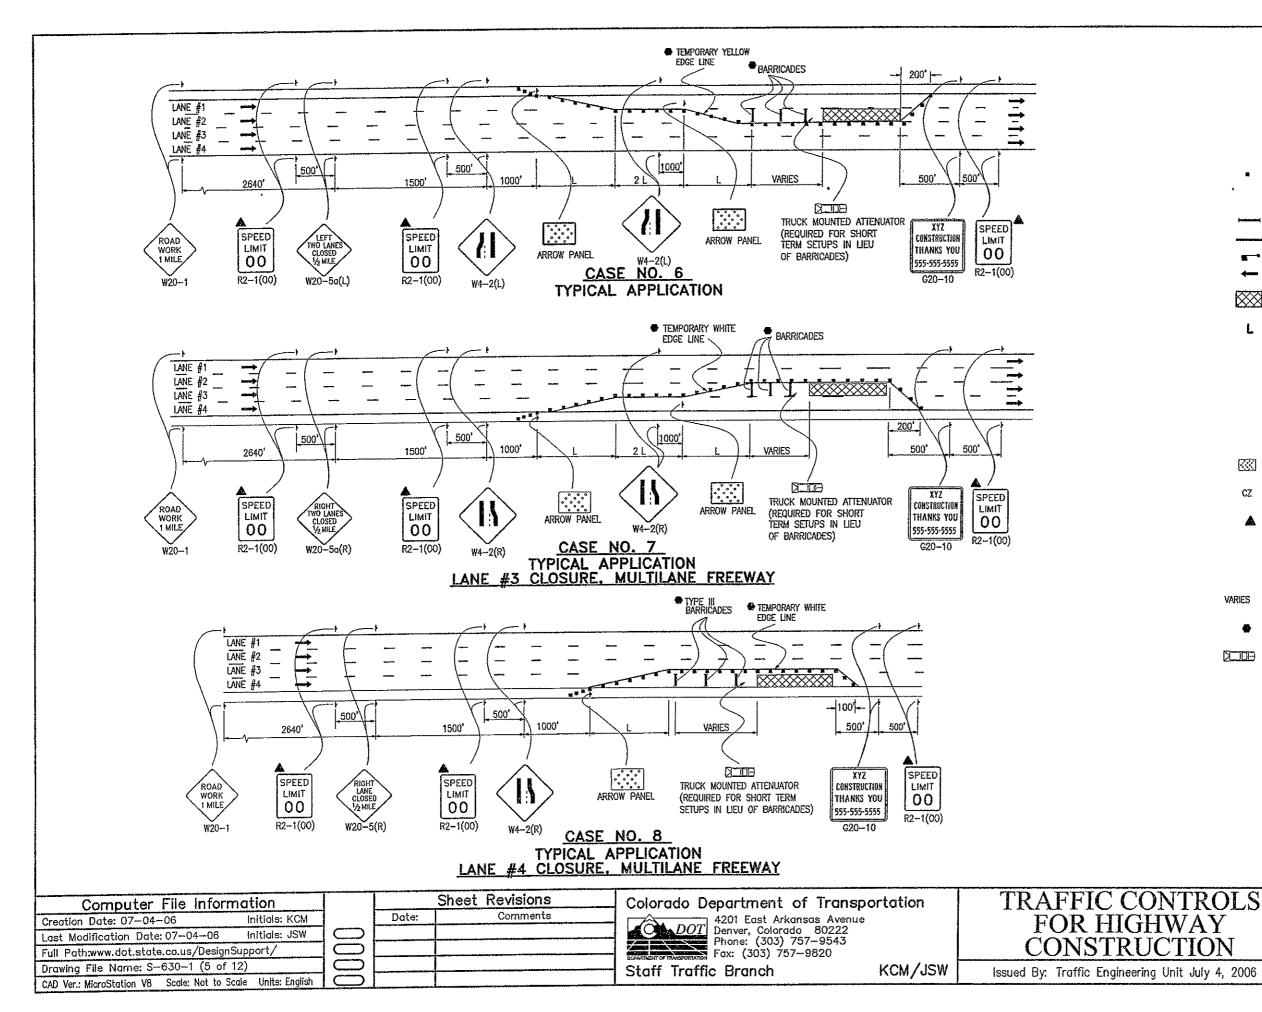
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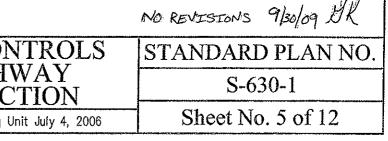
0F C	NELIZING DEVICE: FOR TYPE OF E TO'BE USED, SEE THE SCHEDULE ONSTRUCTION TRAFFIC CONTROL ES INCLUDED IN THE PLANS.
TYPE	III BARRICADE
CONC	RETE BARRIER (TEMPORARY)
FLAG	DER
- DIREC	TION OF TRAVEL
WORK	AREA
L = SPEE SPEE S =	TION TAPER LENGTH: MINIMUM LENGTH OF TAPER ED 45 MPH OR MORE: L = S x W ED 40 MPH OR LESS: L = $\frac{WS^2}{60}$ NUMERICAL VALUE OF SPEED LIMIT OR 85 PERCENTILE SPEED
	WIDTH OF OFFSET JLDER TAPER = 1/3 L
ADVAN	NCE WARNING FLASHING OR ENCING ARROW PANEL
CZ CLEAF	R ZONE (SEE GENERAL NOTE 16).
NEED DETOU CONSI REQUI	E DEVICES ARE OPTIONAL. THEIR SHALL BE DETERMINED BY IR DESIGN AND/OR SCOPE OF IRUCTION ACTIVITY, AND ARE RED WHEN THEY ARE INCLUDED E SCHEDULE OF CONSTRUCTION ROL DEVICES.
VARIES BUFFE Gener	R SPACE (SEE RAL NOTE 21).
	RED WHEN WORK OCCUPIES THE ION FOR MORE THAN 3 DAYS.
XIII TRUCK	MOUNTED ATTENUATOR
-X- Flash	ING BEACON
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ROLS	STANDARD PLAN NO.
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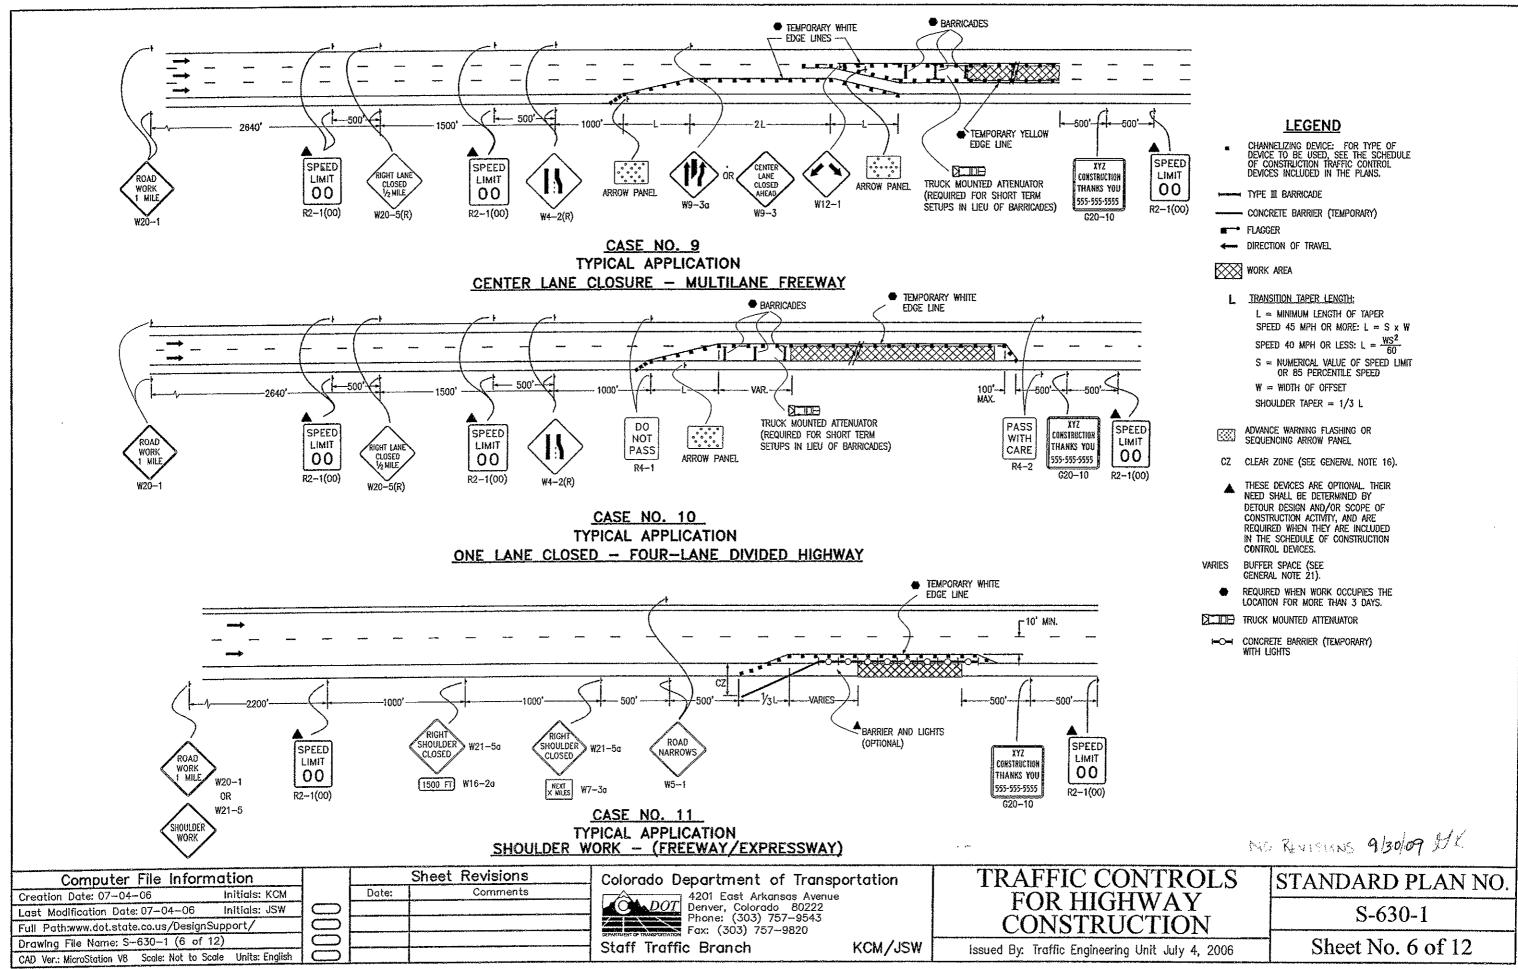
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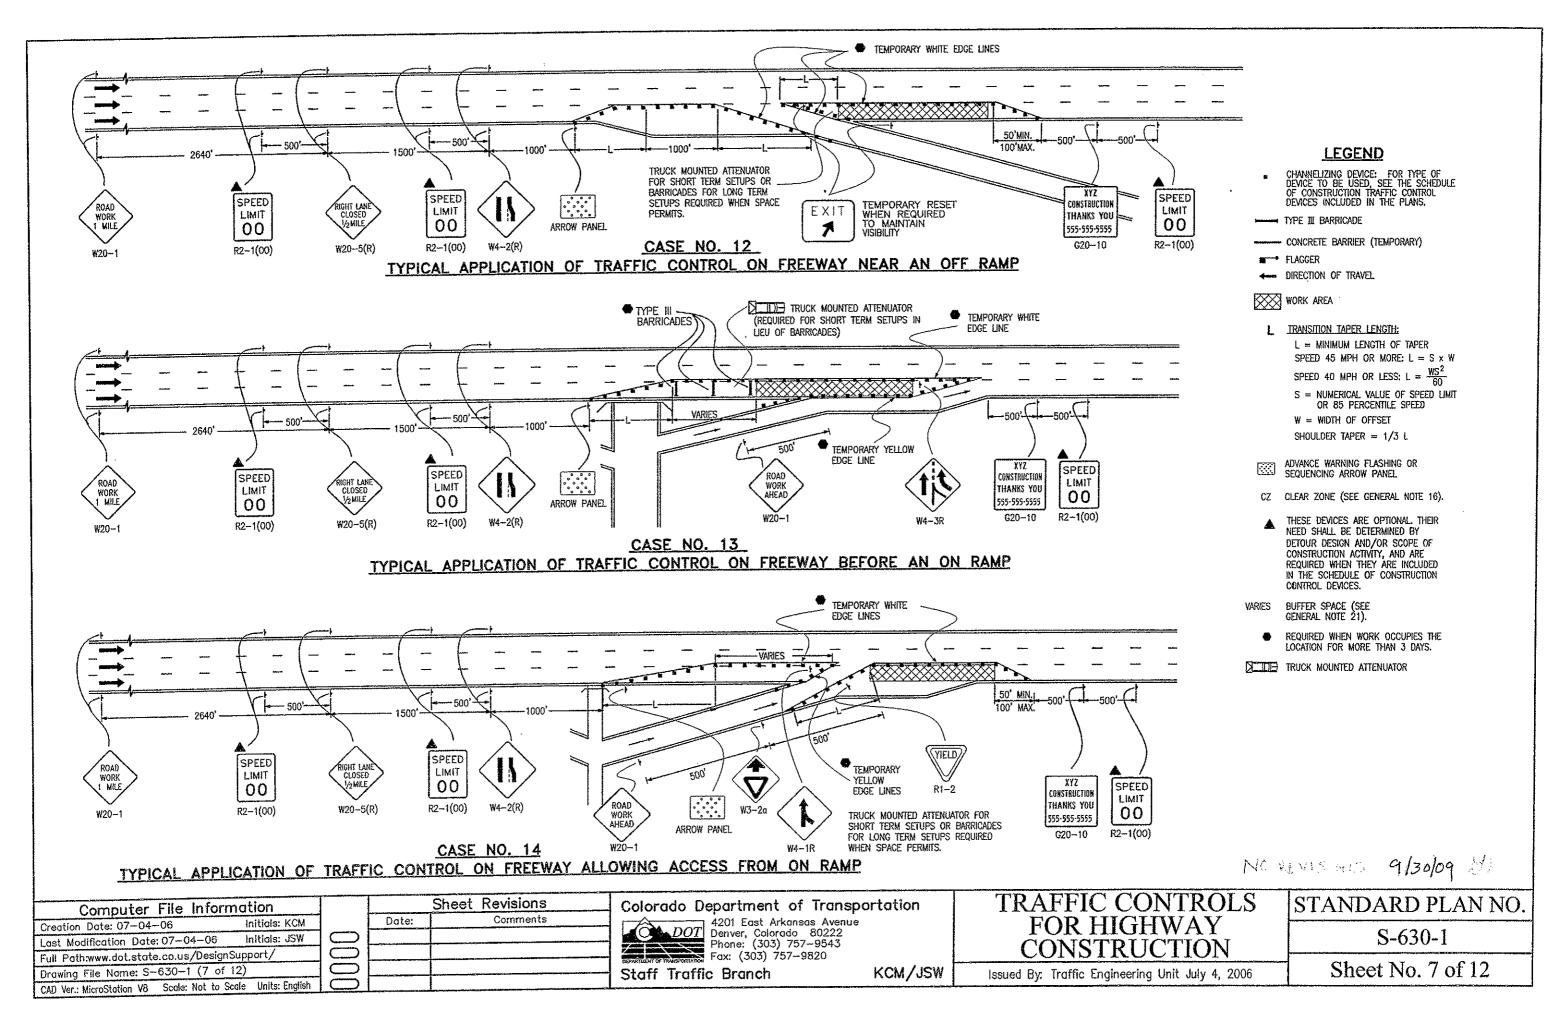


LEGEND CHANNELIZING DEVICE: FOR TYPE OF

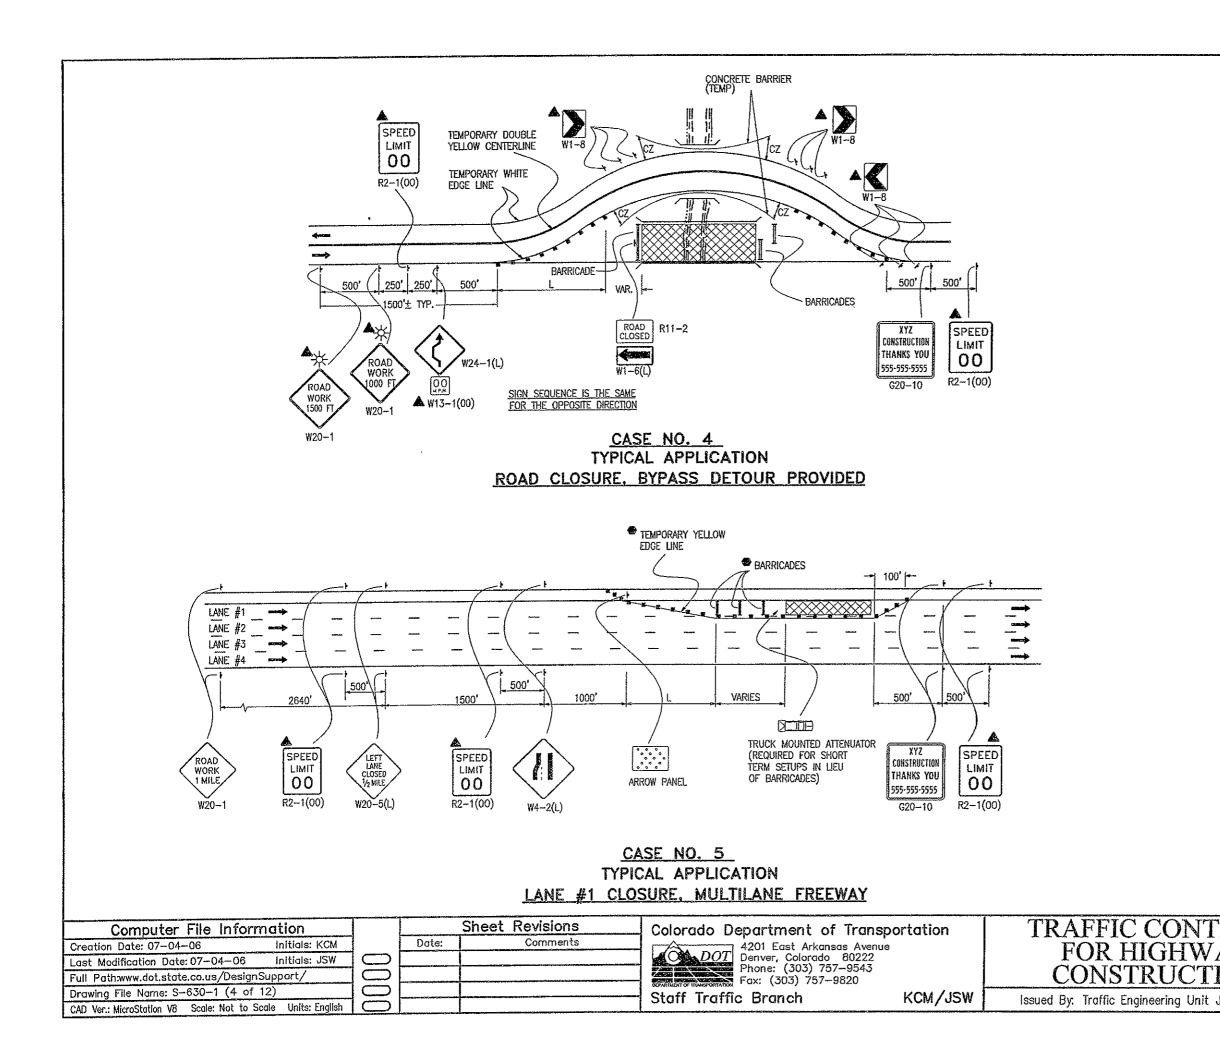
•	DEVICE TO BE USED, SEE THE SCHEDULE OF CONSTRUCTION TRAFFIC CONTROL DEVICES INCLUDED IN THE PLANS.
 	TYPE III BARRICADE
-	- CONCRETE BARRIER (TEMPORARY)
*	FLAGGER
	DIRECTION OF TRAVEL
\otimes	WORK AREA
L	TRANSITION TAPER LENGTH:
_	L = MINIMUM LENGTH OF TAPER
	SPEED 45 MPH OR MORE: $L = S \times W$
	SPEED 40 MPH OR LESS: L = $\frac{WS^2}{60}$
	S = NUMERICAL VALUE OF SPEED LIMIT OR 85 PERCENTILE SPEED
	W = WIDTH OF OFFSET
	Shoulder Taper = $1/3$ L
	ADVANCE WARNING FLASHING OR SEQUENCING ARROW PANEL
CZ	CLEAR ZONE (SEE GENERAL NOTE 16).
	THESE DEVICES ARE OPTIONAL THEIR NEED SHALL BE DETERMINED BY DETOUR DESIGN AND/OR SCOPE OF CONSTRUCTION ACTIVITY, AND ARE REQUIRED WHEN THEY ARE INCLUDED IN THE SCHEDULE OF CONSTRUCTION CONTROL DEVICES.
VARIES	BUFFER SPACE (SEE GENERAL NOTE 21).
•	REQUIRED WHEN WORK OCCUPIES THE LOCATION FOR MORE THAN 3 DAYS.
	TRUCK MOUNTED ATTENUATOR








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LEGEND

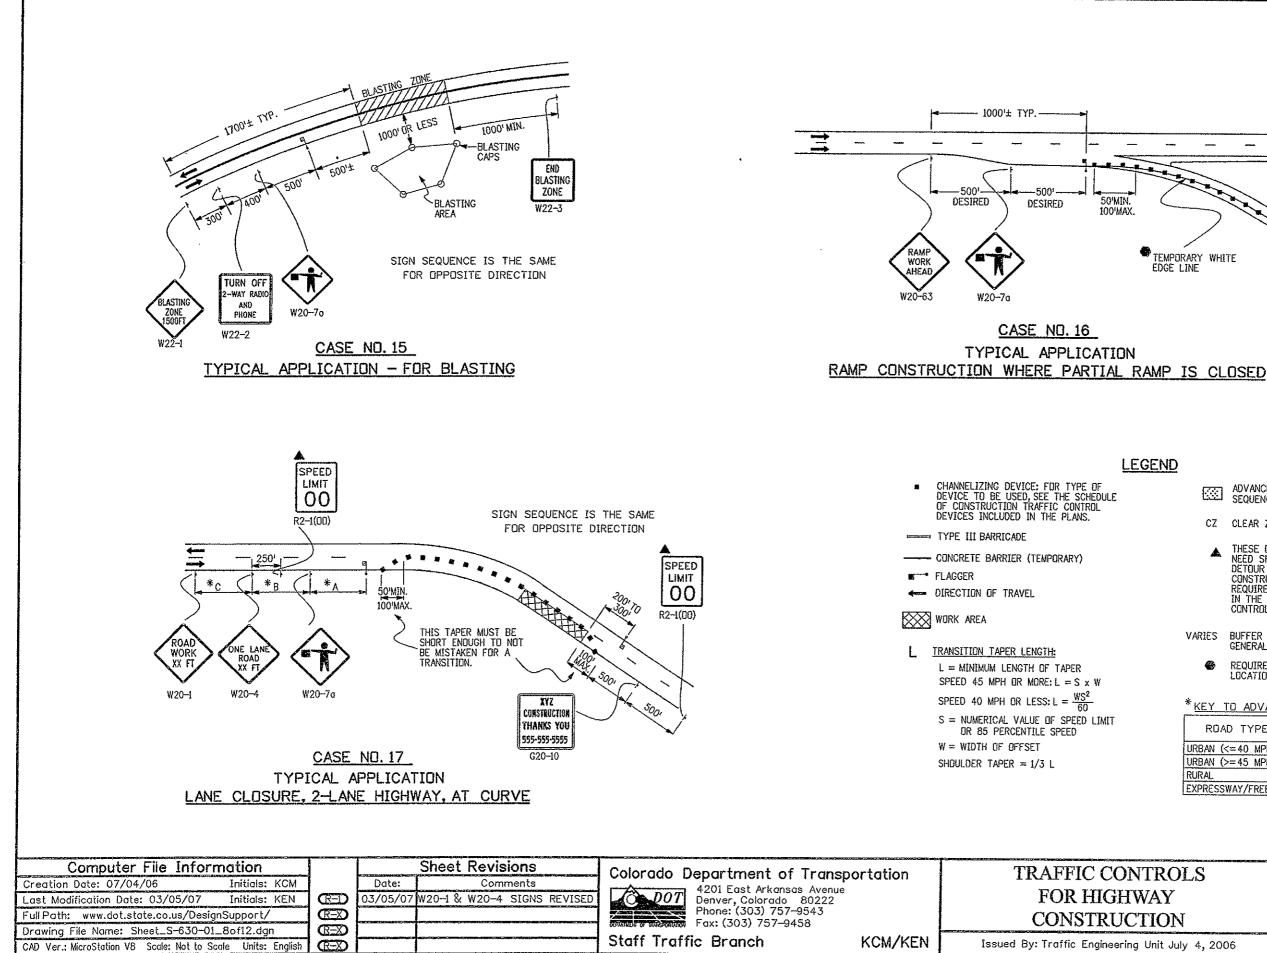	ADVANCE	WARNING	FLASHING	DR
	SEQUENCI	NG ARROV	PANEL	

CZ CLEAR ZONE (SEE GENERAL NOTE 16).

THESE DEVICES ARE OPTIONAL. THEIR NEED SHALL BE DETERMINED BY DETOUR DESIGN AND/OR SCOPE OF CONSTRUCTION ACTIVITY, AND ARE REQUIRED WHEN THEY ARE INCLUDED ▲ IN THE SCHEDULE OF CONSTRUCTION CONTROL DEVICES.

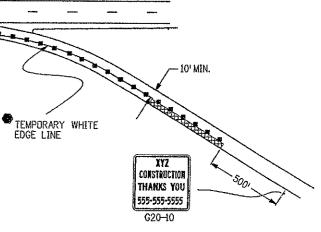
VARIES BUFFER SPACE (SEE GENERAL NDTE 21).


REQUIRED WHEN WORK OCCUPIES THE LOCATION FOR MORE THAN 3 DAYS.


* KEY TO ADVANCE SIGNING DISTANCES

ROAD TYPE	DISTANCE BETWEEN SIGNS				
	A	В	C		
URBAN (<≃40 MPH)	100	100	100		
URBAN (>=45 MPH)	350	350	350		
RURAL	500	500	500		
EXPRESSWAY/FREEWAY	1000	1500	2640		

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ROLS	STANDARD PLAN NO.	
AY ON	S-630-1	
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LEGEND

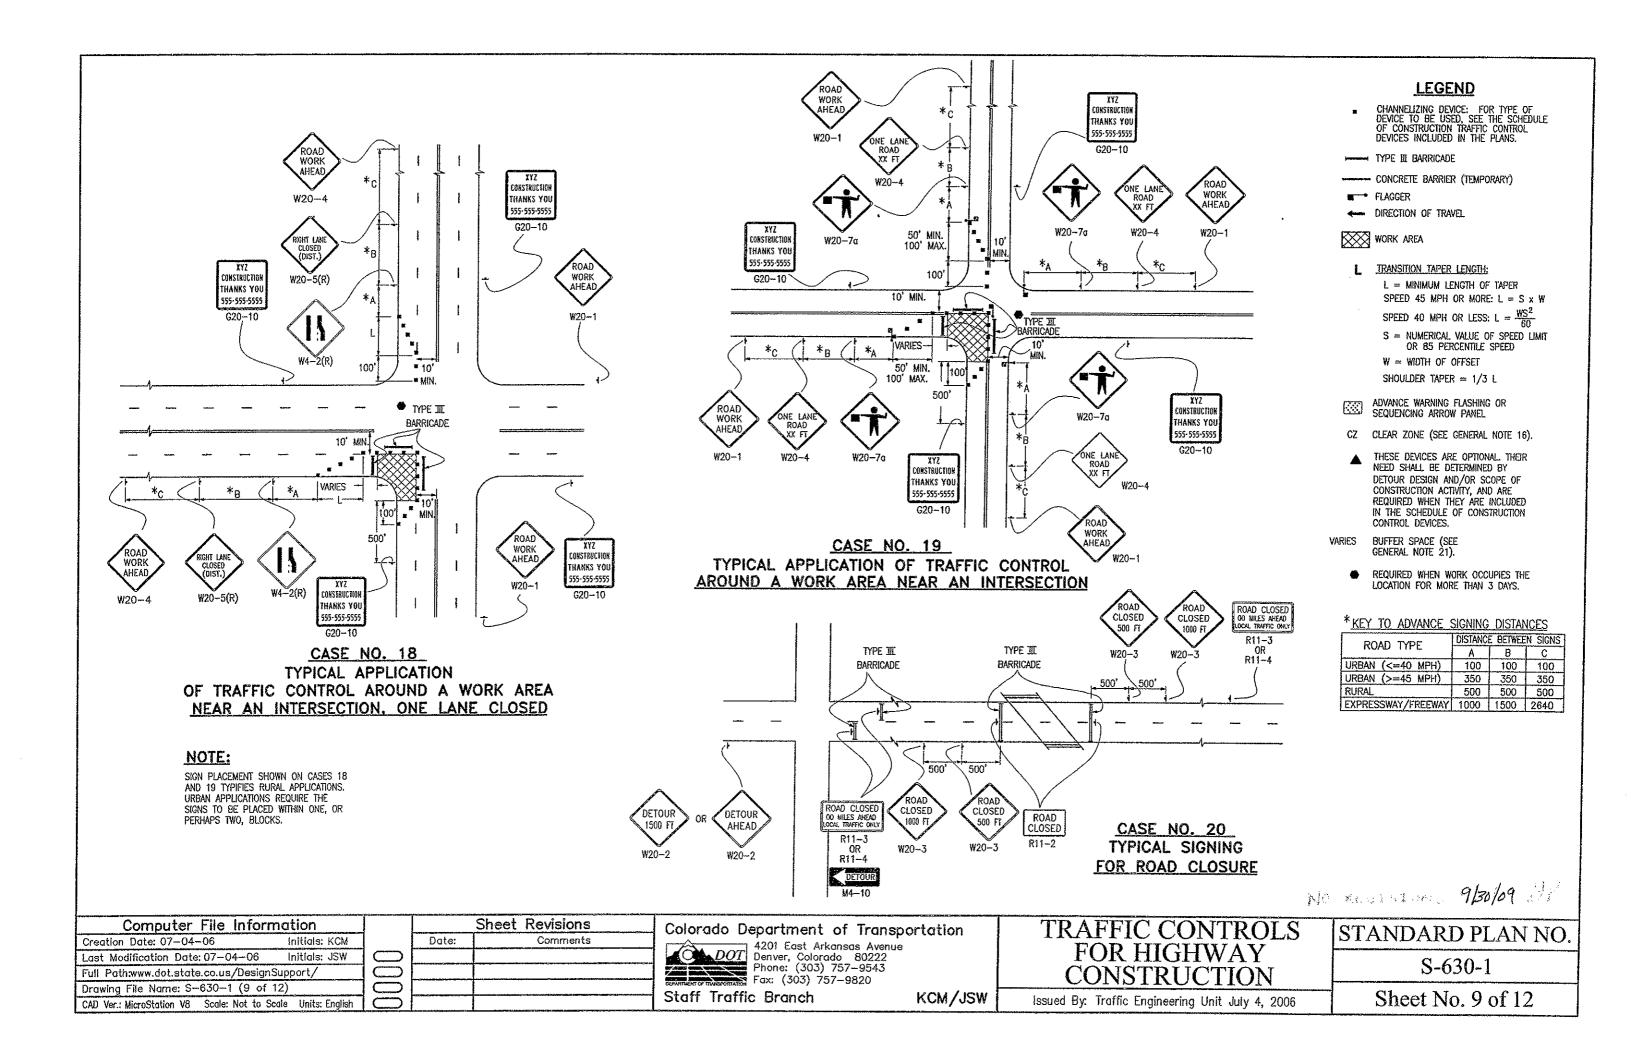DIRECTION OF TRAVEL

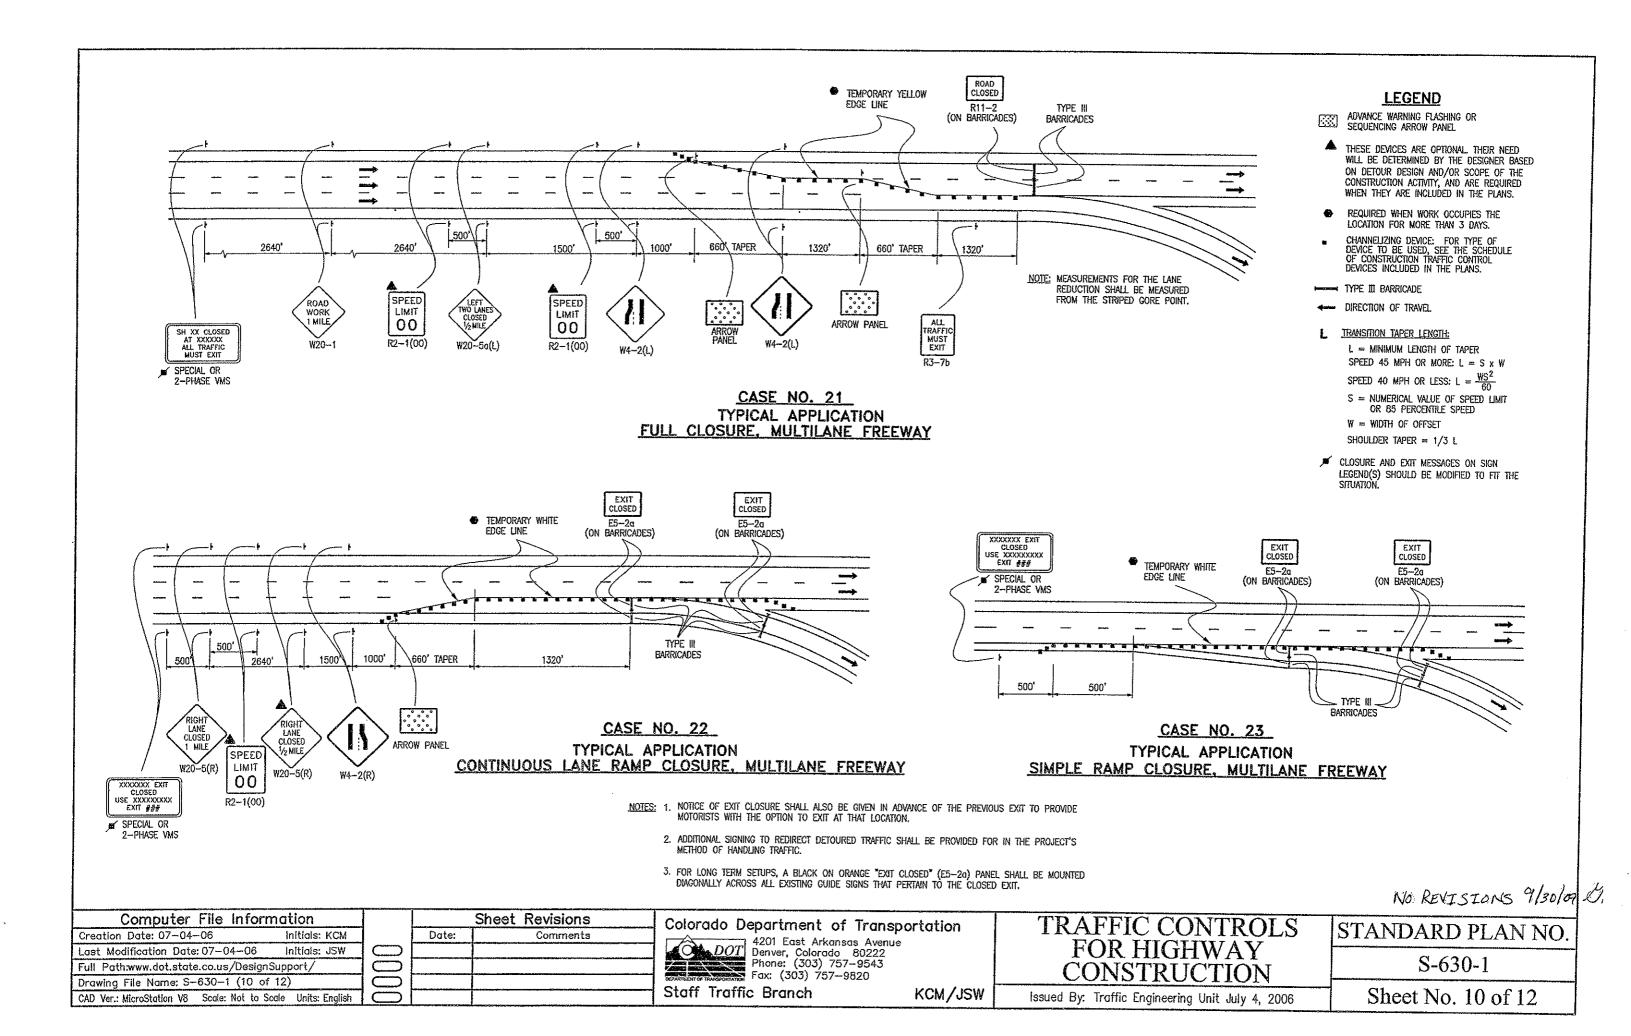▲ THESE DEVICES ARE OPTIONAL. THEIR NEED WILL BE DETERMINED BY THE DESIGNER BASED ON DETOUR DESIGN AND/OR SCOPE OF CONSTRUCTION AGN AND ARE REQUIRED WHEN THEY ARE INCLUDED IN THE PLANS.

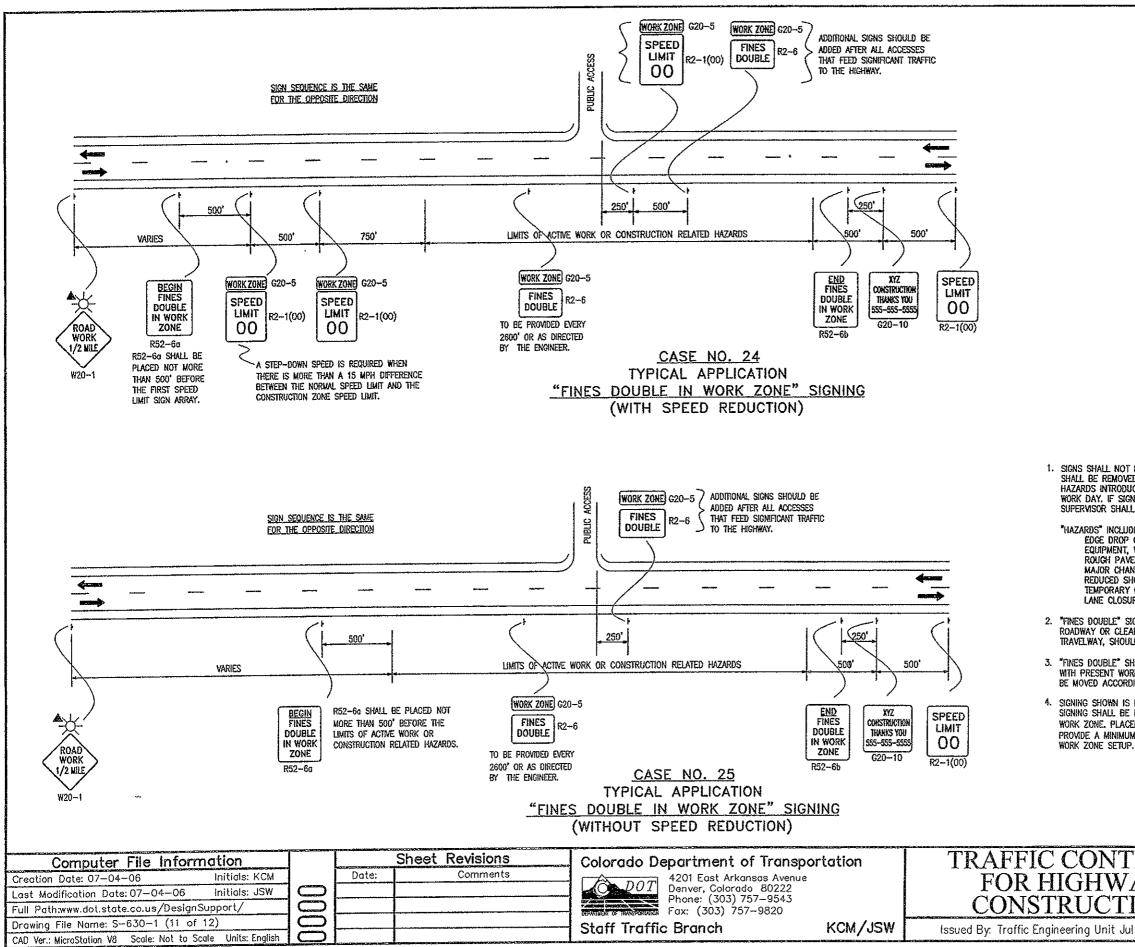-X FLASHING BEACON

FINES DOUBLE NOTES:

1. SIGNS SHALL NOT BE PLACED SCONER THAN FOUR HOURS BEFORE WORK IS TO BEGIN AND SHALL BE REMOVED AS SCON AS WORK ACTVITES ARE CONCLUDED, UNLESS POTENTIAL HAZARDS INTRODUCED AS A RESULT OF THE WORK ACRE STILL PRESENT AT THE END OF THE WORK ACAD DAY. IF SIGNS ARE LEFT IN PLACE AFTER WORK ACRUITES, THE TRAFFIC CONTROL SUPERVISOR SHALL MAKE AN ENTRY IN THEIR DAILY DIARY THAT JUSTIFIES THEIR USE.

"HAZARDS" INCLUDE BUT ARE NOT LIMITED TO: EDGE DROP OFFS EQUIPMENT, WORKERS OR NON-SHIELDED OBJECTS IN THE CLEAR ZONE ROUGH PAVEMENT MAJOR CHANGE IN ALIGNMENT REDUCED SHOULDER WIDTH TEMPORARY GUARD RAIL OR BARRIER LANE CLOSURE

2. "FINES DOUBLE" SIGNS SHALL ONLY BE PLACED WHERE WORKERS ARE PRESENT IN THE ROADWAY OR CLEAR ZONE OR ARE AT RISK, OR WHERE THERE ARE HAZARDS IN THE TRAVELWAY, SHOULDERS OR CLEAR ZONE.

 "FINES DOUBLE" SHOULD BE PLACED SO THAT MOTORISTS IMMEDIATELY ASSOCIATE THE SIGNS WITH PRESENT WORK ACTIVITIES. IF THE ZONE OF WORK ACTIVITY MOVES, THE SIGNS SHOULD BE MOVED ACCORDINGLY.

4. SIGNING SHOWN IS REQUIRED TO ENFORCE DOUBLE FINES IN A WORK ZONE. ADDITIONAL SIGNING SHALL BE IN ACCORDANCE WITH THAT NORMALLY REQUIRED FOR THE PARTICULAR WORK ZONE. PLACEMENT OF "FINES DOUBLE" SIGNING MAY BE ADJUSTED AS NEEDED TO PROVIDE A MINIMUM 250° SPACING BETWEEN OTHER SIGNING REQUIRED FOR THE SPECIFIC WORK ZONE SETUP.

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THESE SIGNING NOTES ARE INTENDED AS A QUICK REFERENCE.

- G20-1 "ROAD/WORK/NEXT XX MILES" THIS SIGN SHALL BE ERECTED AT THE LIMITS OF ANY ROAD CONSTRUCTION OR MAINTENANCE PROJECT OF MORE THAN 2 MILES IN LENGTH WHERE TRAFFIC IS MAINTAINED THROUGH THE PROJECT.
- G20-10 THANK YOU SIGN THIS SIGN SHOULD BE ERECTED APPROXIMATELY 500 FEET BEYOND THE END OF THE PROJECT.
- G20-4 "PILOT CAR/FOLLOW ME" THIS SIGN SHALL BE MOUNTED IN A CONSPICUOUS POSITION ON THE REAR OF A VEHICLE USED FOR GUIDING ONE-WAY TRAFFIC THROUGH OR AROUND THE PROJECT.
- M4-9() "DETOUR/<<<<<" THIS SIGN IS USED FOR UNNUMBERED ROUTES; FOR USE IN EMERGENCY SITUATIONS; FOR PERIODS OF SHORT DURATION; OR WHERE, OVER RELATIVELY SHORT DISTANCES. IT IS NOT NECESSARY TO SHOW ROUTE MARKERS TO GUIDE TRAFFIC ALONG THE DETOUR AND BACK TO ITS AUTHORIZED ROUTE.
- M4-10() "DETOUR ARROW" THIS SIGN SHOULD BE MOUNTED JUST BELOW THE ROAD CLOSED SIGN AT THE POINT WHERE THE DETOUR ROADWAY OR ROUTE HAS BEEN ESTABLISHED DUE TO THE CLOSURE OF THE STREET OR HIGHWAY TO THROUGH TRAFFIC.
- R2-1() "SPEED/LIMIT/XX" THESE SIGNS ARE INTENDED TO REDUCE TRAFFIC SPEED IN ADVANCE OF THE DAILY WORK AREA WITHIN THE OVERALL PROJECT LIMITS.
- R2-1(XX) "SPEED/LIMIT/XX" THIS SIGN IS INTENDED FOR USE 500 FEET PAST THE "THANK YOU" SIGN TO BRING TRAFFIC BACK TO ORIGINAL POSTED SPEED.
- R11-2 "ROAD/CLOSED" THIS SIGN IS TO BE MOUNTED ON THE BARRICADE THAT IS PLACED BEFORE THE WORK ZONE ENTRANCE TO PROHIBIT TRAFFIC FROM ENTERING THE WORK ZONE.
- R11-3 "ROAD CLOSED/X MILES AHEAD/LT.O. THIS SIGN SHOULD BE PLACED WHERE THROUGH TRAFFIC MUST DETOUR TO AVOID THE CLOSURE OF THE ROAD SOME DISTANCE BEYOND, BUT WHERE THE ROAD IS OPEN TO LOCAL TRAFFIC UP TO THE POINT OF CLOSURE.
- R11-4 "ROAD CLOSED/TO/THRU TRAFFIC" FOR URBAN USE THIS SIGN SHOULD BE PLACED WHERE THROUGH TRAFFIC MUST DETOUR TO AVOID THE CLOSURE OF THE ROAD SOME DISTANCE BEYOND, BUT WHERE THE ROAD IS OPEN TO LOCAL TRAFFIC UP TO THE POINT OF CLOSURE.
- W1-1() "TURN ARROW" THIS SIGN IS INTENDED FOR USE WHERE ENGINEERING INVESTIGATIONS OF ROADWAY CONDITIONS SHOW THE RECOMMENDED SPEED ON THE TURN TO BE 30 MPH OR LESS.
- W1-2() "CURVE ARROW" THIS SIGN IS INTENDED FOR USE WHERE ENGINEERING INVESTIGATIONS OF ROADWAY CONDITIONS SHOW THE RECOMMENDED SPEED ON THE CURVE TO BE IN THE RANGE BETWEEN 30 AND 60 MILES PER HOUR. ★
- W1−3() "REVERSE TURN ARROW" ~ THIS SIGN IS INTENDED FOR USE WHERE TWO TURNS OR THE CURVE AND A TURN IN OPPOSITE DIRECTIONS ARE SEPARATED BY A TANGENT OF LESS THAN 600 FEET. ¥
- ₩1--4() "REVERSE CURVE ARROW" THIS SIGN IS INTENDED FOR USE WHERE TWO CURVES IN OPPOSITE DIRECTIONS ARE SEPARATED BY A TANGENT OF LESS THAN 600 FEET. ★
- W1~6() "ARROW" THIS SIGN SHOULD BE MOUNTED JUST BELOW THE ROAD CLOSED SIGN AT THE POINT WHERE THE DIVERSION HAS BEEN ESTABLISHED DUE TO THE LANE CLOSURE.
- W3-2 "YIELD AHEAD" THIS SIGN IS INTENDED FOR USE AT THE APPROACH TO THE YIELD SIGN THAT IS NOT VISIBLE FOR A SUFFICIENT DISTANCE TO PERMIT THE DRIVER TO BRING HIS VEHICLE TO A STOP AT THE YIELD SIGN.★
- ₩4-2 "LEFT (RIGHT) LANE TRANSITION SYMBOL" THIS SIGN IS INTENDED FOR USE IN ADVANCE OF THE REDUCTION IN THE NUMBER OF TRAFFIC LANES IN THE DIRECTION OF TRAVEL ON THE MULTILANE HIGHWAY.
- W5-1 "ROAD NARROWS" THIS SIGN IS INTENDED FOR USE IN ADVANCE OF THE TRANSITION ON THE ROAD WHERE THE PAVEMENT WIDTH IS REDUCED ABRUPTLY TO A WIDTH SUCH THAT TWO CARS CANNOT PASS WITHOUT REDUCING SPEED. ★
- W5-20 "NARROW BRIDGE SYMBOL" THIS SIGN IS INTENDED FOR USE IN ADVANCE OF A BRIDGE OR CULVERT HAVING A CLEAR TWO-WAY ROADWAY WIDTH OF 16 TO 18 FEET OR ANY BRIDGE OR CULVERT HAVING A ROADWAY CLEARANCE LESS THAN THE WIDTH OF THE APPROACH PAVEMENT.
- W5-3 "ONE LANE/BRIDGE" THIS SIGN SHOULD BE PLACED ON TWO-WAY ROADWAYS IN ADVANCE OF THE BRIDGES OR CULVERTS WHERE THE ROADWAY WIDTH IS LESS THAN 16 FEET (18 FEET FOR COMMERCIAL VEHICLES) OR WHEN THE ALIGNMENT IS POOR ON THE APPROACH TO THE STRUCTURE HAVING A CLEAR ROADWAY WIDTH OF 18 FEET OR LESS.
- W6-1 "DIMDED HIGHWAY SYMBOL" THIS SIGN SHOULD BE PLACED ON THE APPROACHES TO THE SECTION OF HIGHWAY WHERE OPPOSING FLOWS OF TRAFFIC ARE SEPARATED BY A PHYSICAL MEDIAN.
- W6-2 "DIMDED HIGHWAY ENDS SYMBOL" THIS SIGN SHOULD BE PLACED AT THE END OF THE SECTION OF PHYSICALLY DIMDED HIGHWAY AS A WARNING OF TWO-WAY TRAFFIC AHEAD.

TYPICAL CONSTRUCTION ZONE SIGNS

- W6-3 "TWO-WAY TRAFFIC SYMBOL" THIS SIGN IS INTENDED FOR USE TO GIVE WARNING OF TRANSITION FROM A SEPARATED ONE-WAY ROADWAY TO A TWO-WAY ROADWAY, X W2:
- W7-1 "HILL SYMBOL" THIS SIGN SHOULD BE PLACED AT A POINT IN ADVANCE OF THE DOWNGRADE WHERE THE LENGTH, PERCENT OF GRADE, HORIZONTAL CURVATURE, OR OTHER PHYSICAL FEATURES REQUIRE SPECIAL CONSIDERATION ON THE PART OF DRIVERS.
- W8~1,W8~2 "BUMP"/"DIP" THESE SIGNS ARE INTENDED FOR USE TO GIVE WARNING OF A SHARP RISE OR DEPRESSION IN THE PROFILE OF THE ROAD THAT IS SUFFICIENTLY ABRUPT TO AFFECT VEHICLE OPERATION OR CAUSE CONSIDERABLE DISCOMFORT TO PASSENGERS. ★
- W8-Jg "PAVEMENT ENDS SYMBOL" THIS SIGN IS INTENDED FOR USE IN ADVANCE OF A POINT WHERE THE PAVEMENT SURFACE CHANGES FROM A HARD-SURFACED PAVEMENT TO THE LOW-TYPE SURFACE OR EARTH ROAD. ★
- W8--4 "SOFT SHOULDER" THIS SIGN IS INTENDED FOR USE TO WARN OF A SOFT SHOULDER CONDITION THAT COULD PRESENT A PROBLEM TO VEHICLES THAT MAY GET OFF THE PAVEMENT.
- W8-5 "SLIPPERY WHEN WET SYMBOL" THIS SIGN SHOULD BE PLACED IN ADVANCE OF THE CONDITION WHERE THE HIGHWAY SURFACE IS SLIPPERY BEYOND WHAT IS ORDINARY WHEN WET.
- ₩8-90 "SHOULDER DROP-OFF" THIS SIGN IS INTENDED FOR USE IN ADVANCE OF A SHOULDER DROP-OFF THAT EXCEEDS THREE INCHES IN HEIGHT.
- W8-11 "UNEVEN LANES" THIS SIGN IS INTENDED FOR USE IN ADVANCE OF AN UNEVEN ADJACENT LANE SITUATION THAT EXCEEDS ONE INCH IN HEIGHT. ★
- W9~1() "LEFT (RIGHT) LANE ENDS" THIS SIGN IS INTENDED FOR USE IN ADVANCE OF THE PAVEMENT WIDTH TRANSITION SIGN (W4-2).
- W9-2() "LANE ENDS/MERGE LEFT (RIGHT)" THIS SIGN IS INTENDED FOR USE AS A SUPPLEMENT TO THE PAVEMENT WIDTH TRANSITION SIGN (W4-2).
- W9-3 OR W9-30() "CENTER LANE CLOSED AHEAD" - THIS SIGN SHOULD BE USED IN ADVANCE OF THE POINT WHERE WORK OCCUPIES THE CENTER LANE AND TRAFFIC IS DIRECTED TO THE RIGHT OR LEFT OF THE WORK ZONE.
- W12-1 "DOUBLE ARROW SYMBOL" THIS SIGN SHOULD BE PLACED AT THE POINT OF THE OBSTRUCTION IN THE ROADWAY, WHERE TRAFFIC IS PERMITTED TO PASS ON EITHER SIDE OF THE OBSTRUCTION.
- W12-2 "LOW CLEARANCE SYMBOL" THIS SIGN IS INTENDED FOR USE IN ADVANCE OF AN OBSTRUCTION TO WARN VEHICLE OPERATORS OF CLEARANCES LESS THAN THE MAXIMUM VEHICLE HEIGHT PERMITTED PLUS 12 INCHES.
- W13-1() "ADVISORY SPEED PLAQUE" THIS SIGN IS INTENDED TO SUPPLEMENT WARNING SIGNS ONLY AND SHALL NOT BE MOUNTED ALONE. IT IS USED TO INDICATE THE MAXIMUM RECOMMENDED SPEED FOR THE INDICATED CONDITION.
- W20-1 "ROAD/WORK/AHEAD" THIS SIGN IS TO BE LOCATED IN ADVANCE OF THE INITIAL ACTIVITY OR DETOUR A DRIVER MAY ENCOUNTER, AND IS INTENDED TO BE USED AS A WARNING OF OBSTRUCTIONS OR RESTRICTIONS.
- W20-2 "DETOUR/(DIST.)" THIS SIGN IS INTENDED FOR USE IN ADVANCE OF THE POINT AT WHICH TRAFFIC IS DIVERTED OVER A TEMPORARY ROADWAY OR ROUTE.
- W20-3 "ROAD/CLOSED/(DIST.)" THIS SIGN IS INTENDED FOR USE IN ADVANCE OF A POINT AT WHICH A ROADWAY IS CLOSED TO ALL TRAFFIC OR TO ALL BUT LOCAL TRAFFIC.
- W20-4 "ONE LANE/ROAD/(DIST.)" THIS SIGN IS INTENDED FOR USE IN ADVANCE OF A POINT WHERE TRAFFIC IN BOTH DIRECTIONS MUST USE A SINGLE LANE.
- W20-5() "XXX LANE/CLOSED/(DIST.)" THIS SIGN IS INTENDED FOR USE IN ADVANCE OF A POINT WHERE ONE LANE OF A MULTIPLE-LANE ROADWAY IS CLOSED. IT SHOULD BE PROVIDED WITH INTERCHANGEABLE PLAQUES READING "RIGHT", "LEFT", AND "CENTER" AT NO ADDITIONAL COST TO THE PROJECT.
- W20-7g "FLAGGER SYMBOL" THIS SIGN IS INTENDED FOR USE IN ADVANCE OF ANY POINT AT WHICH A FLAGGER HAS BEEN STATIONED TO CONTROL TRAFFIC THROUGH OR AROUND THE PROJECT.
- W20-52 "GROOVED/PAVEMENT/AHEAO" THIS SIGN IS INTENDED TO BE USED IN ADVANCE OF A ROADWAY THAT HAS BEEN GROOVED AND/OR ROTO MILLED.
- W21-10 "WORKER SYMBOL" THIS SIGN IS INTENDED FOR USE IN CONJUNCTION WITH MINOR MAINTENANCE AND PUBLIC UTILITY OPERATIONS FOR THE PROTECTION OF NEW WORKING IN OR NEAR THE ROADWAY.
- W21-2 "FRESH/OIL" THIS SIGN IS INTENDED FOR USE WHERE RE-SURFACING OPERATIONS HAVE RENDERED THE SURFACE OF THE PAVEMENT TEMPORARILY WET, AND OBJECTIONABLE SPLASHING ON VEHICLES MAY OCCUR.
- W21-3 "ROAD/MACHINERY/AHEAD" THIS SIGN IS INTENDED FOR USE IN ADVANCE OF THE AREAS WHERE HEAVY EQUIPMENT IS OPERATING IN OR ADJACENT TO THE ROADWAY.

Computer File Information			Colorado Department of Transportation	TRAFFIC CONTROLS	STANDARD PLAN NO.
Creation Date: 07-04-06 Initials: KCM Last Modification Date: 07-04-06 Initials: JSW		Date: Comments	4201 East Arkansas Avenue Denver, Colorado 80222	FOR HIGHWAY	
Full Path:www.dot.state.co.us/DesignSupport/))		Phone: (303) 757-9543 Fax: (303) 757-9820	CONSTRUCTION	S-630-1
Drawing File Name: S-630-1 (12 of 12) CAD Ver.: MicroStation V8 Scale: Not to Scale Units: English	\equiv		Staff Traffic Branch KCM/JSW	Issued By: Traffic Engineering Unit July 4, 2006	Sheet No. 12 of 12
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W22-1	"Blastii any po w22-2
₩22-+2	"TURN (USED IN 1000 FI
₩22-3	"END/BI THE RAI FROM T CONSTR

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20	225	•	•						
25	325	•	•	•					
30	450	•	•	۲	~~				
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60	1100	400	350	300	250	175	٠		
65	1200	475	425	400	350	275	175	۲	
70	1250	550	525	500	425	350	250	150	
75	1350	650	625	600	525	450	350	250	100

+	"MERGE" A	Ń
-+	CONDITION LOCATIONS	
	CONDITION.	
	REVERSE	r

A SUPPLEMENTAL PLAQUE MAY BE USED WITH WARNING SIGNS SPECIFYING THE DISTANCE TO THE CONDITION IF THERE IS AN IN-BETWEEN INTERSECTION THAT MIGHT CONFUSE THE MOTORIST.

W21-4 "ROAD/WORK/(DIST.)" - THIS SIGN IS INTENDED FOR USE IN ADVANCE OF MAINTENANCE FOR MINOR RECONSTRUCTION OPERATIONS IN THE ROADWAY.

LDER/WORK" - THIS SIGN IS INTENDED FOR USE IN ADVANCE OF THE CT INVOLVING THE SHOULDER, WHERE THE TRAVELED WAY REMAINS TRUCTED.

ey/crew" – This sign is intended for use in advance of a point a surveying crew is working in or adjacent to the roadway. \bigstar

ING/ZONE/(DIST.)" - THIS SIGN IS INTENDED FOR USE IN ADVANCE OF OINT OR WORK SITE WHERE THERE ARE EXPLOSIVES BEING USED. THE 2 AND W22-3 SIGNS MUST BE USED IN SEQUENCE WITH THIS SIGN.

off/2-way radios/and/cellular/phones" — This sign is to be in sequence with the w22-1 and w22-3 signs and placed at least teet from the beginning of the blasting zone.

BLASTING/ZONE" - THIS SIGN IS TO BE USED TO DENOTE THE END OF ADIO INFLUENCE AREA AND SHALL BE PLACED A MINIMUM OF 1000 FEET THE BLASTING ZONE, EITHER WITH OR PRECEDING THE END RUCTION SIGN.

ADVANCE PLACEMENT OF WARNING SIGNS

CONDITION A: SPEED REDUCTION AND LANE CHANGING IN HEAVY TRAFFIC. TYPICAL SIGNS ARE "MERGE" AND "RIGHT LANE ENDS".

CONDITION B: TYPICAL CONDITIONS ARE THE WARNING OF A POTENTIAL STOP SITUATION AND LOCATIONS WHERE THE ROAD USER MUST DECREASE SPEED TO MANEUVER THROUGH THE WARNED CONDITION. TYPICAL SIGNS ARE "STOP AHEAD", "SIGNAL AHEAD", "YIELD AHEAD", "CURVE", "REVERSE CURVE", "TURN".

NO SUGGESTED DISTANCES ARE PROVIDED AT THESE SPEEDS, AS THE PLACEMENT IS DEPENDENT ON SITE CONDITIONS AND OTHER SIGNING.

No KLASSON 9/30/09

st placement should be in accordance with warning sign placement table.