


NOTES:

- 1. A FENCE (PLASTIC) CONFORMING TO SECTION 607 SHALL BE INSTALLED AROUND THE CONCRETE WASHOUT AREA, EXCEPT AT THE OPENING.
- 2. THE CONCRETE WASHOUT SIGN SHALL HAVE LETTERS AT LEAST 3 INCHES HIGH AND CONFORM TO SUBSECTION 630.02.
- 3. ALL MATERIALS AND LABOR TO COMPLETE THE CONCRETE WASHOUT STRUCTURE SHALL BE INCLUDED IN THE COST OF WORK AND NOT PAID FOR SEPARATELY.
- 4. THE BOTTOM OF EXCAVATION SHALL BE A MINIMUM OF FIVE FEET ABOVE GROUND WATER. IF NOT, THE BOTTOM OF EXCAVATION SHALL BE IN ACCORDANCE WITH 208.02 (j).
- 5. THE PAY ITEM NUMBER FOR CONCRETE WASHOUT STRUCTURE (EACH) IS 208-00045.

CONCRETE WASHOUT STRUCTURE

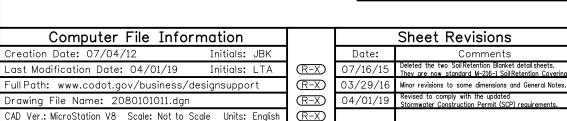

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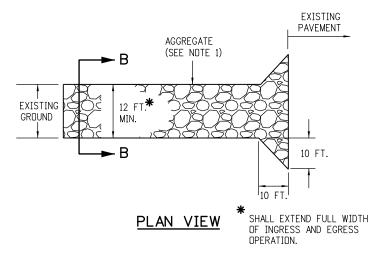
JBK/LTA Division of Project Support


TEMPORARY EROSION CONTROL

M-208-1


Sheet No. 1 of 11

STANDARD PLAN NO.



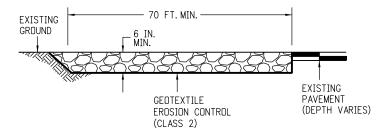

ELEVATION SECTION

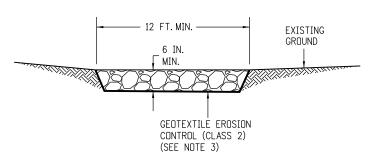



SECTION B-B

- 1. AGGREGATE SHALL CONFORM TO SUBSECTION 208.02 (I).
- 2. THE CONTRACTOR SHALL PROTECT CURB AND GUTTER THAT CROSSES THE ENTRANCE FROM DAMAGE, WHILE NOT BLOCKING FLOW OF WATER THRU STRUCTURE PROTECTION OF THE CURB AND GUTTER SHALL BE INCLUDED IN THE COST OF WORK AND NOT PAID FOR SEPARATELY.
- 3. GEOTEXTILE SHALL CONFORM TO SUBSECTION 712.08.
- 4. ALL MATERIALS AND LABOR TO COMPLETE THE VEHICLE TRACKING PAD SHALL BE INCLUDED IN THE COST OF WORK AND NOT PAID FOR SEPARATELY.
- 5. THE PAY ITEM NUMBER FOR VEHICLE TRACKING PAD (EACH) IS 208-00070.


VEHICLE TRACKING PAD

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ISOMETRIC VIEW

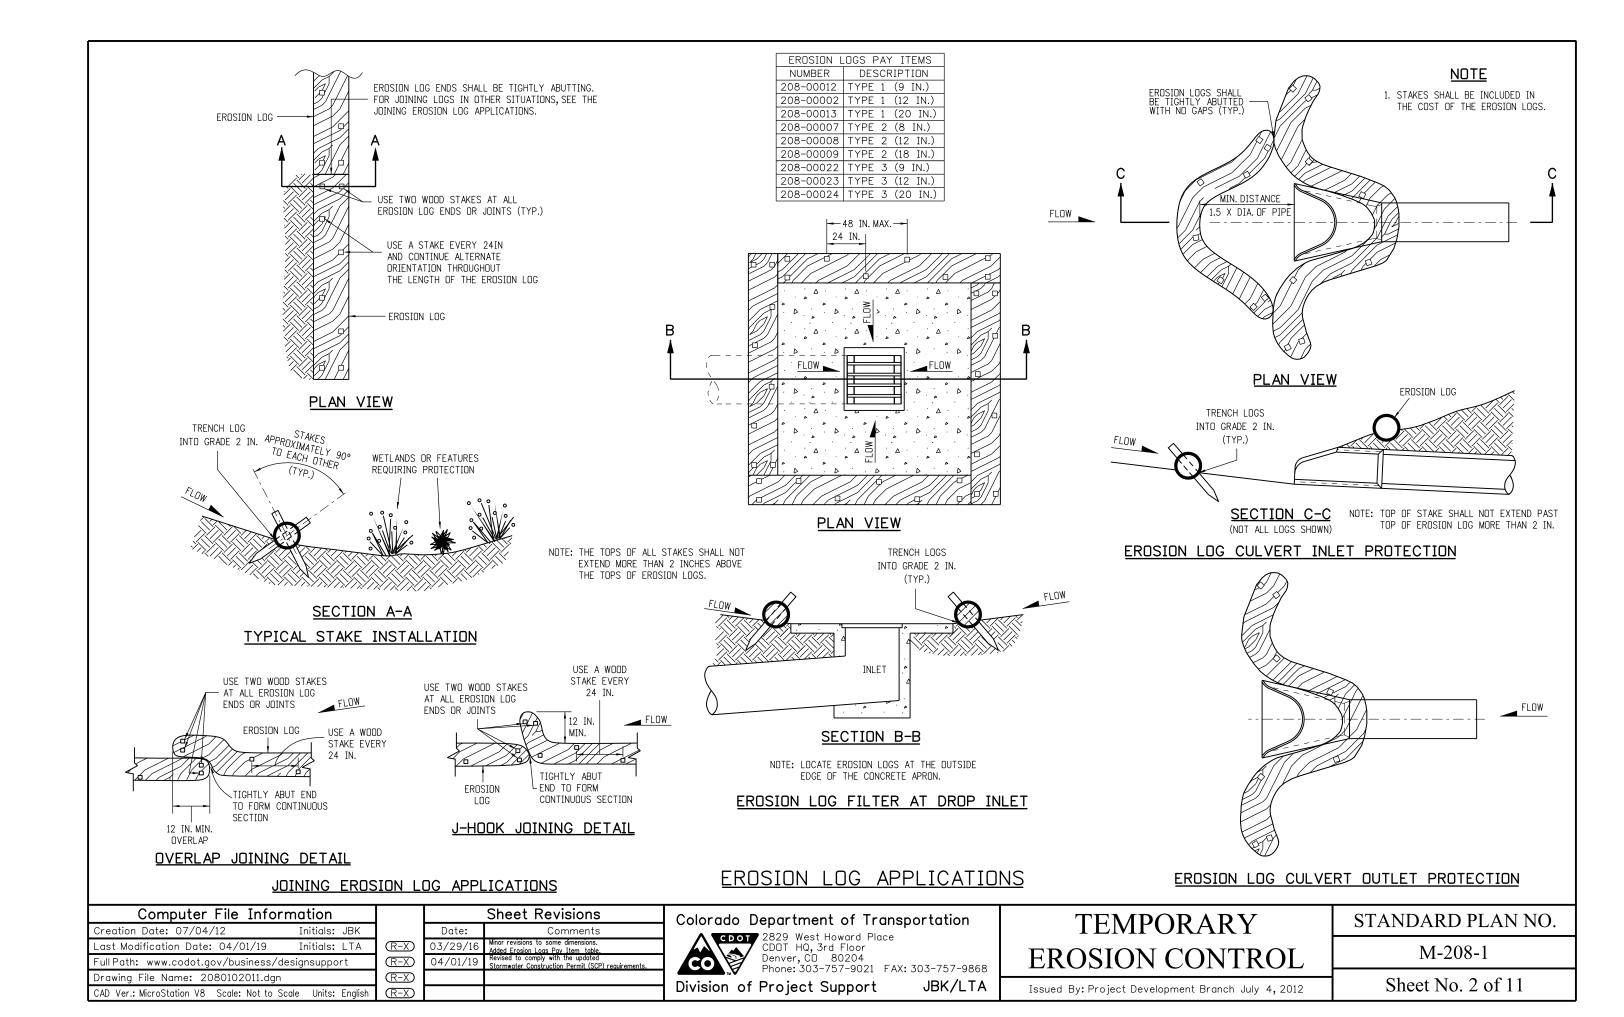

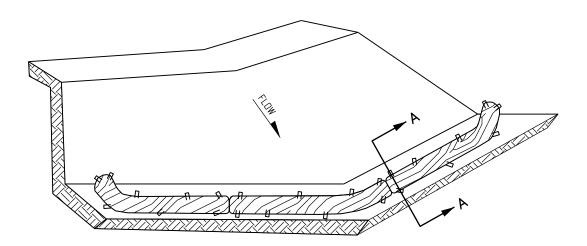NOTE: THE TOPS OF ALL STAKES SHALL NOT EXTEND MORE THAN 2 INCHES ABOVE THE TOPS OF EROSION LOGS.

SECTION A-A

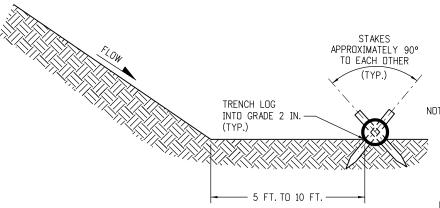
- 1. EROSION LOGS USED AT TOE OF SLOPE SHALL BE PLACED 5 TO 10 FEET BEYOND TOE OF SLOPE TO PROVIDE STORAGE CAPACITY.
- 2. EROSION LOGS SHALL BE PLACED ON THE CONTOUR WITH ENDS FLARED UP SLOPE.
- 3. SEE SHEET 2 OF 11 FOR JOINING LOGS DETAIL.

EROSION LOGS PAY ITEMS NUMBER DESCRIPTION 208-00012 208-00002 TYPE 1 (12 IN.) 208-00013 TYPE 1 (20 IN.) 208-00007 TYPE 2 (8 IN.) 208-00008 TYPE 2 (12 IN.) 208-00009 TYPE 2 (18 IN.) 208-00022 TYPE 3 (9 IN.) 208-00023 TYPE 3 (12 IN.) 208-00024 TYPE 3 (20 IN.)


1. SILT FENCE SHALL HAVE A MAXIMUM DRAINAGE AREA OF ONE-QUARTER ACRE PER 100 FEET OF SILT FENCE LENGTH; MAXIMUM SLOPE LENGTH BEHIND BARRIER

NOTES

- 2. SILT FENCE USED AT TOE OF SLOPE SHALL BE PLACED 5 TO 10 FEET BEYOND TOE OF SLOPE TO PROVIDE STORAGE CAPACITY.
- 3. SILT FENCE SHALL BE PLACED PARALLEL TO THE CONTOUR WITH ENDS FLARED UP SLOPE.
- 4. THE MAXIMUM LENGTH OF EROSION LOGS OR SILT FENCES WITHOUT A FLARED END TURNING UPSLOPE IS 150 FEET.

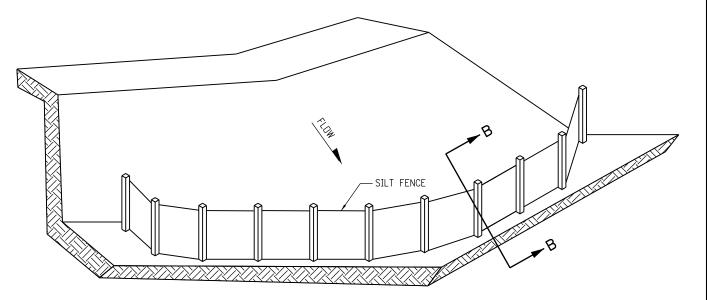

ISOMETRIC VIEW

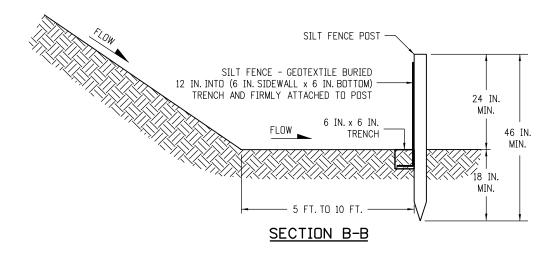

SILT FENCE TOE OF SLOPE PROTECTION

NOTE: THE PAY ITEM NUMBER FOR SILT FENCE (LF) IS 208-00020.


EROSION LOG TOE OF SLOPE PROTECTION

TOE OF SLOPE PROTECTION APPLICATIONS

Computer File Information			
Creation Date: 07/04/12	Initials: JBK		
Last Modification Date: 04/01/19	Initials: LTA		
Full Path: www.codot.gov/business/designsupport			
Drawing File Name: 2080103011.dgn			
CAD Ver.: MicroStation V8 Scale: Not to Sca	Units: English		

	Sheet Revisions			
	Date:	Comments		
$\overline{\mathbb{R}-X}$	03/29/16			
$\overline{R-X}$	04/01/19	Revised to comply with the updated Stormwater Construction Permit (SCP) requirements.		
$\overline{R-X}$				
(R-X)				

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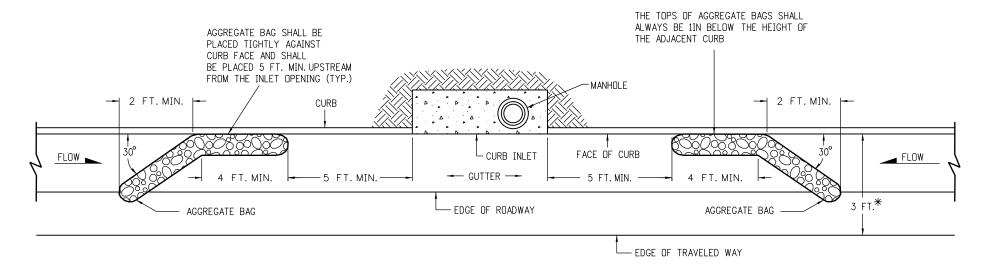
Division of Project Support

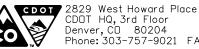TEMPORARY EROSION CONTROL STANDARD PLAN NO.

M-208-1

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Sheet No. 3 of 11




PLAN VIEW


* NOTE: USE AGGREGATE BAGS ONLY WHEN THERE IS A MINIMUM CLEARANCE OF 3 FEET FROM THE EDGE OF THE TRAVELED WAY (INCLUDING CONDITIONS DURING DETOURS) TO THE FACE OF CURB.

LENGTH (L) OF INLET FT.	NUMBER OF AGGREGATE BAGS UPSTREAM OF INLET
0 - 5	1
6 - 10	2
L > 10	3

AGGREGATE BAGS AT STORM DRAIN INLET (TYPE I)

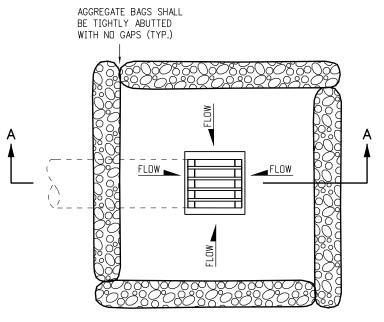



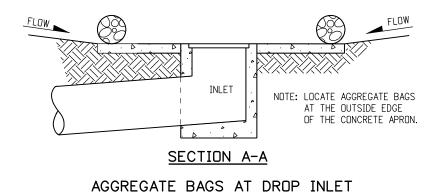


AGGREGATE BAG APPLICATIONS

NOTE: THE PAY ITEM NUMBER FOR AGGREGATE BAG (LF) IS 208-00035

Computer File Information			
Creation Date: 07/04/12	Initials: JBK		
Last Modification Date: 04/01/19	Initials: LTA		
Full Path: www.codot.gov/business/des	signsupport		
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	Sheet Revisions				
	Date:	Comments			
$\overline{R-X}$	03/29/16	Added some dimensions and Note.			
R-X	04/01/19	Revised to comply with the updated Stormwater Construction Permit (SCP) requirements.			
R-X					
R-X					

Colorado Department of Transportation

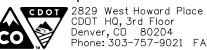


CDDT HQ, 3rd Floor Denver, CD 80204 Phone: 303-757-9021 FAX: 303-757-9868 JBK/LTA Division of Project Support


TEMPORARY			
EROSION CONTROL			

STANDARD PLAN NO. M-208-1

Issued By: Project Development Branch July 4, 2012

Sheet No. 4 of 11

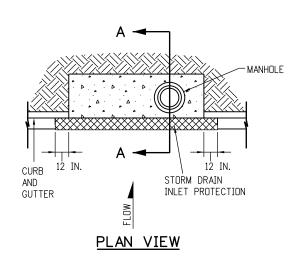

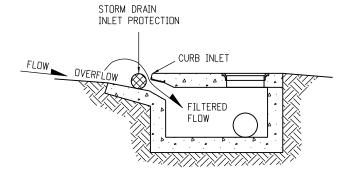


SECTION A-A


STORM DRAIN INLET PROTECTION (TYPE I)

NOTES:


- 1. INLET PROTECTION DEVICE SHALL EXTEND 12 INCHES PAST EACH END
- 2. THE PAY ITEM NUMBERS FOR STORM DRAIN INLET PROTECTION (TYPE I) ARE 208-00051 (LF), 208-00053 84 INCHES (EACH), 208-00057 144 INCHES (EACH), AND 208-00058 204 INCHES (EACH).
- 3. FOR STORM DRAIN INLET TYPES I AND II, IF THERE IS A MINIMUM CLEARANCE OF 3 FEET FROM THE EDGE OF THE TRAVELED WAY TO THE FACE OF CURB, USE THE AGGREGATE BAGS AT STORM DRAIN INLET (TYPE I) DETAIL ON SHEET 4 INSTEAD.

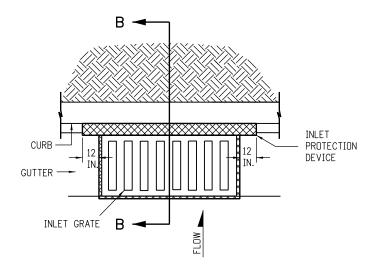

PLAN VIEW

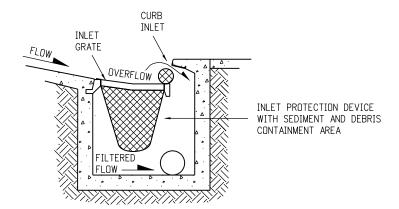

SECTION B-B OPTION A STORM DRAIN INLET PROTECTION (TYPE II)

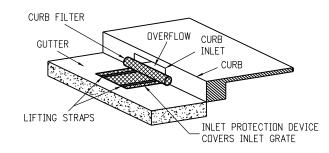


ISOMETRIC VIEW OPTION B STORM DRAIN INLET PROTECTION (TYPE II)

NOTE: THE PAY ITEM NUMBERS FOR STORM DRAIN INLET PROTECTION (TYPE II) ARE 208-00054 (EACH).

VANE INLET GRATE 36 IN. X 31 IN. OR 72 IN. X 31 IN. PROJECTED ROADWAY FLOWLINE CROSS SLOPE 2 FT. APRON OVERFLOW TRANSITION OPENING INLET PROTECTION DEVICE 36 IN. WITH SEDIMENT AND DEBRIS OR 72 IN. CONTAINMENT AREA

OPTION A STORM DRAIN INLET PROTECTION (TYPE III)

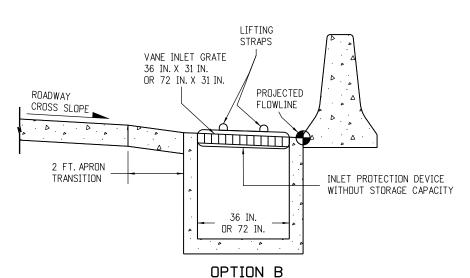

STORM DRAIN INLET PROTECTION (TYPE III)


NOTE: THE PAY ITEM NUMBER FOR STORM DRAIN INLET PROTECTION (TYPE III) (EACH) IS 208-00056.

STORM DRAIN INLET PROTECTION TYPES

Computer File Information		
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Last Modification Date: 04/01/19	Initials: LTA	
Full Path: www.codot.gov/business/designsupport		
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CAD Ver.: MicroStation V8 Scale: Not to Sca	e Units: English	

	Sheet Revisions			
	Date:	Comments		
\mathbb{R} -X	03/29/16	Added Note 3.		
\mathbb{R} -X	06/10/17	Added new Pay Item numbers for Type I and II.		
\mathbb{R} -X	04/01/19	Revised to comply with the updated Stormwater Construction Permit (SCP) requirements.		
(R-X)				
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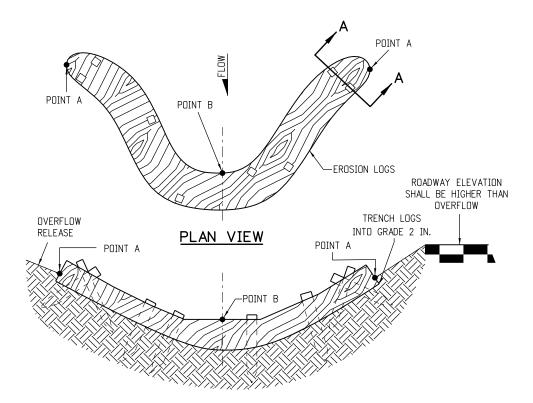
Division of Project Support

TEMPORARY EROSION CONTROL STANDARD PLAN NO.

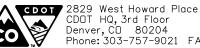M-208-1


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Sheet No. 5 of 11



NOTE: POINTS "A" SHALL BE A MINIMUM 4 IN. HIGHER THAN POINT "B".

ELEVATION

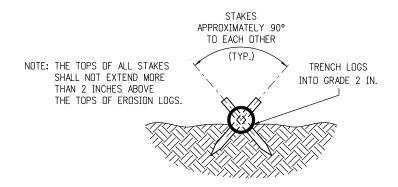



SECTION A-A

NOTES:

- 1. EROSION LOGS SHALL BE EMBEDDED 2 INCHES INTO THE SOIL.
- 2. EROSION LOGS SHALL BE TIGHTLY ABUTTED WITH NO GAPS.
- 3. V-SHAPED TEMPORARY DITCHES SHALL NOT BE USED. DITCHES SHAL BE GRADED IN A PARABOLIC OR TRAPEZOIDAL SHAPE.


EROSION LOG INSTALLATION

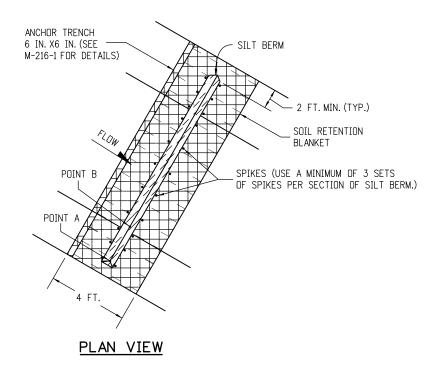

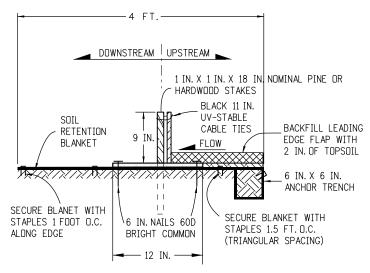

- 1. MINIMUM 4 NAILS PER SEGMENT (UPSTREAM).
- 2. MINIMUM 2 NAILS PER SEGMENT (DOWNSTREAM).
- 3. MINIMUM 2 WOOD STAKES PER SEGMENT.

SILT BERM (2) SECTION VIEW

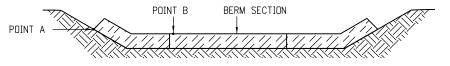

POINT "A" SHALL BE HIGHER THAN POINT "B" TO ENSURE THAT WATER FLOWS OVER THE BERM AND NOT AROUND THE ENDS.

FRONT VIEW

NOTES

- 1. ANCHOR SOIL RETENTION BLANKET INTO TRENCH WITH 8 INCHES MIN. STAPLES PLACED AT 1 FOOT INTERVALS ALONG EDGE.
- 2. FILL AND COMPACT TRENCH.
- 3. SECTIONS OF THE SILT BERM SHALL BE OVERLAPPED WITH NO GAPS.
- 4. FOR SLOPE AND CHANNEL SPACING SEE THE "SECTION VIEW ALONG DITCH FLOWLINE" DETAIL ON SHEET 11 OF 11.
- 5. SOIL RETENTION BLANKET SHALL ALWAYS BE REQUIRED.
- 6. THE PAY ITEM NUMBER FOR SILT BERM (LF) IS 208-00004.

SILT BERM INSTALLATION

DRAINAGE DITCH APPLICATIONS

SILT BERM (1) SECTION VIEW

Computer File Information		
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Last Modification Date: 04/01/19 Initials: LTA	\mathbb{R} -X	04/0
Full Path: www.codot.gov/business/designsupport	\mathbb{R} -X	
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		Sheet Revisions
	Date:	Comments
\mathbb{R} -X	04/01/19	Revised to comply with the updated Stormwater Construction Permit (SCP) requirements.
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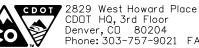
Colorado Department of Transportation

SECURE SILT BERM WITH

SPIKES 10 - 12 IN. DEEP (TYP.)

SOIL RETENTION

BLANKET



SECURE BLANKET

WITH STAPLES

(SEE M-216-1

FOR DETAILS)

ANCHOR TRENCH 6 IN. X 6 IN.

(SEE M-216-1 FOR DETAILS)

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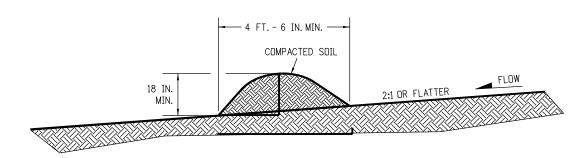
TEMPORARY			
EROSION CONTROL			

STANDARD PLAN NO.

M-208-1


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Sheet No. 6 of 11



NUTE 2.

- 1. BERMS SHALL HAVE A HEIGHT OF 18 INCHES, SIDE SLOPES OF 2:1 OR FLATTER AND A MINIMUM BASE WIDTH OF 4 FT.-6 IN.
- 2. BERMS SHALL BE USED TO INTERCEPT AND DIVERT DRAINAGE TO A DESIGNATED OUTLET.
- 3. BERMS SHALL NOT BE USED WHERE DRAINAGE AREA EXCEEDS 10 ACRES.
- 4. BERMS SHALL BE CONSTRUCTED OUT OF ACCEPTABLE MATERIAL THAT CAN BE COMPACTED AND RECEIVE AT A MINIMUM HEAVY EQUIPMENT WHEEL ROLLED COMPACTION.
- 5. TEMPORARY BERMS SHALL BE CONSTRUCTED OUT OF EMBANKMENT (SUBSOIL) AND IN NO CIRCUMSTANCE CONSTRUCTED OUT OF SALVAGED TOPSOIL.
- 6. THE PAY ITEM NUMBER FOR TEMPORARY BERM (LF) IS 208-00300.

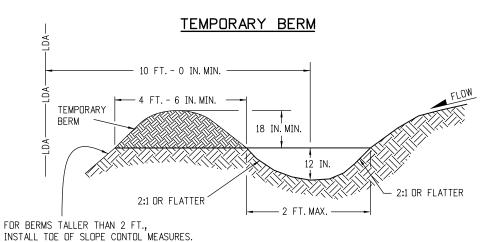


NOTES:

SEE SHEET 3 OF 11 FOR DETAILS.

- 1. TEMPORARY DIVERSION DITCHES SHALL BE CONSTRUCTED ACROSS THE SLOPE TO INTERCEPT RUNOFF AND DIRECT IT TO A STABLE DUTLET OR SEDIMENT TRAP.
- 2. USE THE TEMPORARY DIVERSION DITCH IMMEDIATELY ABOVE A NEW CUT, FILL SLOPE, OR AROUND THE PERIMETER OF A DISTURBED AREA.
- 3. THE GRADIENT ALONG THE FLOW PATH SHALL HAVE A POSITIVE GRADE TO ASSURE DRAINAGE, BUT SHALL NOT BE SO STEEP AS TO RESULT IN EROSION DUE TO HIGH VELOCITY.
- 4. THE DIVERSION FLOWLINE SHALL ALWAYS BE LOCATED A MINIMUM 10 FEET FROM THE OUTSIDE LIMITS OF DISTURBED AREA BOUNDARY.
- 6. DIVERSION BERMS SHALL BE CONSTRUCTED OUT OF EMBANKMENT (SUBSOIL) AND IN NO CIRCUMSTANCE CONSTRUCTED OUT OF SALVAGED TOPSOIL.
- 5. THE PAY ITEM NUMBER FOR TEMPORARY DIVERSION (LF) IS 208-00301.

TEMPORARY DIVERSION

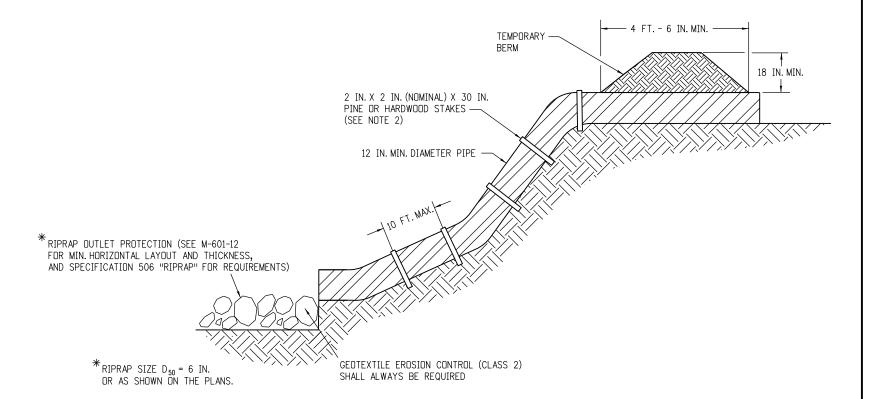

NOTES:

- 1. ANCHOR SIZE VARIES ACCORDING TO PIPE SIZE
- 2. TO SECURE THE PIPE, DRIVE STAKES INTO GROUND, THEN TIE A 12 GUAGE WIRE BETWEEN THEM ABOVE AND ACROSS THE PIPE'S WIDTH.
- 3. THE OUTLET SHALL BE ALIGNED WITH THE FLOW DIRECTION OF THE EXISTING GRADE. PERPENDICULAR DISCHARGE TO A CHANNEL SHALL NOT BE ACCEPTABLE.
- 4. THE GRADE AROUND THE INLET TO THE PIPE SHALL BE COMPACTED.
- 5. THE PAY ITEM NUMBER FOR TEMPORARY SLOPE DRAINS (LF) IS 208-00060.

TEMPORARY SLOPE DRAINS

GRADING APPLICATIONS

Division of Project Support

Colorado Department of Transportation
2829 West Howard Place
CDOT HQ, 3rd Floor

Denver, CD 80204 Phone: 303-757-9021 FAX: 303-757-9868

JBK/LTA

Computer File Information			Sheet Revisions
Creation Date: 07/04/12 Initials: JBK		Date:	Comments
_ast Modification Date: 04/01/19 Initials: LTA			Revisions to some dimensions and Notes.
Full Path: www.codot.gov/business/designsupport	$\overline{R-X}$	04/01/19	Revised to comply with the updated Stormwater Construction Permit (SCP) requirements.
Drawing File Name: 2080107011.dgn	R-X		
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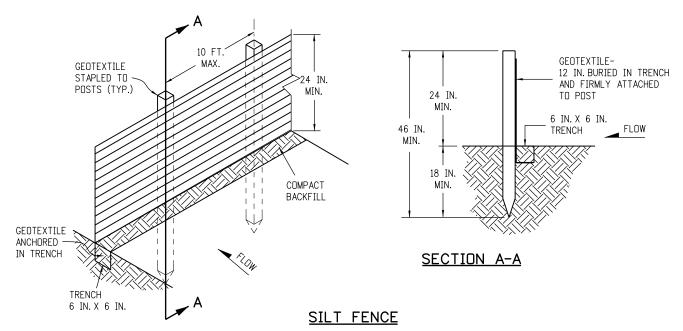
TEMPORARY EROSION CONTROL

STANDARD PLAN NO.

M-208-1


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Sheet No. 7 of 11



NOTES:


- 1. GEOTEXTILE SHALL BE ATTACHED TO WOOD POSTS WITH THREE OR MORE STAPLES PER POST. STAPLES SHALL BE HEAVY DUTY WIRE AND AT LEAST 1 INCH LONG.
- 2. WOOD POST SHALL BE 1 IN. X 1 IN. NOMINAL.
- 3. THE PAY ITEM NUMBER FOR SILT FENCE (LF) IS 208-00020.
- 4. THE SILT FENCE SHALL BE PLACED ON THE CONTOUR (AT THE SAME ELEVATION ±6 IN.). THE ENDS SHALL BE FLARED UP SLOPE (MINIMUM ELEVATION GAIN OF 18 IN.).

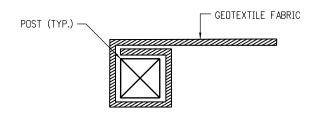

END SECTION DETAIL (PLAN VIEW)


NOTE:

1. THE END OF THE SILT FENCE FABRIC SHALL BE WRAPPED APPROX. 6 INCHES AROUND A WOODEN POST ONE FULL TURN. THEN SECURED ALONG THE POST WITH 6 HEAVY DUTY WIRE STAPLES AT LEAST 1 INCH LONG.

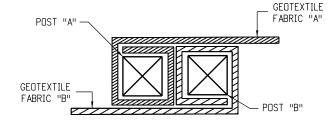


JOINING SECTION DETAIL (PLAN VIEW)

- 1. THE ENDS OF THE SILT FENCE FABRIC SHALL BE JOINED TOGETHER BY WRAPPING APPROX. 6 INCHES OF EACH END AROUND A WOODEN POST ONE FULL TURN, THEN SECURED ALONG THE POST WITH 6 HEAVY DUTY WIRE STAPLES AT LEAST 1 INCH LONG.
- 2. POSTS SHALL BE TIGHTLY ABUTTED WITH NO GAPS TO PREVENT POTENTIAL FLOW-THROUGH OF SEDIMENT AT JOINT.

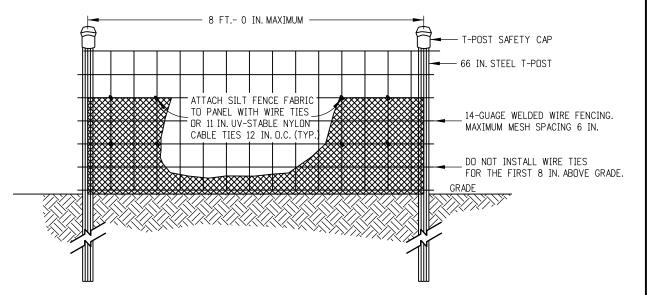

ELEVATION VIEW

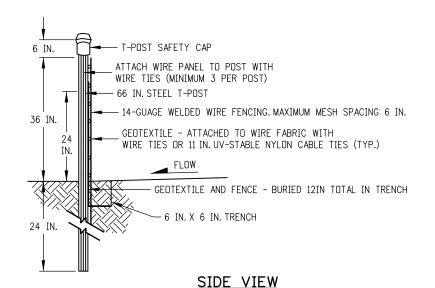

- 1. THE ENDS OF THE SILT FENCE FABRIC SHALL BE JOINED TOGETHER BY WRAPPING APPROX. 6 INCHES OF EACH END AROUND A STEEL T-POST, THEN SECURED ALONG THE POST WITH WIRE TIES (MINIMUM 3 PER POST).
- 2. POSTS SHALL BE TIGHTLY ABUTTED WITH NO GAPS TO PREVENT POTENTIAL FLOW-THROUGH OF SEDIMENT AT JOINT.
- 3. SILT FENCES SHALL NOT BE USED FOR CHECK DAMS.
- 4. THE PAY ITEM NUMBER FOR SILT FENCE (REINFORCED) (LF) IS 208-00021.

SILT FENCE (REINFORCED)

SILT FENCE APPLICATIONS

Computer File Information		
Creation Date: 07/04/12	Initials: JBK	
Last Modification Date: 04/01/19	Initials: LTA	(R-X)
Full Path: www.codot.gov/business/des	ignsupport	(R-X)
Drawing File Name: 2080108011.dgn		$\overline{R-X}$
CAD Ver.: MicroStation V8 Scale: Not to Scal	e Units: English	(R-X)

	Sheet Revisions			
	Date:	Comments		
(R-X)	03/29/16	Minor revisions to some dimensions and Notes.		
$\overline{R-X}$	04/01/19	Revised to comply with the updated Stormwater Construction Permit (SCP) requirements.		
R-X				
(R-X)				
(R-X)				

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Division of Project Support


TEMPORARY
EROSION CONTROL

STANDARD PLAN NO.

M-208-1


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Sheet No. 8 of 11

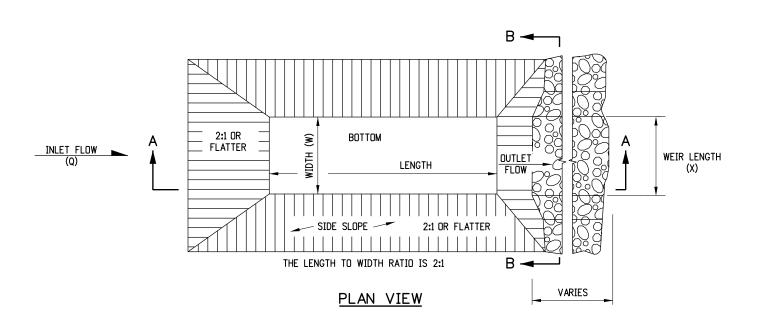


NOTES

- 1. THE MAXIMUM DRAINAGE AREA IS 5 ACRES.
- 2. THE MAXIMUM STRUCTURE LIFE IS 2 YEARS.
- 3. THE STORAGE AREA IS 1800 CUBIC FEET PER ACRE.
- 4. THE MAXIMUM EMBANKMENT HEIGHT SHALL BE 5 FT. MEASURED ON THE DOWNSTREAM SIDE.
- 5. THE LENGTH/WIDTH RATIO MAY BE ADJUSTED TO MEET SITE CONDITIONS WHEN APPROVED BY THE ENGINEER.
- 6. WIDTH (W) OF SEDIMENT TRAP IS APPROXIMATELY EQUAL TO THE WEIR LENGTH (X).
- 7. SEDIMENT TRAP DESIGN SHALL BE APPROVED BY THE ENGINEER.
- 8. THE DOWN GRADE FROM WEIR SHALL BE STABLE AND NON-ERODIABLE.
- 9. THE PAY ITEM NUMBER FOR SEDIMENT TRAP (LF) IS 208-00033.

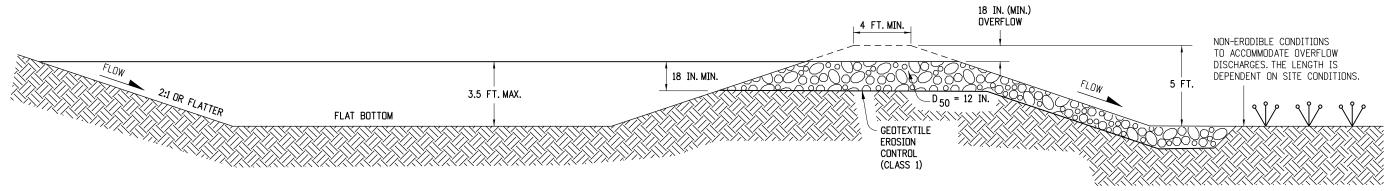

SECTION A-A

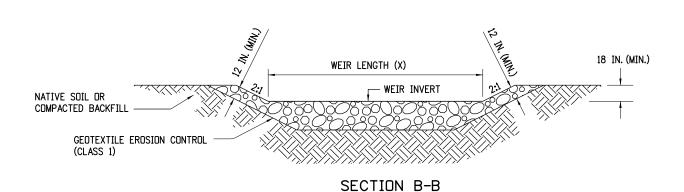

DRAINAGE AREA (ACRES)	WEIR LENGTH (FEET)
1	4
2	6
3	8
4	10
5	12

WEIR LENGTH TABLE

SEDIMENT TRAP

Computer File Information	
Creation Date: 07/04/12 Initials: JBK	
Last Modification Date: 04/01/19 Initials: LTA] (
Full Path: www.codot.gov/business/designsupport] (
Drawing File Name: 2080109010.dgn] (
CAD Ver.: MicroStation V8 Scale: Not to Scale Units: English	

	Sheet Revisions			
	Date:	Comments		
\mathbb{R} -X	03/29/16	Minor revisions to some dimensions.		
$\overline{R-X}$	04/01/19	Revised to comply with the updated Stormwater Construction Permit (SCP) requirements.		
$\overline{R-X}$				
(R-X)				

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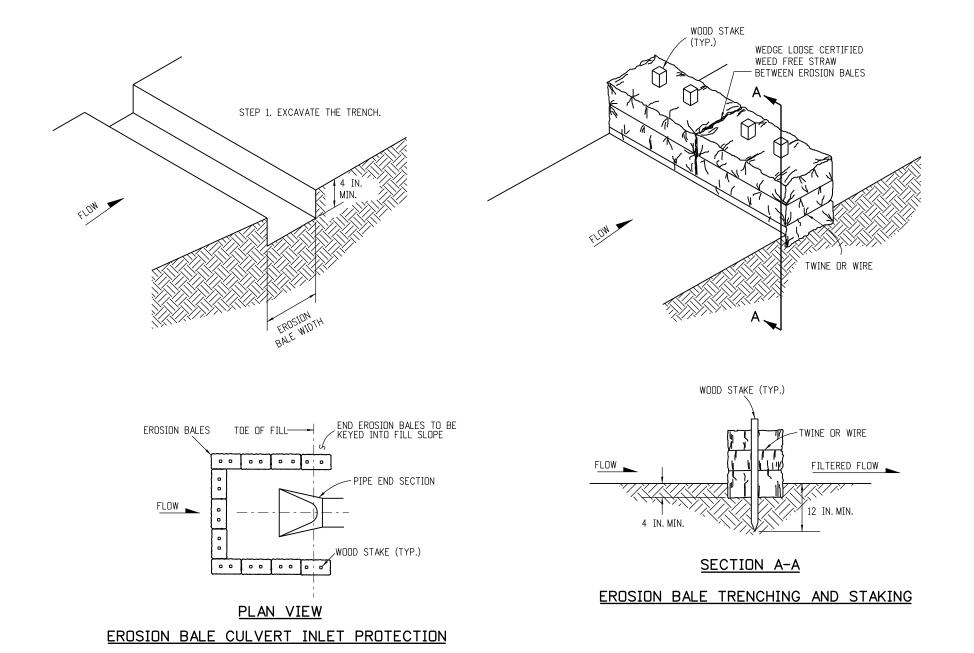


TEMPORARY
EROSION CONTROL

STANDARD PLAN NO.
M-208-1


Issued By: Project Development Branch July 4, 2012

Sheet No. 9 of 11




NOTES

- 1. STAKES SHALL BE WOOD AND SHALL BE 2 IN. X 2 IN. X 30 IN. NOMINAL.
- 2. EROSION BALES SHALL BE 18 IN. X 18 IN. X 36 IN.
- 3. EROSION BALES SHALL BE ENTRENCHED 4 IN. MINIMUM INTO THE SOIL, THIGHTLY ABUTTED WITH NO GAPS, STAKED, AND BACKFILLED AROUND THE ENTIRE OUTSIDE PERIMETER.
- 4. EROSION BALES CANNOT BE USED FOR CHECK DAMS.
- 5. EROSION BALE FILTER SHALL BE LOWER THAN BERM ELEVATION OR USED IN A SUMP CONDITION.
- 6. THE PAY ITEM NUMBER FOR EROSION BALES (WEED FREE) (EA) IS 208-00011.

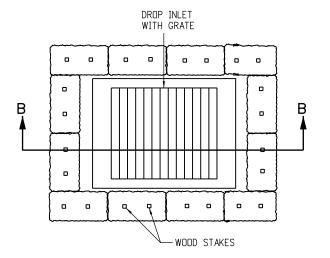

PLAN VIEW

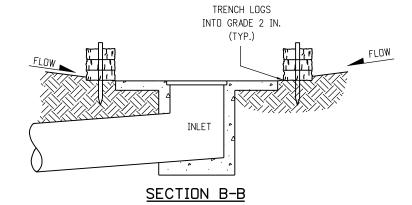

NOTE: LOCATE EROSION BALES AT THE OUTSIDE EDGE OF THE CONCRETE APRON.

EROSION LOG FILTER AT DROP INLET

EROSION BALE APPLICATIONS

Computer File Information				She
Creation Date: 07/04/12	Initials: JBK		Date:	
Last Modification Date: 04/01/19	Initials: LTA	$\overline{\mathbb{R}-X}$	03/29/16	Minor
Full Path: www.codot.gov/business/designsupport			04/01/19	Revised Stormw
Drawing File Name: 20801010011.dgn				
CAD Ver.: MicroStation V8 Scale: Not to S	Scale Units: English	(R-X)		

	Sheet Revisions				
	Date: Comments				
(R-X)	03/29/16	Minor revisions to some dimensions.			
$\overline{R-X}$	04/01/19	Revised to comply with the updated Stormwater Construction Permit (SCP) requirements.			
R-X					
(R-X)					

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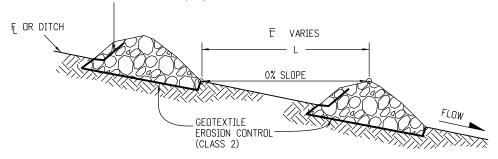
JBK/LTA Issued By: Project Development Branch July 4, 2012

TEMPORARY EROSION CONTROL STANDARD PLAN NO.


M-208-1

Sheet No. 10 of 11


GEOTEXTILE EROSION CONTROL (CLASS 2) TO EXTEND UP 3/3 OF RIPRAP HEIGHT WITH 6 IN. MIN. COVER OVER GEOTEXTILE (TYP).



SECTION VIEW ALONG DITCH FLOWLINE

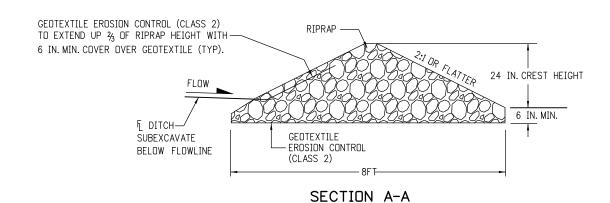

- 1. RIPRAP SIZE D_{50} = 6IN OR AS SHOWN ON THE PLANS.
- 2. THE GEOTEXTILE EROSION CONTROL SHALL BE CLASS 2 AND CONFORM TO THE REQUIREMENTS OF SUBSECTION 712.08.
- 3. THE ENDS OF RIPRAP CHECK DAM SHALL BE A MINIMUM OF 6 IN. HIGHER THAN CENTER OF CHECK DAM.
- 4. FOR USE AS TEMPORARY CHECK DAMS ONLY AND NOT FOR PERMANENT INSTALLATIONS.
- 5. THE PAY ITEM NUMBER FOR ROCK CHECK DAM (EA) IS 208-00041.

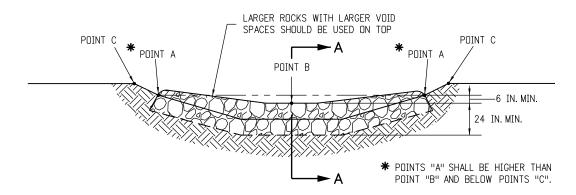

TYPICAL SECTION VIEW


NOTE: ALL MATERIALS AND LABOR TO COMPLETE THE ROCK CHECK DAM SHALL BE INCLUDED IN THE COST OF WORK.

ROCK CHECK DAM

Computer File Information		
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Last Modification Date: 04/01/19 Initials:	LTA	Œ
Full Path: www.codot.gov/business/designsuppo	rt	Œ
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CAD Ver.: MicroStation V8 Scale: Not to Scale Units:	English	\Box

	Sheet Revisions				
	Date: Comments				
$\overline{\mathbb{R}-X}$	03/29/16	Minor revisions to some Notes.			
$\overline{R-X}$	04/01/19	Revised to comply with the updated Stormwater Construction Permit (SCP) requirements.			
$\overline{R-X}$					
(R-X)					

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TEMPORARY	
EROSION CONTROL	

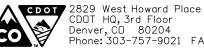STANDARD PLAN NO.

M-208-1

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