Region 2

905 Erie Avenue Pueblo, CD 81002

Phone: 719-546-5496 FAX: 719-546-5414

| | Sheet Revisions | | Sheet Revisions | | | | Sheet Revisions | | | |
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| Date | Description | Initials | Date | Description | Initials | Date | Description | Initials | | |
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3.01-3.02

4.01-4.02

5.01-5.01

6.01-6.05

7.01-7.01

| riight or may rians |
|---|
| Title Sheet |
| ect Number: IM 0252-423 |
| ect Location: I-25 & Cimarron (US 24) Interchange |

Right of Way Plans

XXXXX

QUARTER AND SIXTEENTH SECTION CORNER SECTION CORNERS (1)1 SET EASEMENT TEMPORARY RIGHT OF WAY MONUMENT EASEMENT POIN MARKER O NOAA O BLM QUARTER AND SIXTEENTH BLM MARKER PROPERTY PIN NOAA MARKER SECTION CORNERS O WC ⊙ USGS O FED WC WITNESS CORNER BENCH MARK USGS MARKER FEDERAL MONUMENT . ROW SECONDARY CONTROL LOCAL OR PLSS RIGHT OF WAY MONUMEN1 MONUMENT MARKER [©]N 10.13 E 3.81 EL 0.00 N 10.38 E 3.81 EL 0.00 PROJECT CONTROL DENSIFICATION HIGH ACCURACY REFERENCE CONTROL MONUMENT

TEMPORARY EASEMENT LINE (PROPOSED AND EXISTING)

PROPERTY BOUNDARY LINE (PROPOSED AND EXISTING)

ACCESS CONTROL LINE (PROPOSED AND EXISTING)

RIGHT OF WAY LINE (PROPOSED AND EXISTING) VIRGIN RIGHT OF WAY LINE (PROPOSED AND EXISTING

COUNTY LINE

SECTION LINE

STATE LINE

TOP OF CUT

TOE OF FILL

TOWNSHIP LINE

QUARTER SECTION LINE

SIXTEENTH SECTION LINE

—— III ——— III ——— III -BARRIER ACCESS CONTROL LINE (PROPOSED AND EXISTING)

RIGHT OF WAY PLANS OF PROPOSED FEDERAL AID PROJECT NO. IM 0252-423 INTERSTATE HIGHWAY NO. 25 & US 24 INTERCHANGE EL PASO COUNTY

DEPARTMENT OF TRANSPORTATION

STATE OF COLORADO

R.O.W. Length of Project = 0.66 Miles Const. Length of Project = 1.28 Miles

PROJECT LOCATION MAP

PERMANENT, PROPERTY, SLOPE, & UTILITY EASEMENT LINE (PROPOSED AND EXISTING) End Const Project Station: 148+00 M.P.: 141.60 Begin Const Project Station: 87+43 M.P.: 140.32 SHEET NO. INDEX OF SHEETS

Title Sheet

Tabulation of Properties Project Control Diagram

Land Survey Control Diagram

Monumentation Sheet Plan Sheets

Ownership Map

Total Sheets

Scales of Original 11"x17" Drawings Plan Sheets 1"=100' Ownership Map 1"=400"

- 1. This Right-of-Way Plan is not a boundary survey of the adjoining property and is prepared for the Colorado Department of Transportation purposes only.
- 2. For title information, The Colorado Department of Transportation relied on (Title Policy), (Title Commitments), (Memorandums of Ownership) prepared by Fidelity National Title Company.
- 3. This plan set is subject to change and may not be the most current set. It is the user's responsibility to verify with CDOT that this set is the most current. The information contained on the attached drawing is not valid unless this copy bears an original signature of the Professional Land Surveyor hereon named.
- 4. The project control diagram and land survey control diagram for this project are from existing project no. IM0252-334 done by Wilson & Co. Field checks were performed on control points in the field and variefied for their accuracy.

NOTICE: According to Colorado law you must commence any legal action based upon any defect in this survey within three years after you first discover such defect. In no event may any action based upon any defect in this survey be commenced more than ten years from the date of the certification shown hereon.

COLORADO DEPARTMENT OF TRANSPORTATION FEDERAL-AID HIGHWAY PROJECT

ROW PLANS AUTHORIZED:

DATE

CDOT ROW PROGRAM MANAGER

SURVEYOR STATEMENT (ROW PLAN)

I<u>, Jeffry Fickelman</u>, a professional land surveyor licensed in the State of Colorado, do hereby state to the Colorado Department of Transportation that based upon my knowledge, information and belief, research, calculations and evaluation of the survey evidence were performed and this Right-of-Way Plan was prepared under my responsible charge in accordance with applicable standards of practice defined by Colorado Department of Transportation publications.
This statement is not a quaranty or warranty, either expressed or implied.

PLS No. 29034

End ROW Project Station: 131+85.7

Begin ROW Project

Station: 107+47.6 M.P.: 140.70

M.P.: 141.36

TERRAIN

SURVEY/ROW

Note: For a complete listing of symbology used within this set of plans, please refer to the M-100-1 Standard Symbols of the Colorado Department of Transportation M&S Standards Publication dated July 2006. Existing topo features are shown as screened weight (gray scale). Proposed or new features are shown as full weight without screening. except as noted with the word (proposed).

AT PAGE

DAY OF , 20_____ OF THE COUNTY LAND SI _____ , RECEPTION NU

Region 2

P.D. Box 536 905 Erie Avenue Pueblo, CD 81002 Phone: 719-546-5496 FAX: 719-546-5414

| Sheet Revisions | | | | Sheet Revisions | | Sheet Revisions | | |
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Right of Way Plans Tabulation of Properties

Project Number: IM 0252-423
Project Location: I-25 & Cimarron (US 24) Interchange

| roject Code: | Last Mod. Date | Subset | Sheet No. | |
|--------------|----------------|--------------|-----------|--|
| 19039 | 03-21-14 | 2.01 of 2.02 | 2.01 | |

| | | | S IN EL PASO COUNT | | | Square Feet | | | Book and Page No. And/Or | Title | Remarks |
|------------|---------------------------------------|-----------------------|------------------------------------|-------------------|-----------------|-------------|-------------------|--------------------|-----------------------------|----------------|--|
| Parcel No. | Ownership Name and Mailing Address | Site Address | Location | Area Of Parcel | Existing ROW | Net Area | Remainder Left | Remainder Right | Reception No. | Commitment No. | TO MATERIAL PROPERTY OF THE PR |
| PE-1 | City of Colorado Springs | Bear Creek | NE 1/4 Sec 24, T. 14 S., R. 67 W., | 1,032 sqft. | | 0.024 ac. | | | | | For Drainage Improvements and maintenance |
| | City Hall | | of the 6th P.M. | | | | | | 1 | | |
| | Colorado Springs, CO 80903 | | | | | | | | | | |
| RW-2 | Wal-Mart Real Estate | 707 S. Eighth St. | NE 1/4 Sec 24 & SE 1/4 Sec 13, , | 42,668 sqft. | | 0.980 ac. | | | | | For Interstate Improvements |
| | PO Box 8050 M/S 0555 | Colorado Springs, CO. | T. 14 S., R. 67 W. of the 6th P.M. | | | | | | | | |
| | Bentonvile AR 72712-8055 | | | | | | | | | | |
| PE-2A | Wal-Mart Real Estate | 707 S. Eighth St. | NE 1/4 Sec 24, T. 14 S., R. 67 W., | 12,294 sqft. | | 0.282 ac. | | | | | For Drainage and Embankement improvements and ma |
| | PO Box 8050 M/S 0555 | Colorado Springs, CO. | of the 6th P.M. | | | | | | | | |
| | Bentonvile AR 72712-8055 | | | | | | | | | | |
| PE-2B | Wal-Mart Real Estate | 707 S. Eighth St. | NE 1/4 Sec 24 & SE 1/4 Sec 13, , | 2,953 sqft. | | 0.068 ac. | | | | | For Construction and Maintenance of Interstate Improvem |
| | PO Box 8050 M/S 0555 | Colorado Springs, CO. | T. 14 S., R. 67 W. of the 6th P.M. | | | | | | | | |
| | Bentonvile AR 72712-8055 | | | | | | | | | | |
| RW-3 | City of Colorado Springs | Abbot Ln.at I-25 | SE 1/4 Sec 13, T. 14 S., R. 67 W., | 7,319 sqft. | | 0.168 ac. | | | | | For Interstate Improvements |
| | PO Box 1575 | | of the 6th P.M. | | | | | | | 1 | |
| | Colorado Springs, CO 80901 | | | | | | | | | | |
| RW-4 | Humane Society | same | SE 1/4 Sec 13, T. 14 S., R. 67 W., | 73,861 sqft. | | 1.696 ac. | | | | | For Interstate Improvements |
| | 610 Abbot Ln. | | of the 6th P.M. | | | | | | | | |
| | Colorado Springs, CO 80905 | | | | | | | | | | |
| TE-4 | Humane Society | same | SE 1/4 Sec 13, T. 14 S., R. 67 W., | 5,838 sqft. | | 0.134 ac. | | | | | For Construction access |
| | 610 Abbot Ln. | | of the 6th P.M. | | | 100 | | | | | |
| | Colorado Springs, CO 80905 | | | | | | | | | | |
| RW-4A | Humane Society of Pikes Peak | same | SE 1/4 Sec 13, T. 14 S., R. 67 W., | 17,817 sqft. | | 0.409 ac. | | | | | For Interstate Improvements |
| | 630 Abbot Ln. | | of the 6th P.M. | | | | | | | 4 | |
| | Colorado Springs, CO 80905 | | | | | | | | | | |
| RW-5 | City of Colorado Springs | 508 Conejos St. | SE 1/4 Sec 13, T. 14 S., R. 67 W., | 4,521 sqft. | | 0.104 ac. | | | | | To be retained by the city of Colorado Springs |
| | PO Box 1575 | | of the 6th P.M. | | | | | | | | for roadway purposes |
| | Colorado Springs, CO 80901 | |) | | | | | | | | |



Region 2

P.D. Box 536 905 Erie Avenue Pueblo, CD 81002 Phone: 719-546-5496 FAX: 719-546-5414

| | Sheet Revisions | | | Sheet Revisions | | | Sheet Revisions | |
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Right of Way Plans Tabulation of Properties

Project Number: IM 0252-423
Project Location: I-25 & Cimarron (US 24) Interchange

| Project Code: | Last Mod. Date | Subset | Sheet No. | |
|---------------|----------------|--------------|-----------|--|
| 19039 | 03-21-14 | 2.02 of 2.02 | 2.02 | |

| | | N OF TROPERTIE | O IN ET TUSO COOK | El Paso COUNTY Interstate NO | | Square Feet | t (Acres) | | Book and Page No. And/Or | Title | Remarks |
|-----------|---------------------------------------|----------------|------------------------------------|------------------------------|-----------------|-------------|-------------------|--------------------|-----------------------------|----------------|------------------------------|
| arcel No. | Ownership Name and Mailing Address | Site Address | Location | Area Of Parcel | Existing ROW | Net Area | Remainder Left | Remainder Right | Reception No. | Commitment No. | Remarks |
| RW-6 | Harry W. Hoth | 660 Abbot Ln. | SE 1/4 Sec 13, T. 14 S., R. 67 W., | 3,523 sqft. | | 0.081 ac. | | | | | For Interchange Improvements |
| | PO Box 1423 | | of the 6th P.M. | | | | | | | | |
| | Colorado Springs, CO. 80901 | | | | | | | | | | |
| RW-7 | Pikes Peak Broadcasting LLC | S. 8th St. | SE 1/4 Sec 13, T. 14 S., R. 67 W., | 137,297 sqft | | 3.152 ac. | | | | | For Interchange Improvements |
| 27137 7 | 2180 Rocking Horse CT. | | of the 6th P.M. | 141,042,441 | | 410,830,431 | | | | | |
| | Colorado Springs, CO. 80921 | | 0. 0.0 0.0 1.1.1.1. | | | | | | | | |
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Region 2

P.O. Box 536 905 Erie Avenue Pueblo, CD 81002

Phone: 719-546-5496 FAX: 719-546-5414

DONTROL MONUMENT

| | Sheet Revisions | | | Sheet Revisions | Sheet Revisions | | | |
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Project Location: I-25 & Cimarron (US 24) Interchange

Project Control Diagram


| 5 | ject Code: | Last Mod. Date | Subset | Sheet No. | |
|---|------------|----------------|--------------|-----------|--|
| | 19039 | 03-24-14 | 3.01 of 3.02 | 3.01 | |

| REGION | DIVISION | PROJ. NO. | NUMBER | SHEETS |
|--------|----------|------------|--------|--------|
| VIII | COLO. | IMO252-334 | 3 | 10 |

| RIGHT OF WAY | REVISIONS |
|-----------------------------|-----------|
| INTERSTATE 25 | |
| BIJOU/CIMARRON INTERCHANGES | |

SURVEY CONTROL DIAGRAM

SECTIONS 13 AND 24, TOWNSHIP 14 SOUTH, RANGE 67 WEST SECTIONS 18, TOWNSHIP 14 SOUTH, RANGE 66 WEST OF THE SIXTH PRINCIPAL MERIDIAN EL PASO COUNTY, COLORADO

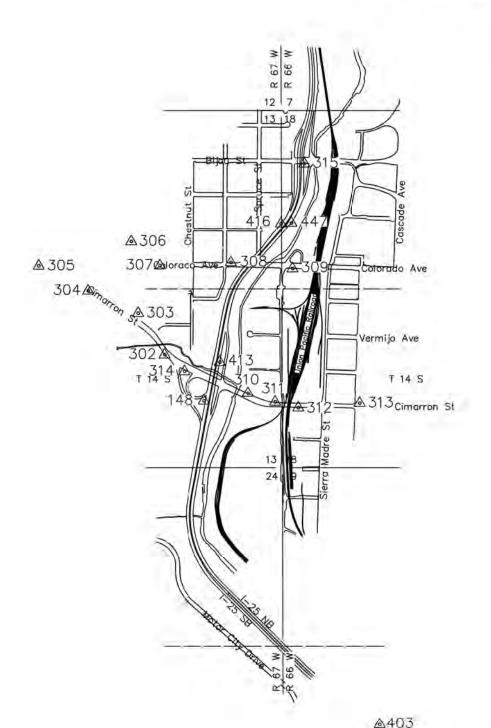



GENERAL NOTES

1. The Coordinates of the GPS points were adjusted from NAD 83 (1992) Colorado Central Zone State Plane Coordinate System to the Modified Grid System using the following parameters:

= 5983.9 U.S. feet = 55.177 U.S. feet Mean Elevation Mean Geoid Height Mean Sea Level Factor = 0.999716483 Mean Grid Factor = 0.999946840 North: 1,300,000 East: 3,000,000

Combined Scale Factor = 0.999663338

- 2. All coordinates listed are U.S. feet.
- 3. GPS Network adjustment was constrained using the following published coordinates:

Points published by the National Geodetic Survey:

| PID | Designation | Latitude | Longitude |
|--------|-------------|-----------------|------------------|
| JK1384 | GPS 3 | 38*48'50.67573" | 104*49'35.28805" |
| AE4290 | GPS 7 | 38'54'42.73581" | 104'49'15.88400" |
| AF4291 | JONES | 38'49'40 68889" | 104.47'33.70523" |

4. Primary Benchmarks for the project were the following Benchmarks as published by the National Geodetic Survey:

PID Designation NAVD 88 Elevation (U.S. feet)

JK0843 A 396 5959.95

Note: Elevations reported are established by GPS observations or spirit levels as indicated.

Note: Closed successfully into CDOT JF46 & JF47.

- 5. NOTICE: According to Colorado Law, you must commence any legal action based upon any defect in this survey within three years after you discover such defect. In no event may any action based upon any defect in this survey be commenced more than ten years from the date of the certificate shown hereon.
- 6. Basis of Bearings: The line between the found 3 ¼ inch aluminum cap LS 25361, being the Northeast corner of section 13, Township 14 South, Range 67 West (#30) and the Found 3 ¼ inch witness corner aluminum cap LS 25362 being a witness to the East quarter of section 13, Township 14 South, Range 67 West (#31) is determined to be N00"12'31"W grid bearing by using calculated coordinates from Clobal Positioning System (GPS) survey performed September of 2002.
- 7. This control survey is not a complete boundary survey and is prepared for the use of the Colorado Department of Transportation only.

Note:

This project control diagram is from existing project No. IM 0252-334 done by Wilson & Co. Field checks were performed and varified for accuracy.

Region 2

P.O. Box 536 905 Erie Avenue Pueblo, CO 81002 Phone: 719-546-5496 FAX: 719-546-5414

| | Sheet Revisions | | | Sheet Revisions | | | Sheet Revisions | |
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FED. ROAD DIVISION

RIGHT OF WAY

INTERSTATE 25
BIJOU/CIMARRON INTERCHANGES

COLO.

VIII

| Projec | Project Control Diagram | | | | | | | |
|---------------------------|-------------------------|-----------------|--|--|--|--|--|--|
| Coordinate Tables | | | | | | | | |
| Project Number: IM | | | | | | | | |
| Project Location: I-2 | 25 & Cimarron (US | 24) Interchange | | | | | | |
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PROJ. NO.

IMO252-334

SHEET TOTAL NUMBER SHEETS

3A 10

REVISIONS

SURVEY CONTROL TABULATION SHEET TABULATION OF GPS PROJECT CONTROL POINTS

SECTIONS 13 AND 24, TOWNSHIP 14 SOUTH, RANGE 67 WEST SECTIONS 18, TOWNSHIP 14 SOUTH, RANGE 66 WEST OF THE SIXTH PRINCIPAL MERIDIAN EL PASO COUNTY, COLORADO

| POINT | NAD 83(1992) GEC | DETIC COORDINATES | ELLIPSOID HEIGHT | COLORADO S | TATE PLANE | POINT | PROJECT CO | ORDINATES | | |
|-----------|---------------------|----------------------|---------------------------------------|-------------|-----------------|-----------|------------|-----------------|---------|-------------------------------|
| NUMBER | LATITUDE | LONGITUDE | LONGITUDE (US FT) NORTHING (US FT) EA | | EASTING (US FT) | | | EASTING (US FT) | ELEV | DESCRIPTION |
| 148 | 38' 49' 38,13630" N | 104' 50' 07.71425" W | 5913.699 | 1362675.885 | 3189308.869 | 148 | 63134.801 | 190382,949 | 5968.83 | 3 1/4" CDOT Control Monument |
| 302 | 38' 49' 44.95087" N | 104' 50' 15.03881" W | 5913.141 | 1363361.029 | 3188724.237 | 302 | 63820.175 | 189798,121 | 5968.19 | 2" WCEA Aluminum Cop |
| 303 | 38' 49' 51.00432" N | 104' 50' 19.90874" W | 5913.748 | 1363970,601 | 3188334.424 | 303 | 64429,953 | 189408,177 | 5968.76 | 2" WCEA Aluminum Cap |
| 304 | 38° 49' 54.30171" N | 104° 50' 29.15620" W | 5924.243 | 1364298.857 | 3187600.277 | 304 | 64758,319 | 188673.782 | 5979.17 | 2" WCEA Aluminum Cap |
| 305 | 38' 49' 57.96687" N | 104° 50′ 38.30886″ W | 5930.398 | 1364664.393 | 3186873.380 | 305 | 65123.978 | 187946.640 | 5985.29 | 2" WCEA Aluminum Cap |
| 306 | 38° 50' 01.42882" N | 104° 50' 21.08636" W | 5948.548 | 1365024.488 | 3188233.572 | 306 | 65484.194 | 189307.290 | 6003.55 | 2" WCEA Aluminum Cap |
| 307 | 38' 49' 57.88474" N | 104° 50' 15.78089" W | 5936.300 | 1364669.018 | 3188655.977 | 307 | 65128.605 | 189729.838 | 5991.34 | 2" WCEA Aluminum Cap |
| 308 | 38' 49' 58.27215" N | 104° 50' 02.47912" W | 5917.193 | 1364715.904 | 3189708.200 | 308 | 65175,507 | 190782.415 | 5972.26 | PK Nail in sidewalk |
| 309 | 38° 49° 57.31439" N | 104' 49' 50.99562" W | 5940.119 | 1364625.692 | 3190617-551 | 309 | 65085.265 | 191692,072 | 5995.28 | PK Nail in sidewalk |
| 310 | 38' 49' 39,23784" N | 104' 49' 59,47999" W | 5912.649 | 1362792,094 | 3189959.642 | 310 | 63251,049 | 191033.942 | 5967.77 | 2" WCEA Aluminum Cap |
| 311 | 38' 49' 37.89824" N | 104° 49' 54,41785" W | 5935.926 | 1362659,520 | 3190361.212 | 311 | 63118.431 | 191435.647 | 5991.12 | 2" WCEA Aluminum Cop |
| 312 | 38" 49" 37.02539" N | 104' 49' 50.10018" W | 5938.525 | 1362573,737 | 3190703.527 | 312 | 63032.618 | 191778.077 | 5993.77 | 2" WCEA Aluminum Cap |
| 313 | 38' 49' 37.62783" N | 104' 49' 38.57079" W | 5925.592 | 1362641.420 | 3191615.419 | 313 | 63100.324 | 192690.276 | 5980.92 | 2" WCEA Aluminum Cap |
| 314 | 38° 49° 42.50423" N | 104' 50' 11.34973" W | 5903.531 | 1363115.651 | 3189017.960 | 314 | 63574.715 | 190091.943 | 5958.62 | 2" WCEA Aluminum Cop |
| 315 | 38° 50' 12.61725" N | 104° 49' 48.64851" W | 5939.801 | 1366175.130 | 3190791.852 | 315 | 66635.224 | 191866.432 | 5995.04 | 2" WCEA Aluminum Cap |
| 413(4130) | 38* 49" 43.80237" N | 104° 50′ 04.68127″ W | 5933.098 | 1363250.834 | 3189544.675 | 413(4130) | 63709.943 | 190618.835 | 5988.27 | 3 1/4" CDOT Control Monument |
| 416(4165) | 38° 50' 03.91425" N | 104° 49′ 53.07823″ W | 5934.877 | 1365292.135 | 3190447.848 | 416(4165) | 65751.931 | 191522.313 | 5990.09 | 3 1/4" CDOT Control Monument |
| 403(GPS3) | 38' 48' 50.67573" N | 104* 49* 35.28805" W | 5859.772 | 1357893.578 | 3191910,403 | 403(GPS3) | 58350.883 | 192985,360 | 5915.20 | 3 1/4" NGS Brass Disk "GPS 3 |
| 407(GPS7) | 38° 54' 42,73581" N | 104' 49' 15.88400" W | 6190.460 | 1393520.226 | 3193179.992 | 407(GPS7) | 93989.530 | 194255.377 | 6245.52 | 3 1/4" NGS Brass Disk "GPS 7" |
| 446(JF46) | 38' 49' 56.65570" N | 104" 50' 01.11094" W | 5947.619 | 1364553.174 | 3189817.657 | 446(JF46) | 65012,722 | 190891.909 | 6002.71 | 3 1/4" CDOT Control Monument |
| 447(JF47) | 38' 50' 04.01327" N | 104' 49' 51.14249" W | 5937.406 | 1365303.279 | 3190600.938 | 447(JF47) | 65763.080 | 191675.454 | 5992.62 | 3 1/4" CDOT Control Monument |
| 448JONES) | 38' 49' 40.68889" N | 104° 47' 33.70523" W | 6045.739 | 1363026.126 | 3201493.823 | 448JONES) | 63485.160 | 202572.007 | 6101.95 | 3 1/4" NGS Brass Disk "JONES |
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CONTROL MONUMENT CAP

Region 2

P.O. Box 536

905 Erie Avenue Pueblo, CD 81002 Phone: 719-546-5496 FAX: 719-546-5414

| | Sheet Revisions | | | Sheet Revisions | | | Sheet Revisions | |
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| Date | Description | Initials | Date | Description | Initials | Date | Description | Initials |
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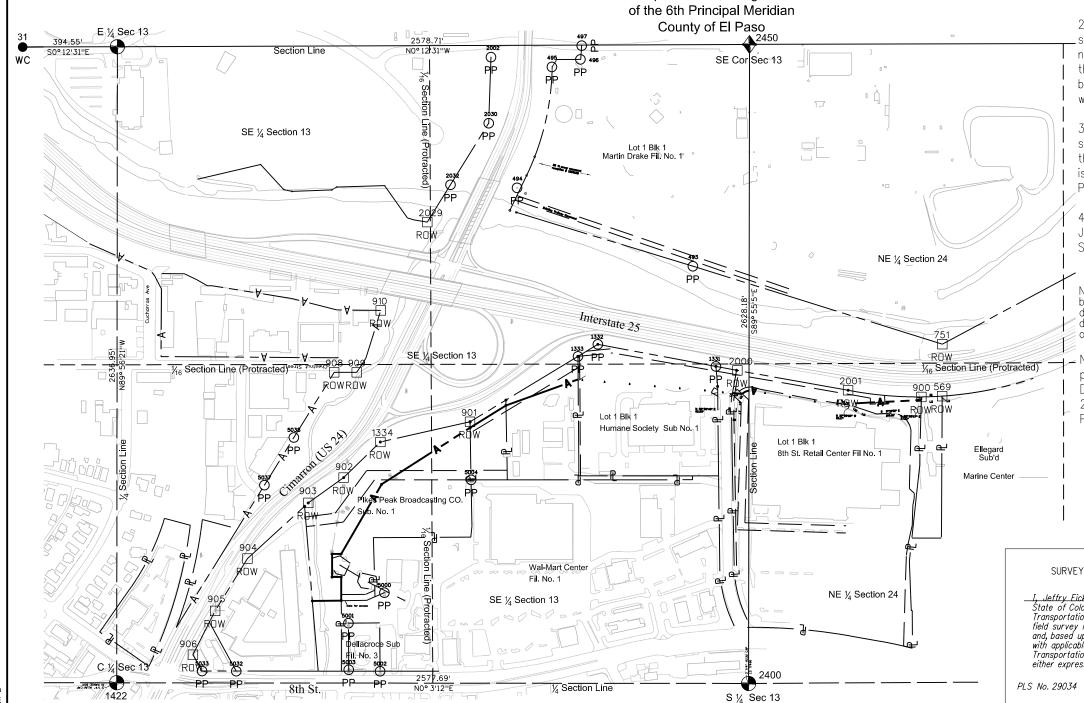
| <u>La</u> | Land Survey ControlDiagram | | | | | | | | | |
|---------------|----------------------------|----------------|-----------------|--|--|--|--|--|--|--|
| | Plan Sheet | | | | | | | | | |
| Project Nu | mber: IM 02 | 52-423 | | | | | | | | |
| Project Lo | cation: I-25 | & Cimarron (US | 24) Interchange | | | | | | | |
| | | | | | | | | | | |
| Project Code: | Last Mod. Date | Subset | Sheet No. | | | | | | | |
| 19039 | 03-25-14 | 4.01 of 4.02 | RW 4.01 | | | | | | | |

DEPARTMENT OF TRANSPORTATION

STATE OF COLORADO

LAND SURVEY CONTROL DIAGRAM

Sections 13 & 24 Township 14 South, Range 67 West of the 6th Principal Meridian




General Notes:

- 1. This land survey control diagram is from existing project no. IM0252-334 done by Wilson & Co. Field checks were performed on control points in the field and variefied for their accuracy.
- 2. Title policy, title commitment, and title research are not part of this survey, therefore easements, rights, and restrictions of record were not researched and are not shown on this diagram. The verification of the physical evidence with relation to easements, rights of ways, property boundaries, and restrictions, as described in the instruments of record, were not included in this land survey control diagram.
- This plan set is subject to change and may not be the most current set. It is the user's responsibility to verify with CDOT that this set is the most current. The information contained on the attached drawing is not valid unless this copy bears an original signature of the Professional Land Surveyor hereon named.
- Refer to the M-629-1 Survey Monuments of the Standard Plans dated July, 2006 found in The Colorado Department of Transportation, M & S Standards for typical survey monument descriptions.

NOTICE: According to Colorado law you must commence any legal action based upon any defect in this survey within three years after you first discover such defect. In no event may any action based upon any defect in this survey be commenced more than ten years from the date of the certification shown hereon.

Note: For a complete listing of symbology used within this set of plans, please refer to the M-100-1 Standard Symbols of the Colorado Department of Transportation M&S Standards Publication dated July 2006. Existing features are shown as screened weight (gray scale). Proposed or new features are shown as full weight without screening.

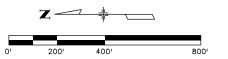

SURVEYOR STATEMENT (LAND SURVEY CONTROL DIAGRAM)

field survey it represents was performed under my responsible charge and, based upon my knowledge, information and belief is in accordance with applicable standards of practice defined by Colorado Department of Transportation publications. This statement is not a guaranty or warranty, either expressed or implied.

Region 2

P.O. Box 536 905 Erie Avenue Pueblo, CO 81002 Phone: 719-546-5496 FAX: 719-546-5414

| | Sheet Revisions | | | Sheet Revisions | | | Sheet Revisions | |
|---------|-----------------|----------|----------|-----------------|----------|----------|-----------------|----------|
| Date | Description | Initials | Date | Description | Initials | Date | Description | Initials |
| n/dd/yy | XXXXXXX | XXX | mm/dd/yy | XXXXXXX | XXX | mm/dd/yy | XXXXXXX | XXX |
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| La | nd Surv | ey ControlD | iagram | | | |
|----------------------------|----------------|------------------|----------------|-------------|--|--|
| Monument Coordinate Tables | | | | | | |
| | mber: IM 02 | | | | | |
| Project Lo | cation: I-25 | & Cimarron (US 2 | 4) Interchange | | | |
| | | | | | | |
| Project Code: | Last Mod. Date | Subset | Sheet No. | | | |
| | 04-03-14 | 4.02 of 4.02 | 4.02 | | | |

LAND SURVEY CONTROL TABULATION SHEET

SECTIONS 13 AND 24, TOWNSHIP 14 SOUTH, RANGE 67 WEST SECTIONS 18, TOWNSHIP 14 SOUTH, RANGE 66 WEST OF THE SIXTH PRINCIPAL MERIDIAN EL PASO COUNTY, COLORADO

| | REGION | DIVISION | | PROJ. NO. | NUMBER | SHEETS |
|-------|----------|---------------------|-----|------------|--------|--------|
| | VIII | COLO. | | IMO252-334 | 4 | 10 |
| | RIGHT (| OF WAY | | REV | ISIONS | |
| BIJOU | INTERST. | ATE 25 INTERCHAN | GES | | | |

TABULATION OF FOUND PROPERTY CORNERS

| POINT | PROJECT CO | ORDINATES | | |
|--------------|------------------------|--------------------------|---------|------------------------|
| NUMBER | NORTHING (US FT) | EASTING (US FT) | ELEV | DESCRIPTION |
| 22 | 66592.391 | 192689.844 | 6011.22 | Rebar w/Cap 13830 |
| 23 | 66565.158 | 192650.637 | 6010.64 | Rebar w/Cap 13830 |
| 24 | 66542.100 | 192644.603 | 6009.68 | Rebar w/Cap 13830 |
| 25 | 66345.596 | 192769.500 | 6007.93 | Rebor w/Cap 13830 |
| 26 | 66272.425 | 192809.172 | 6007.75 | Rebar w/Cap 13830 |
| 27 | 66413.584 | 192590.187 | 6005.61 | 5/8" Rebar |
| 110 | 66615.543 | 192535.442 | 6012.33 | 1" Alum Cap/illeg |
| 111 | 66211.990 | 192551.378 | | Rebar w/Cap KRAETLI |
| 359 | 65379.096 | 190941.722 | | 1" Pipe |
| 360 | 63852.576 | 190435.129 | 5960.06 | 1" Iron Pipe |
| 379 | 64130.862 | 190024.464 | 2.72.70 | 1" Pipe |
| 380 | 64230.271 | 190024.920 | | 1" Pipe |
| 464 | 65038.671 | 191392.303 | 11 | 1/2" Rebor YPC 13830 |
| 494 | 63109.150 | 190944.293 | 5950.60 | 5/8" Rebar in Conc |
| 495 | 62964.995 | 191448.334 | 5961.53 | 5/8" Rebar |
| 496 | 62845.935 | 191479.541 | 5962.30 | 5/8" Rebar |
| 497 | 62840.899 | 191536.651 | 5964.67 | PK Nail |
| 1041 | 65034.737 | 191481.891 | 5975.24 | 1/2" Rebar |
| 1331 | 62281,406 | 190199.261 | 5946.53 | 1 1/2" Alum Cap HOOK |
| 1333 | 62856.366 | 190241,551 | 5947.50 | 1" Iron Pipe |
| 1356 | 65377.945 | 191141.409 | 2017.00 | 1" Pipe |
| 1429 | 65190.050 | 191041-087 | | 1" Iron Pipe |
| 1430 | 64882.791 | 190238.026 | 1 | 1/2" Rebar |
| 1431 | 64592.836 | 190236.703 | - | 5/8" Rebar |
| 2002 | 61338.210 | 190061.000 | 5950.22 | 1 1/2" Alum Cap 25361 |
| 2003 | 61331,290 | 190076,600 | 5946.31 | 5/8" Rebar |
| 2016 | 65085.703 | 191482.782 | 0340.51 | 2" WCEA Alum Cap 25361 |
| 2017 | 65089.615 | 191239.286 | - | 2" WCEA Alum Cap 25361 |
| 2030 | 63228.184 | 191214.186 | | 2" WCEA Alum Cap 25361 |
| 2032 | 63387.353 | 190957.720 | | 60D Nail |
| 2038 | 66249.563 | 192213.017 | | 2" WCEA Alum Cap 25361 |
| 2039 | 66444.276 | 192221.705 | | 2" WCEA Alum Cap 25361 |
| 2040 | 66491.750 | 192216.101 | 1 | 2" WCEA Alum Cap 25361 |
| 2040 | 66530.243 | 192212.761 | - | 2" WCEA Alum Cop 25361 |
| 2042 | 66872.176 | 192197.256 | - | 2" WCEA Alum Cap 25361 |
| 2043 | 66974.309 | 192224.544 | 1 | 2" WCEA Alum Cap 25361 |
| 2044 | 67008.541 | 192244.111 | 1 | 2" WCEA Alum Cap 25361 |
| 2044 | 66743.087 | 192244.111 | 1 | 2" WCEA Alum Cap 25361 |
| 2527 | 64590.642 | 190562.448 | - | PK Nail |
| 2529 | 64880.846 | 190594.323 | | Axle |
| 2530 | 64880.691 | 190589.526 | - + | Axie |
| 2532 | 64881.257 | 190569.526 | - 4 | Axie |
| 2533 | 64880.990 | 190612.378 | | Axle |
| 5032 | 64280.646 | 188929.406 | | 1/2" Rebar |
| 5033 | 64423.378 | 188930.344 | | Rebar W/YPC K&W 3854 |
| 5035 | 64718.252 | 189280.620 | 1 | Rebar W/Cap 2692 |
| 5036 | 64211.885 | 189664.447 | - 1 | Conc Nail |
| 5037 | 64162.992 | 189705.002 | 1 | 1/2" Rebar w/YPC illeg |
| 5038 | 64040.390 | 189903.529 | | 1/2" Rebar w/YPC illeg |
| | | | 5984.58 | 5/8" Rebar |
| 9790 9791 | 66826.174 | 191659.554 191548.925 | 5983.73 | Rebar w/YPC |
| 9792 | 66726.753 66729.754 | | 5986.39 | 5/8" Rebar |
| | | 190948.083 | 5989.07 | 5/8" Rebar |
| 9793 | 66730.794 | 190797.925 | 3303.07 | 2" WCEA Alum Cap 25361 |
| 9794 | 63218.820 | 191488.078 | - | Z WOLA Alum Cap 20001 |

TABULATION OF FOUND ALIQUOT CORNERS

| POINT | PROJECT CO | ORDINATES | |
|--------|------------------|-----------------|---|
| NUMBER | NORTHING (US FT) | EASTING (US FT) | DESCRIPTION |
| 31 | 65170.577 | 191530.973 | 3 1/4" WC Alum Cap 25361 - E1/4 13, T14S R67W |
| 449 | 67405.085 | 188886.337 | 2 1/2" Alum Cap 22573 - N1/4 13, T14S R67W |
| 1422 | 64778.837 | 188880.835 | 3 1/4" Alum Cap in Range Box 10377 - C1/4 13, T14S R67W |
| 2400 | 62144.893 | 188878.387 | 3 1/4" Alum Cap 17496 - S1/4 13, T14S R67W |
| 2450 | 62141.082 | 191542,002 | 3 1/4" Alum Cap 29051 - SE 13, T14S R67W |
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TABULATION OF FOUND RIGHT OF WAY MONUMENTS

| POINT | PROJECT CO | ORDINATES | | |
|--------|------------------|-----------------|---------|------------------------------|
| NUMBER | NORTHING (US FT) | EASTING (US FT) | ELEV | DESCRIPTION |
| 355 | 64024.560 | 191595.092 | 5977.10 | 1" Pipe |
| 357 | 65327.978 | 191140.966 | 5974.01 | 1" Pipe |
| 366 | 56124.595 | 191595.178 | 5975.93 | 1/2" Rebor |
| 371 | 64381.665 | 190535.753 | | 1 1/2" Rebar in Conc |
| 491 | 64459.854 | 190845.671 | | 1 1/2" Alum Cap JR Eng 10377 |
| 493 | 62377.250 | 190617.423 | 5939.00 | 5/8" Rebor |
| 569 | 61338,130 | 190076.100 | | 3" Iron Pipe |
| 751 | 61337.716 | 190292.653 | 5927.68 | 3 1/4" CDOT Alum Cap 29051 |
| 904 | 64233.610 | 189398.956 | | YPC LS 23890 |
| 1332 | 52773.425 | 190291.824 | 5947.64 | 1" Iran Pipe in Conc |
| 1334 | 63679.880 | 189884.747 | 5956.26 | 1 1/2" Iron Pipe in Conc |
| 1335 | 65512,106 | 191242,309 | | 5/8" Rebor |
| 1336 | 65585,931 | 191317.040 | | Rebar w/RPC 28651 |
| 1338 | 65747.639 | 191410.464 | | Rebor w/Cop WKC 4842 |
| 1339 | 65915,709 | 191544,061 | | Rebor w/Cap COX 7228 |
| 1364 | 64900.838 | 190658.297 | | 1" Pipe |
| 1432 | 64691,211 | 190561.648 | | Axle |
| 1433 | 64510,187 | 190849.573 | | 1 1/2" Alum Cap JR Eng 10377 |
| 2000 | 62191.520 | 190182.900 | 5945.23 | 5/8" Iron Rod w/YPC LS 9646 |
| 2001 | 61730,060 | 190100.500 | 5939.42 | 5/8" Iron Rod w/YPC LS 9646 |
| 2018 | 65089,715 | 191139.042 | | 2" WCEA Alum Cap 25361 |
| 2019 | 54880.144 | 191013.085 | | 2" WCEA Alum Cap 25361 |
| 2020 | 64749.518 | 190937.341 | | 2" WCEA Alum Cap 25361 |
| 2021 | 54688.429 | 190936,992 | | 2" WCEA Alum Cap 25361 |
| 2022 | 54588.859 | 190851.423 | | 2" WCEA Alum Cop 25361 |
| 2023 | 64510.614 | 190858.258 | | 2" WCEA Alum Cap 25361 |
| 2025 | 64179.114 | 191041.244 | | 2" WCEA Alum Cap 25361 |
| 2026 | 63662.123 | 190953.136 | | 2" WCEA Alum Cop 25361 |
| 2027 | 63566.665 | 190818.561 | | 2" WCEA Alum Cap 25361 |
| 2028 | 63537.835 | 190810.069 | | 2" WCEA Alum Cap 25361 |
| 2029 | 63484.485 | 190801.213 | | 2" WCEA Alum Cap 25361 |
| 2526 | 64880.963 | 190638.193 | | 1/2" Rebor |

Region 2

P.O. Box 536

7.1. 50x 536 905 Erie Avenue Pueblo, CO 81002 Phone: 719-546-5496 FAX: 719-546-5414

| I | | Sheet Revisions | | | Sheet Revisions | | | Sheet Revisions | |
|---|----------|-----------------|----------|----------|-----------------|----------|----------|-----------------|----------|
| ı | Date | Description | Initials | Date | Description | Initials | Date | Description | Initials |
| ı | mm/dd/yy | XXXXXXXX | XXX | mm/dd/yy | XXXXXXXX | XXX | mm/dd/yy | XXXXXXXX | XXX |
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Right of Way Plans Monumentation Sheet

Project Number: IM 0252-423

Project Location: I-25 & Cimarron (US 24) Interchange

| oject Code: | Last Mod. Date | Subset | Sheet No. | |
|-------------|----------------|--------------|-----------|--|
| 19039 | 04-01-14 | 5.01 of 5.01 | 5.01 | |



| Point No. | Northing(ft) | Easting(ft) | Description | Station | Offset |
|-----------|--------------|-------------|-------------|----------|----------|
| 200 | 61425.12 | 190072.76 | CDOT Type I | 107+50.4 | 98.8 L |
| 201 | 61425.44 | 190059.4 | CDOT Type I | 107+52.1 | 112.0 L |
| 202 | 61702.04 | 190046.12 | CDOT Type I | 110+13.5 | 114.2 L |
| 203 | 61772.05 | 190061.75 | CDOT Type I | 110+80.3 | 101.9 L |
| 204 | 61775.97 | 190038.66 | CDOT Type I | 110+82.6 | 125.3 L |
| 205 | 61865.13 | 190053.70 | CDOT Type I | 111+67.2 | 118.2 L |
| 206 | 62114.05 | 190097.07 | CDOT Type I | 114+14.4 | 112.4 L |
| 207 | 62171.98 | 190085.41 | CDOT Type I | 114+69.8 | 133.0 L |
| 208 | 62212.26 | 190089.28 | CDOT Type I | 115+10.2 | 135.5 L |
| 209 | 62273.95 | 190095.78 | CDOT Type I | 115+72.3 | 138.8 L |
| 300 | 63112.98 | 190841.91 | CDOT Type I | 730+20.3 | 85.2 L |
| 301 | 63074.91 | 190920.77 | CDOT Type I | 731+4.2 | 90.0 L |
| 302 | 63036.35 | 191074.08 | CDOT Type I | 732+51.7 | 81.4 L |
| 400 | 62855.60 | 190145.61 | CDOT Type I | 121+52.0 | 182.4 L |
| 403 | 63156.13 | 190037.40 | CDOT Type I | 124+29.7 | 340.2 L |
| 500 | 63305.65 | 189944.42 | CDOT Type I | 125+61.4 | 457.2 L |
| 600 | 63674.84 | 189708.08 | CDOT Type I | 128+85.0 | 752.9 L |
| 601 | 63843.34 | 189418.18 | CDOT Type I | 130+01.7 | 1067.2 L |
| 602 | 63881.29 | 189418.18 | CDOT Type I | 130+39.1 | 1073.7 L |
| 603 | 63881.29 | 189321.92 | CDOT Type I | 130+22.7 | 1168.5 L |
| 604 | 63843.08 | 189321.92 | CDOT Type I | 129+85.1 | 1162.02 |
| 605 | 63842.82 | 189223.60 | CDOT Type I | 129+68.0 | 1258.0 L |
| 606 | 63963.19 | 189222.15 | CDOT Type I | 130+86.5 | 1280.8 L |
| | | | | | |
| | 10 | | | | |



| TABULATION OF PERMANENT EASEMENT MONUMENTS TO BE SET | | | | | | | | | | |
|--|--------------|-------------|-------------|---------|--------|--|--|--|--|--|
| Point No. | Northing(ft) | Easting(ft) | Description | Station | Offset | | | | | |
| 100 | 61343.14 | 190075.73 | CDOT Type 6 | | | | | | | |
| 101 | 61342.94 | 190063.27 | CDOT Type 6 | | | | | | | |
| 210 | 61456.34 | 190057.92 | CDOT Type 6 | | | | | | | |
| 211 | 61458.87 | 190010.11 | CDOT Type 6 | | | | | | | |
| 212 | 61649.37 | 189999.46 | CDOT Type 6 | | | | | | | |
| 213 | 61712.55 | 190034.89 | CDOT Type 6 | | | | | | | |
| 214 | 61774.57 | 190046.93 | CDOT Type 6 | | | | | | | |
| 215 | 62185.84 | 190061.46 | CDOT Type 6 | | | | | | | |
| 216 | 62189.6 | 190032.91 | CDOT Type 6 | | | | | | | |
| 217 | 62192.65 | 189984.03 | CDOT Type 6 | | | | | | | |
| 218 | 62216.00 | 189985.31 | CDOT Type 6 | | | | | | | |
| 219 | 62217.31 | 190061.68 | CDOT Type 6 | | | | | | | |
| 220 | 61678.9 | 190009.04 | CDOT Type 6 | | | | | | | |



| Point No. | Northing(ft) | Easting(ft) | Description | Station | Offset |
|-----------|--------------|-------------|-------------|---------|--------|
| 401 | 62855.52 | 190135.57 | | | |
| 402 | 62273.83 | 190085.73 | | | |
| 100 | | | | | |
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QUANTITY OF MONUMENTS TO BE SET

| CAP | | | | MDΝ | IUMEN | T TY | PΕ | | | |
|----------------------------|----|----|---|-----|-------|-----------|----|---|------|----|
| TYPE | 1 | 1A | 2 | 2A | 3 | <i>3A</i> | 4 | 5 | 5(S) | 6 |
| REFERENCE | | | | | | | | | | |
| ROW | 23 | | | | | | | | | |
| CONTROL | | | | | | | | | | |
| ALIQUOT CORNER | | | | | | | | | | |
| PERMANENT EASEMENT | | | | | | | | | | 13 |
| PROJECT POINTS | | | | | | | | | | |
| | | | | | | | | | | |
| WITNESS POST (REQUIRED) | | | | | | | | | | |

General Notes:

- 1. All centerline and offset stationing may not represent the centerline as constructed in the field.
- 2. Refer to the M-629-1 Survey Monuments of the Standard Plans dated July, 2006 found in The Colorado Department of Transportation, M & S Standards for survey monument descriptions.
- 3. This plan set is subject to change and may not be the most current set. It is the user's responsibility to verify with CDOT that this set is the most current. The information contained on the attached drawing is not valid unless this copy bears an original signature of the Professional Land Surveyor hereon named.

CODRDINATE DATUM: Project coordinates are modified Colorado State Plane Central Zone NAD '83/(92) coordinates. The combined elevation/scale factor used to modify the coordinates from state plane to project coordinates is 1.00033677538. The resulting project coordinates are truncated by 1,300,000ft in the Northing and 3,000,000ft in the Easting after converting from state plane coordinates to project coordinates. The CHARN is based on the NAD '83(XX) datum. Project Coordinates Northing US Survey Feet = (State Plane Coordinate Northing * 1.00033677538 - 1,300,000ft). Project Coordinates Easting US Survey Feet

= (State Plane Coordinate Easting * 1.00033677538 - 3,000,000ft).

NOTICE: According to Colorado law you must commence any legal action based upon any defect in this survey within three years after you first discover such defect. In no event may any action based upon any defect in this survey be commenced more than ten years from the date of the certification shown hereon.

SURVEYOR STATEMENT (R.O.W. MONUMENTS)

I, Jeffry Fickelman , a professional land surveyor licensed in the State of Colorado, do hereby state to the Colorado Department of Transportation that based upon my knowledge, information and belief, adequate research, calculations and evaluation of survey evidence were performed and the Right-of-Way monuments depicted on this Right-of-Way Plan were set under my responsible charge in accordance with applicable standards of practice defined by Colorado Department of Transportation publications. This statement is not a guaranty or warranty, either expressed or implied.

PLS No. 29034

Sheet Revisions Sheet Revisions Sheet Revisions Right of Way Plans Colorado Department of Transportation Plan Sheet P.O. Box 536 IM 0252-423 905 Erie Avenue Pueblo, CO 81002 Project Number: I-25 & Cimarron (US 24) Interchange Project Location: Phone: 719-546-5496 FAX: 719-546-5414 Region 2 **DEPARTMENT OF TRANSPORTATION STATE OF COLORADO** SE 1/4 Sec 13 & NE 1/4 Sec 24, T. 14 S., R. 67 W. of the 6th PM See Sheet 2 for Detail of Existing Easements To Monument ô POB RW-4 C 1/4 Section 13 Bears: POB RW-2 & PE-1 C 1/4 Section 13 Bears; 472.57 N19°33'56"W, 3559.22 ft. (RW-2) Lc =306.70 S 80° 22'01" E 20 23.42' (206) 10.051 252.67 402 L2 N 06° 00'46" E 62.03" (PE-1 (PE-2B) 3° 12'01" E S 10° 59'29" W 63.17' S 86° 58'27'' E 47.87' 217 (218) C ¼ Section 13 Bears; Name N19°30'29"W, 3524.84 ft. POB PE-2B C ¼ Section 13 Bears; N23°06'06"W, 2811.66 ft. City of Colorado Springs P.O. Box 1575 Colorado Springs, CO 89901 Wal-Mart Real Estate P.O. Box 8050 M/S 0555 Bentonville AR 72712-8055 City of Colorado Springs (RW-3) (RW-2 (PE-2B) Colorado Springs, QO 80903 7,319 sqft. 42,668 sqft. 12,294 sqft. 2,953 sqft 0.068 ac. 0.168 ac. (PE-1) 1,032 sqft. 0.024 ac. SE ¼ Section 13 NE ¼ Section 24 **Curve Table** Middle External Radius Name Arc Chord Tangent Length Length Length Ordinate 1532.5 82.05 82.04 41.03 0.55

Line Table

Direction

N 88°38'18" W

S 02°41'10" E

N 89°05'08" E

N 79°38'14" W

S 89°01'08" W

S 03°07'14" W

S 86°26'10" E

S 82°29'07" E

N 05°29'31" E

S 37°31'38" W

S 17°58'25" W

Distance

2.79

35.69

28.42

27.67

15.01

Length

13.37

82.59

12.46

28.06

76.39

23.39

48.97

28.80

40.47

42.44

31.04

Chord

Direction

0.55 N 2°04'28" W

3.03 S 59°56'55" E

DOT

Region 2

P.O. Box 536 905 Erie Avenue Pueblo, CO 81002 Phone: 719-546-5496

FAX: 719-546-5414


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| | Sheet Revisions | | | Sheet Revisions | | | Sheet Revisions | |
| Date | Description | Initials | Date | Description | Initials | Date | Description | Initials |
| nm/dd/yy | XXXXXXXX | XXX | mm/dd/yy | XXXXXXXX | XXX | mm/dd/yy | XXXXXXXX | XXX |
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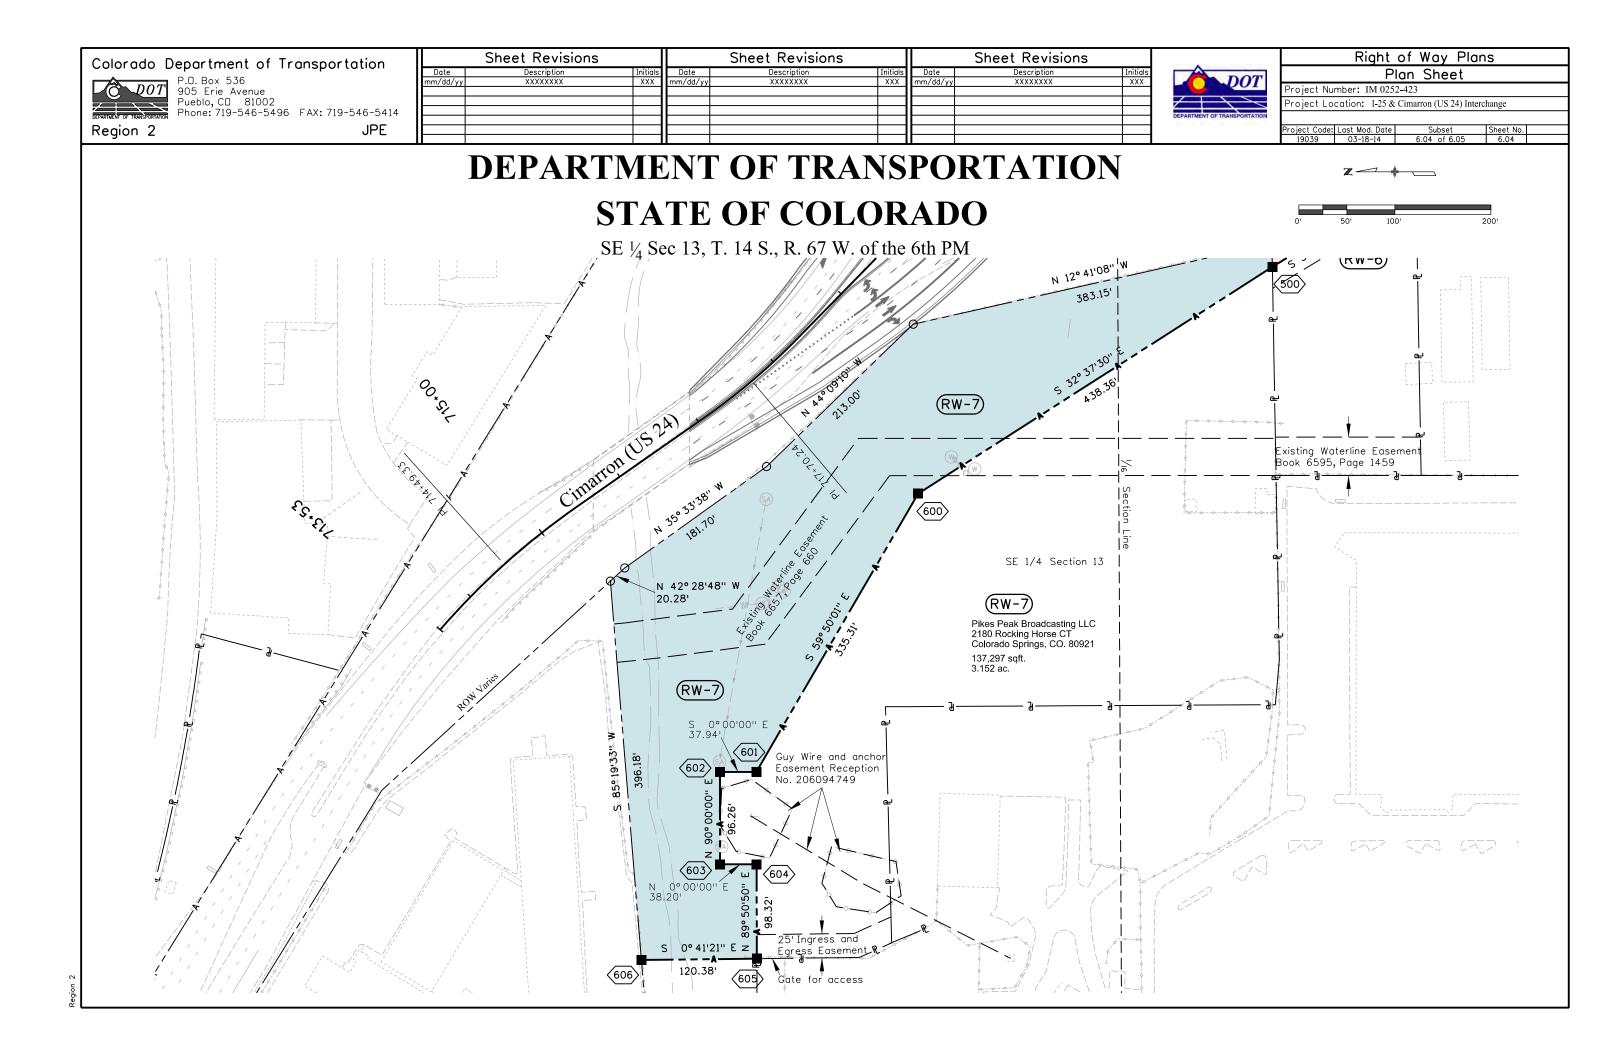
| | Right of Way Plans | | | | | | | |
|---------------|-----------------------------|-------------------------|-----------|--|--|--|--|--|
| | Plan Sheet | | | | | | | |
| Project Numb | Project Number: IM 0252-423 | | | | | | | |
| Project Locat | ion: I-25 & | Cimarron (US 24) Interd | change | | | | | |
| | | | | | | | | |
| Project Code: | Last Mod. Date | Subset | Sheet No. | | | | | |
| 19039 | 05-06-14 | 6.02 of 6.05 | 6.02 | | | | | |

DEPARTMENT OF TRANSPORTATION STATE OF COLORADO





Right of Way Plans Sheet Revisions Sheet Revisions Sheet Revisions Colorado Department of Transportation Plan Sheet P.O. Box 536 IM 0252-423 905 Erie Avenue Pueblo, CO 81002 Project Number: I-25 & Cimarron (US 24) Interchange Project Location: Phone: 719-546-5496 FAX: 719-546-5414 JPE Region 2 **DEPARTMENT OF TRANSPORTATION STATE OF COLORADO** SE ½ Sec 13, T. 14 S., R. 67 W. of the 6th PM C 1/4 Section 13 Bears; N 35°17'26" W, 2355.30 f S 89° 32'41" 10.04' N 89° 19'46" E (TE-4) 402 POB RW-6 & RW-7 C 1/4 Section 13 Bears; N 06° 00'46" E [/] 62.03" N 36°00'03" W, 1831.09 ft. S 88° 59'37" W 22.15' S 88° 59'08" W 24.48'— **Humane Society** 610 Abbot Ln. (RW-4A) Colorado Springs, CO. 80905 Humane Society of Pikes Peak (RW-6) N 12° 41'08" 630 Abbot Ln. (RW-4) (TE-4) Colorado Springs, CO. 80905 3,523 sqft. 0.081 ac 17,817sqft. 73,861 sqft. 5,838 sqft. 383.15 0.134 ac. Harry W. Hoth 660 Abbot Ln. Colorado Springs, CO. 80901 SE ¼ Section 13 (RW-7) (RW-7) Pikes Peak Broadcasting LLC Existing Waterline Easemen Book 6595, Page 1459 2180 Rocking Horse CT Colorado Springs, CO. 80921 137,297 saft.

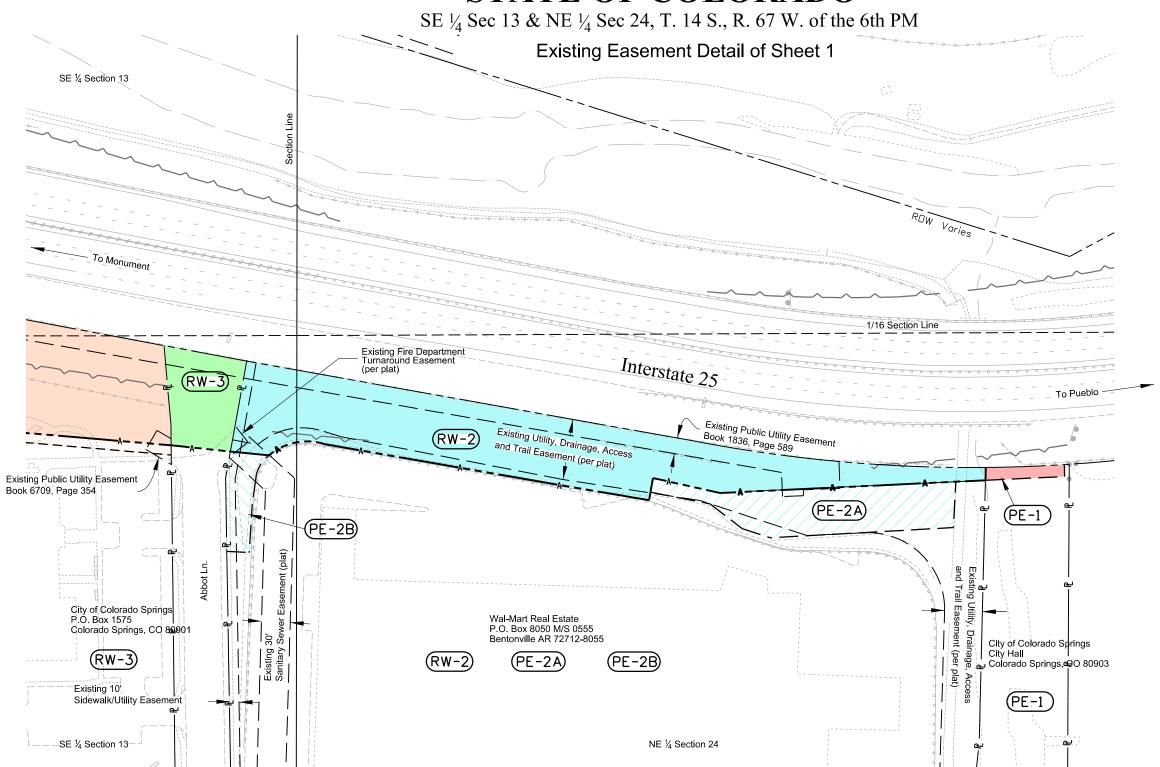

P.O. Box 536 905 Erie Avenue Pueblo, CO 81002 Phone: 719-546-5496

Region 2

FAX: 719-546-5414

JPE


Sheet Revisions

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| Right of Way Plans | | | | | | | | | |
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| Plan Sheet | | | | | | | | | |
| Project Number: IM 0252-423 | | | | | | | | | |
| Project Locat | ion: I-25 & | Cimarron (US 24) Int | erchange | | | | | | |
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| Project Code: | Last Mod. Date | Subset | Sheet No. | | | | | | |
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DEPARTMENT OF TRANSPORTATION STATE OF COLORADO



Region 2

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| | Sheet Revisions | | | Sheet Revisions | | | Sheet Revisions | |
|----------|-----------------|----------|----------|-----------------|----------|----------|-----------------|----------|
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Right of Way Plans

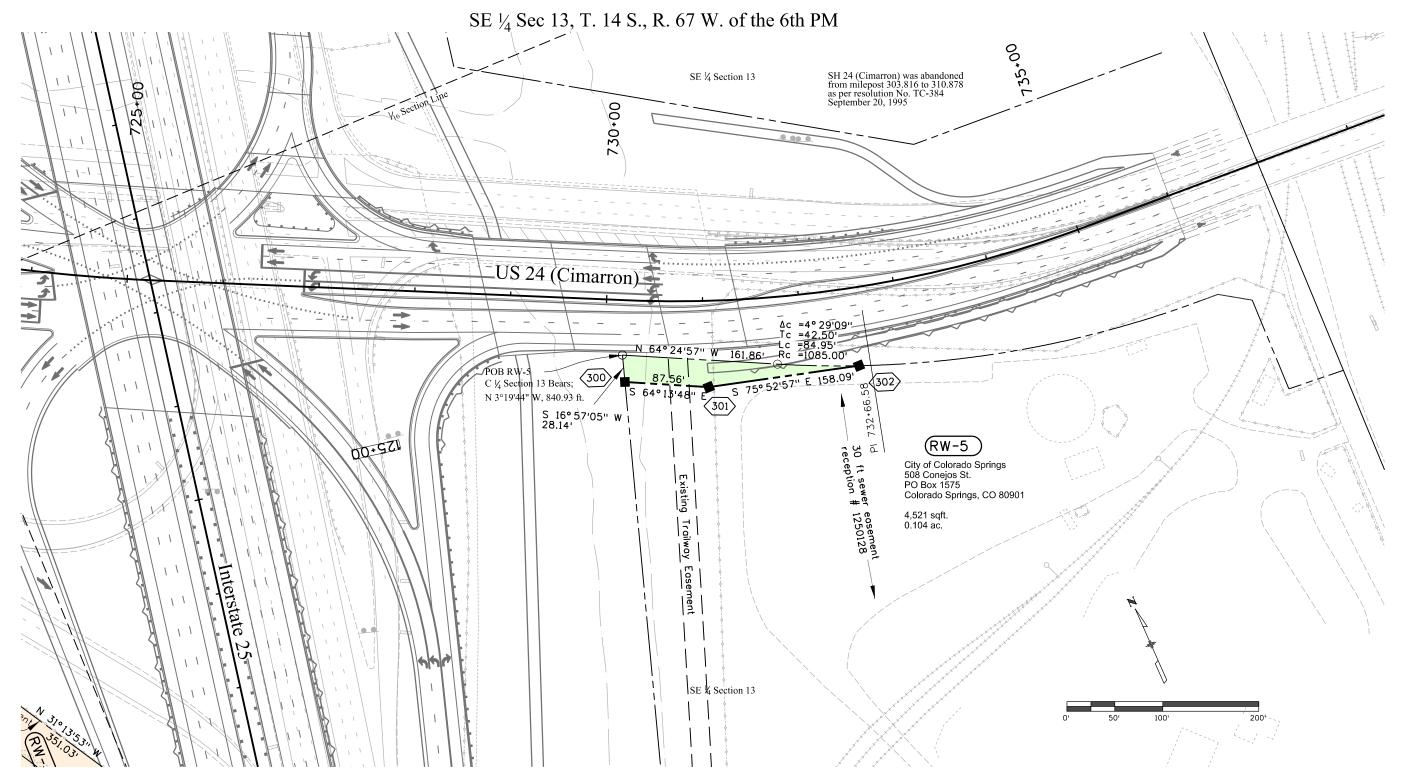Ownership Sheet

Project Number: IM 0252-423

Project Location: I-25 & Cimarron (US 24) Interchange

SE 1/4 Section 13 & NE 1/4 Section 24

Township 14 South, Range 67 West of the 6th Principal Meridian

