

BERRY CREEK
TYPICAL SECTION
STA. 3-01.00 TO STA 3-91.00

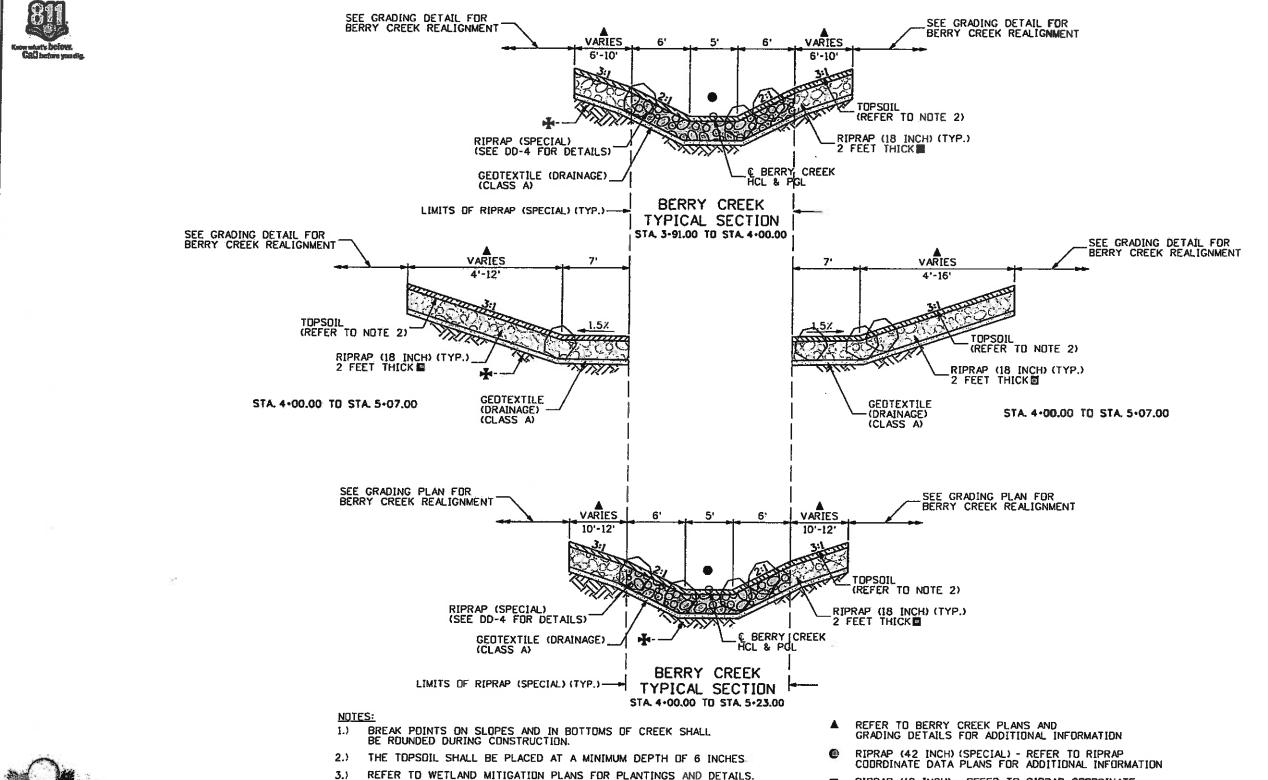
#### NOTES:

- 1.) BREAK POINTS ON SLOPES AND IN BOTTOMS OF CREEK SHALL BE ROUNDED DURING CONSTRUCTION.
- 2.) THE TOPSOIL SHALL BE PLACED AT A MINIMUM DEPTH OF 6 INCHES.
- 3.) REFER TO WETLAND MITIGATION PLANS FOR PLANTINGS AND DETAILS.
- 4.) ALL RIPRAP SHALL BE ANGULAR.

- REFER TO BERRY CREEK PLANS AND GRADING DETAILS FOR ADDITIONAL INFORMATION
- RIPRAP (42 INCH) (SPECIAL) REFER TO RIPRAP COURDINATE DATA PLANS FOR ADDITIONAL INFORMATION
- RIPRAP (18 INCH) REFER TO RIPRAP COURDINATE DATA PLANS FOR ADDITIONAL INFORMATION
- ALL OF CHANNEL SECTION SHALL BE COMPACTED TO 95% RELATIVE COMPACTION (TYP.) (AASHTO T180 METHOD A) (INCLUDED IN COST OF WORK)

FELSBURG HOLT & ULLEVIG
Print Date: 11/4/2009

Print Date: 11/4/2009			Sheet Revisions		Calacada	Description of Transportation	As Constructed	EDWARE	S INTER	CHANGE UPGRADI	Project No./Code
Drowing File Name: 06193BCTYP02.dgn		Date:	Comments	Init.	Color duo	Department of Transportation	-			CREEK	ES3 0702-297
Horiz, Scole: 1:10 Vert. Scale: As Noted					ODOT	/14 Grand Avenue, P.U. Box 296	No Revisions: 6-6-2011			SECTION	ES3 0/02-29/
Unit Information Unit Leader Initials	9				$\angle$	Eogle, CD 81631 Phone: 970-328-6385 FAX: 970-328-2368	Revised:	Designer:	· · · · · · · · · · · · · · · · · · ·	Structure	17303
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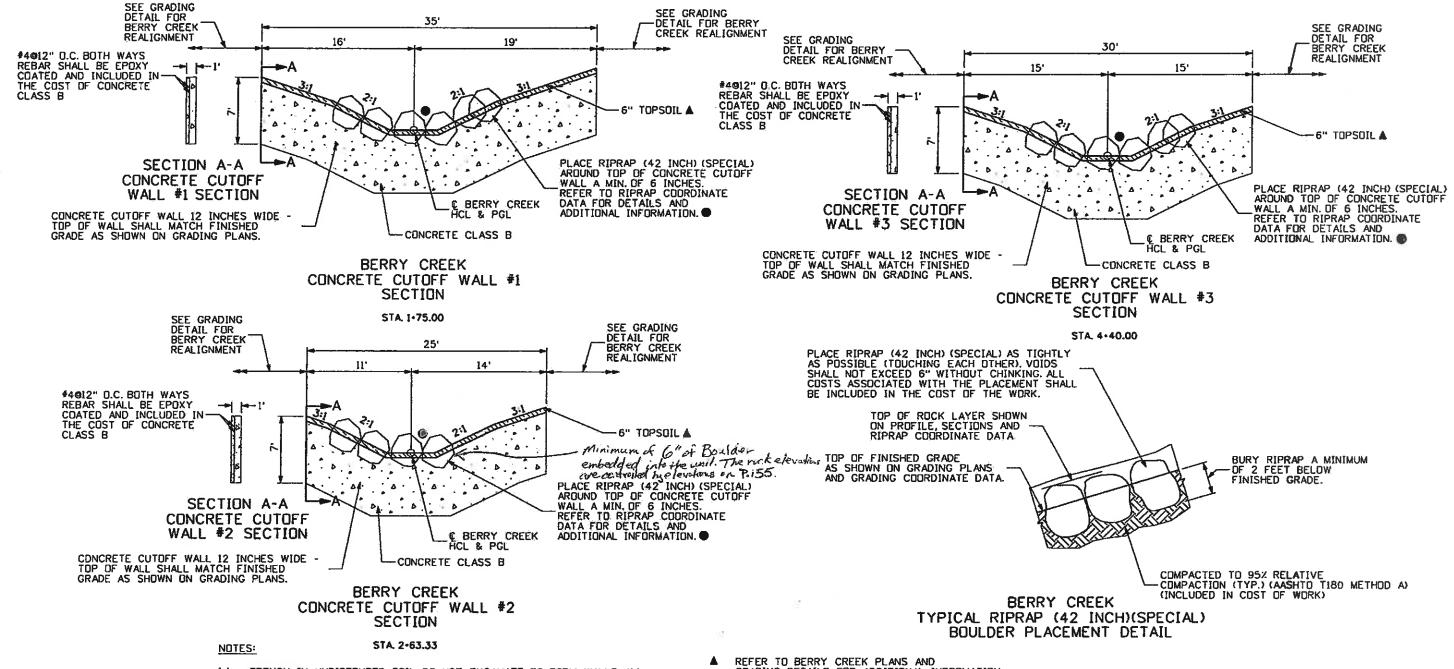


4.) ALL RIPRAP SHALL BE ANGULAR.

- RIPRAP (18 INCH) REFER TO RIPRAP COORDINATE DATA PLANS FOR ADDITIONAL INFORMATION
- ALL OF CHANNEL SECTION SHALL BE COMPACTED TO 95% RELATIVE COMPACTION (TYP.) (AASHTO T180 METHOD A) (INCLUDED IN COST OF WORK)

Print Date: 11/4/2009			Sheet Revisions		Colorado	Department of Transportation	As Constructed		CHANGE UPGRADE	Project No./Code
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Worfex State: 1:10 Vert. Scale: As Noted Unit Information Unit Leader Initials					© DOT	Fools CD 91631			SECTION Structure	
					Committee to more than	Phone: 970-328-6385 FAX: 970-328-2368	Revised:		Numbers	17303
	0				Region 3	MLM	Void:		Subset Sheets: CT-3 of 4	Sheet Number





- TRENCH IN UNDISTRUBED SOIL DO NOT EXCAVATE TO FORM WALLS ALL COSTS ASSOCIATED WITH THE CONCRETE CUTOFF WALL SHALL BE INCLUDED IN THE COST OF CONCRETE CLASS B (CY).
- 2.) POUR AND VIBRATE CONCRETE INTO THE TRENCH.

- GRADING DETAILS FOR ADDITIONAL INFORMATION
- RIPRAP (42 INCH) (SPECIAL) REFER TO RIPRAP COORDINATE DATA PLANS FOR ADDITIONAL INFORMATION
- RIPRAP (18 INCH) REFER TO RIPRAP COURDINATE DATA PLANS FOR ADDITIONAL INFORMATION



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Unit Information	Unit Leader Initials				
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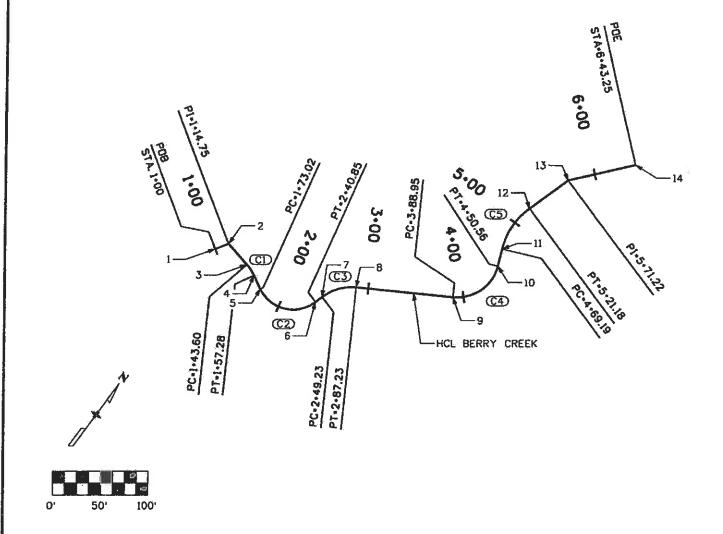
Colorado Department of Transportation

DESCRIPTION OF PURSONNER	714 Grand Avenue, P.O. Eagle, CO 81631 Phone: 970-328-6385 F
Region 3	

Box 298 FAX: 970-328-2368 MLM

	As Constructed	EDWARDS	INTER( BERRY		UPGRADE	Project No./Code
	No Revisions: 6-6-2011	<u> </u>	YPICAL			ES3 0702-297
	Revised:	Designer:		Structure		17303
i		Detailer:	RSA	Numbers		3,1,7==
	Void:	Sheet Subset:	DRAINAGE	Subset She	eels: CT-4 of 4	Sheet Number 45





# BERRY CREEK COORDINATE DATA

POINT	STA	TION	BEARING	NORTHING	EASTING
1	POB	1-00		63662.44	93760,47
			N 33°15'45.10" E		
2	ΡÏ	1-14.75		63674.77	93768.56
			S 77° 00'29.78" E		
3	PC	1+43.60		63668.28	93796.67
			ල		
4	PΤ	1+57.28		63663.44	93809 42
			S 61° 20'04.48" E		
5	PC	1+73.02		63655.88	93823.23
			C2		
6	PT	2+40.85		63678.50	93877.91
		·	N 16° 23'55.55" E		
7	PC	2+49.23		63686.54	93880.28
			C3		
8	PT	2+87.23		63715.70	93903.20
i			N 59° 56'34.58" E		
9	PC	3+88.95		63766.65	93991.25
			<b>C4</b> )		ļ
10	PT	4+50.56		63820.07	94009.54
			N 22° 08'22.47" W		
11	PC	4 • 69 19		63837.33	94002.52
			<b>C5</b> )	<u> </u>	
12	PT	5+21.18		63888.25	94000.49
			N 17° 34'51.72" E		
13	PI	5+71.22		63935.95	94015-61
			N 41°10'49.40" E		
14	POE	5+43.25		63990.17	94063.04

### BERRY CREEK CURVE DATA

CURVE	DELTA	RADIUS	LENGTH	TANGENT
ŒD	15° 40'25.30" RT.	50.00'	13.68'	6.88'
<b>C2</b>	102°15'59.97" LT.	38.00	67.83'	47.15'
<b>C3</b>	43° 32'39.03" RT.	50.00'	38.00 <sup>-</sup>	19.97'
<b>C</b> 4	85° 04'57.06" LT.	43.00'	61.60'	37.43'
<b>C5</b> )	39° 43'14.20" RT.	75.001	51.99'	27.09





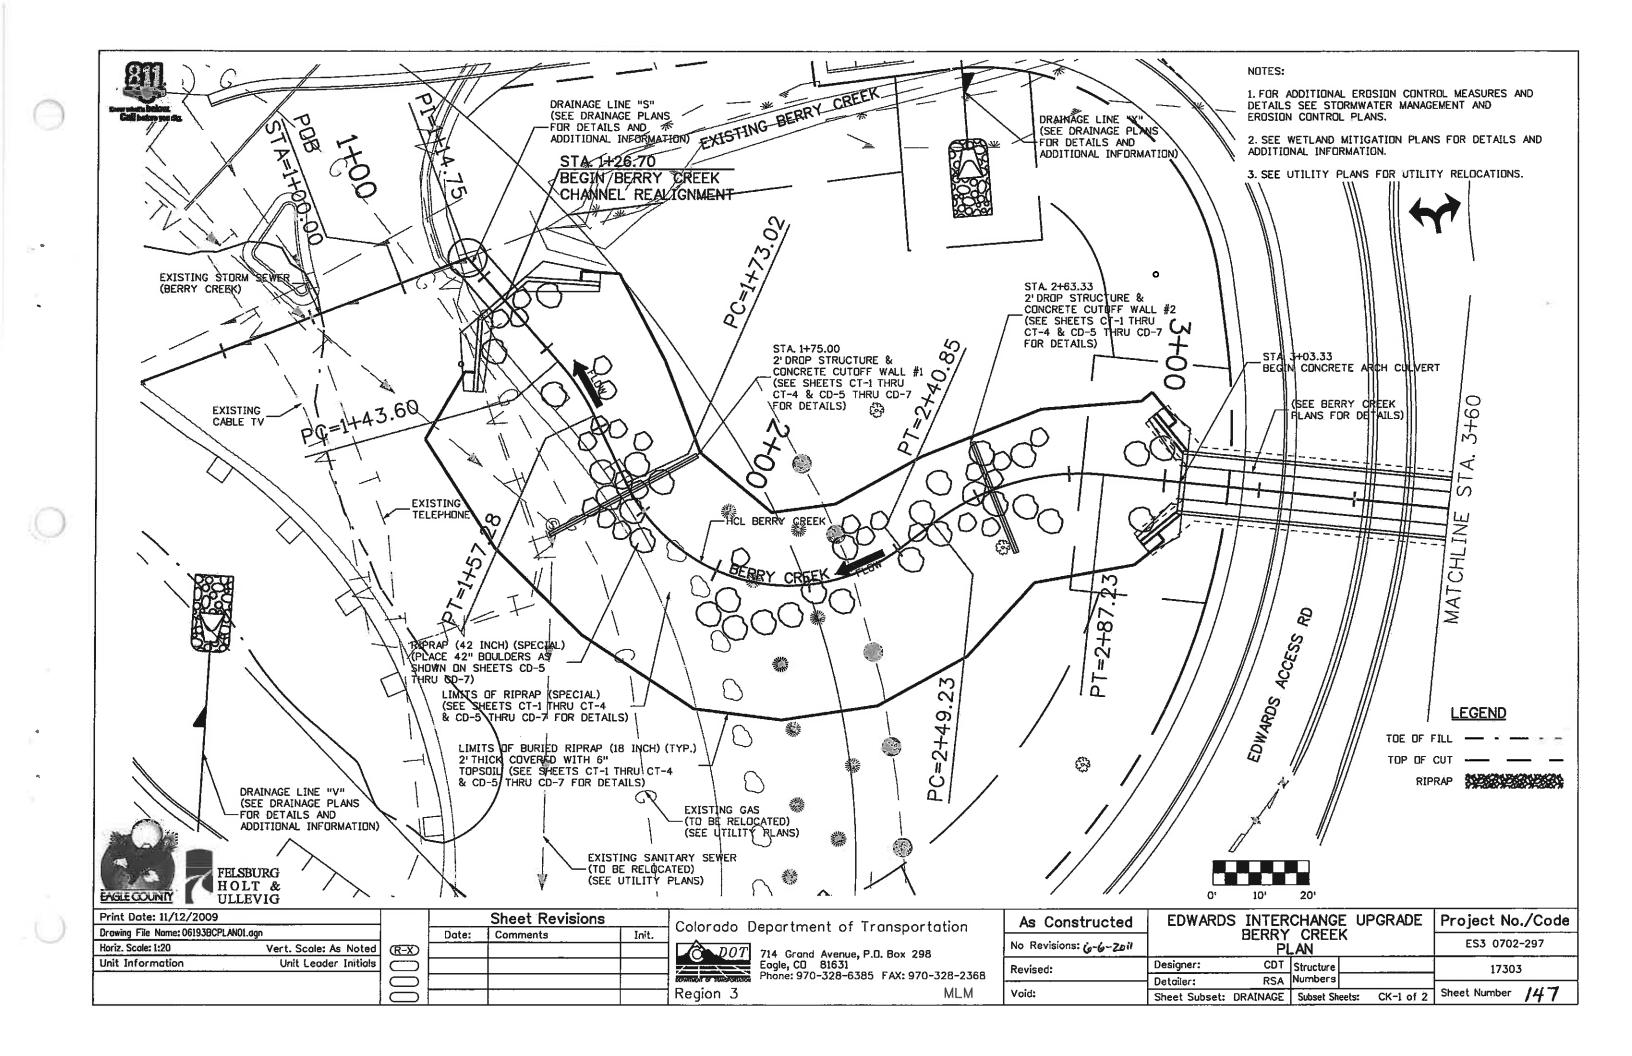
Drawing File Name: 06193BCGED01.dgn  Horiz, Scale: 1:100 Vert. Scale: As Noted  Unit Information Unit Leader Initials	Print Date: 11/4/2009	
	Drawing File Name: 061938CGED01.dgn	
Unit Information Unit Leader Initials	Horiz. Scale: 1:100	Vert. Scale: As Noted
	Unit Information	Unit Leader Initials
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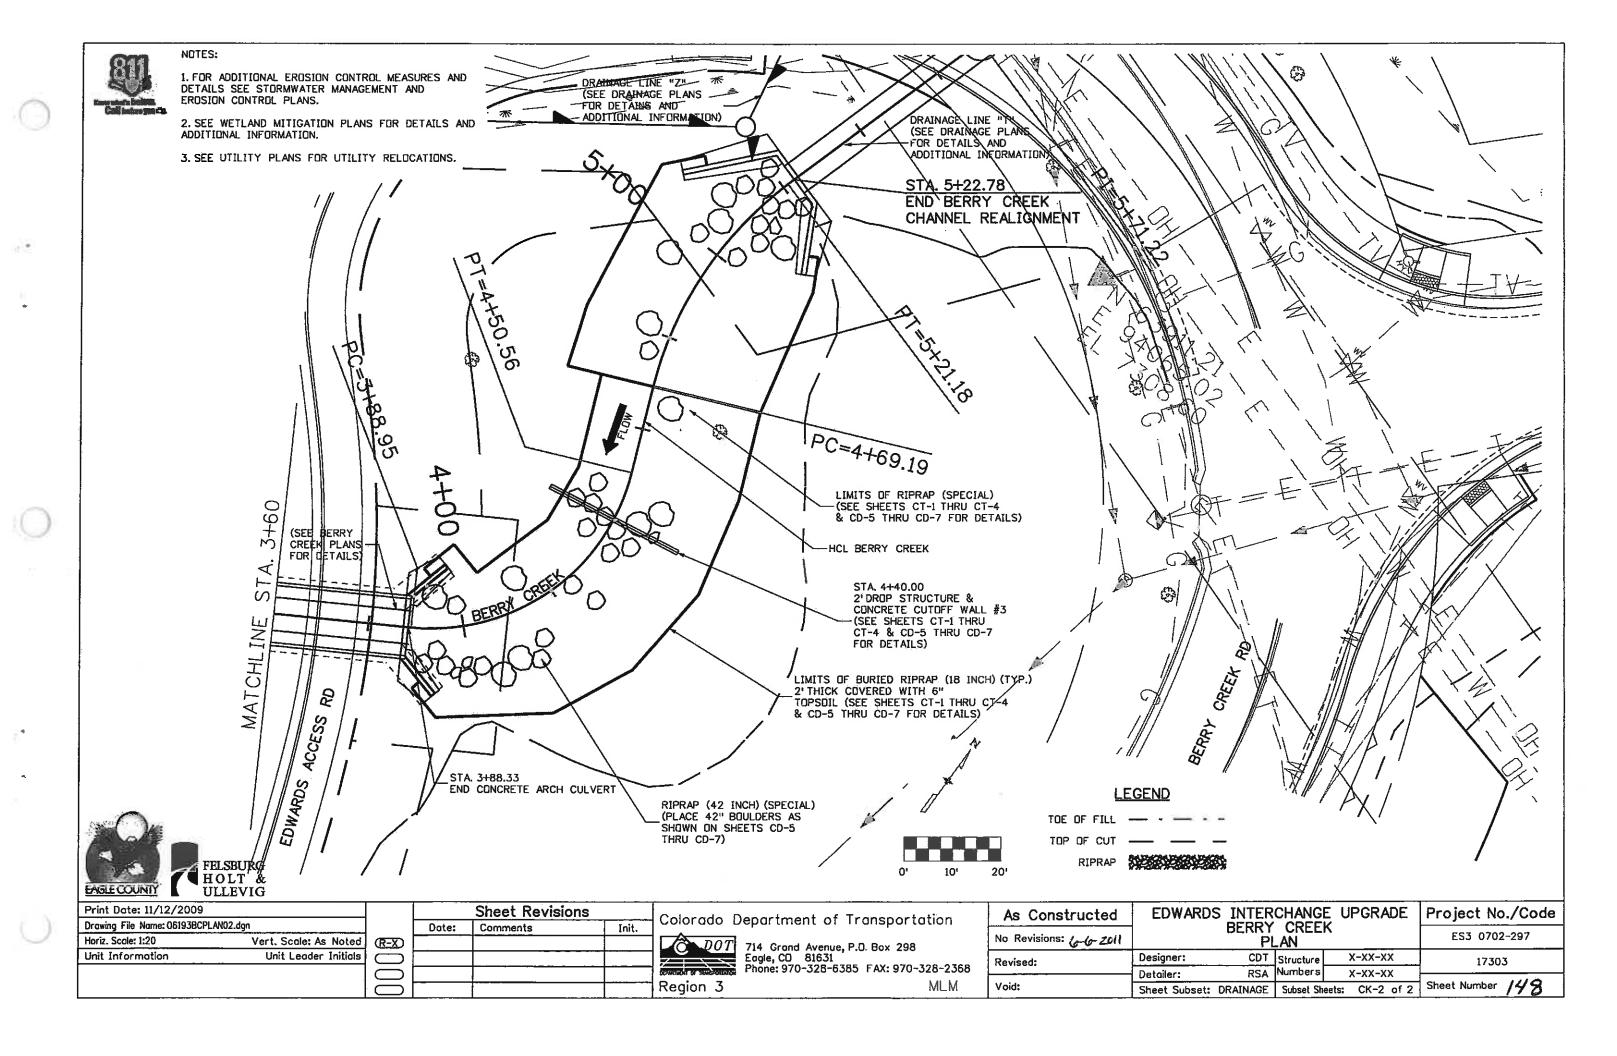
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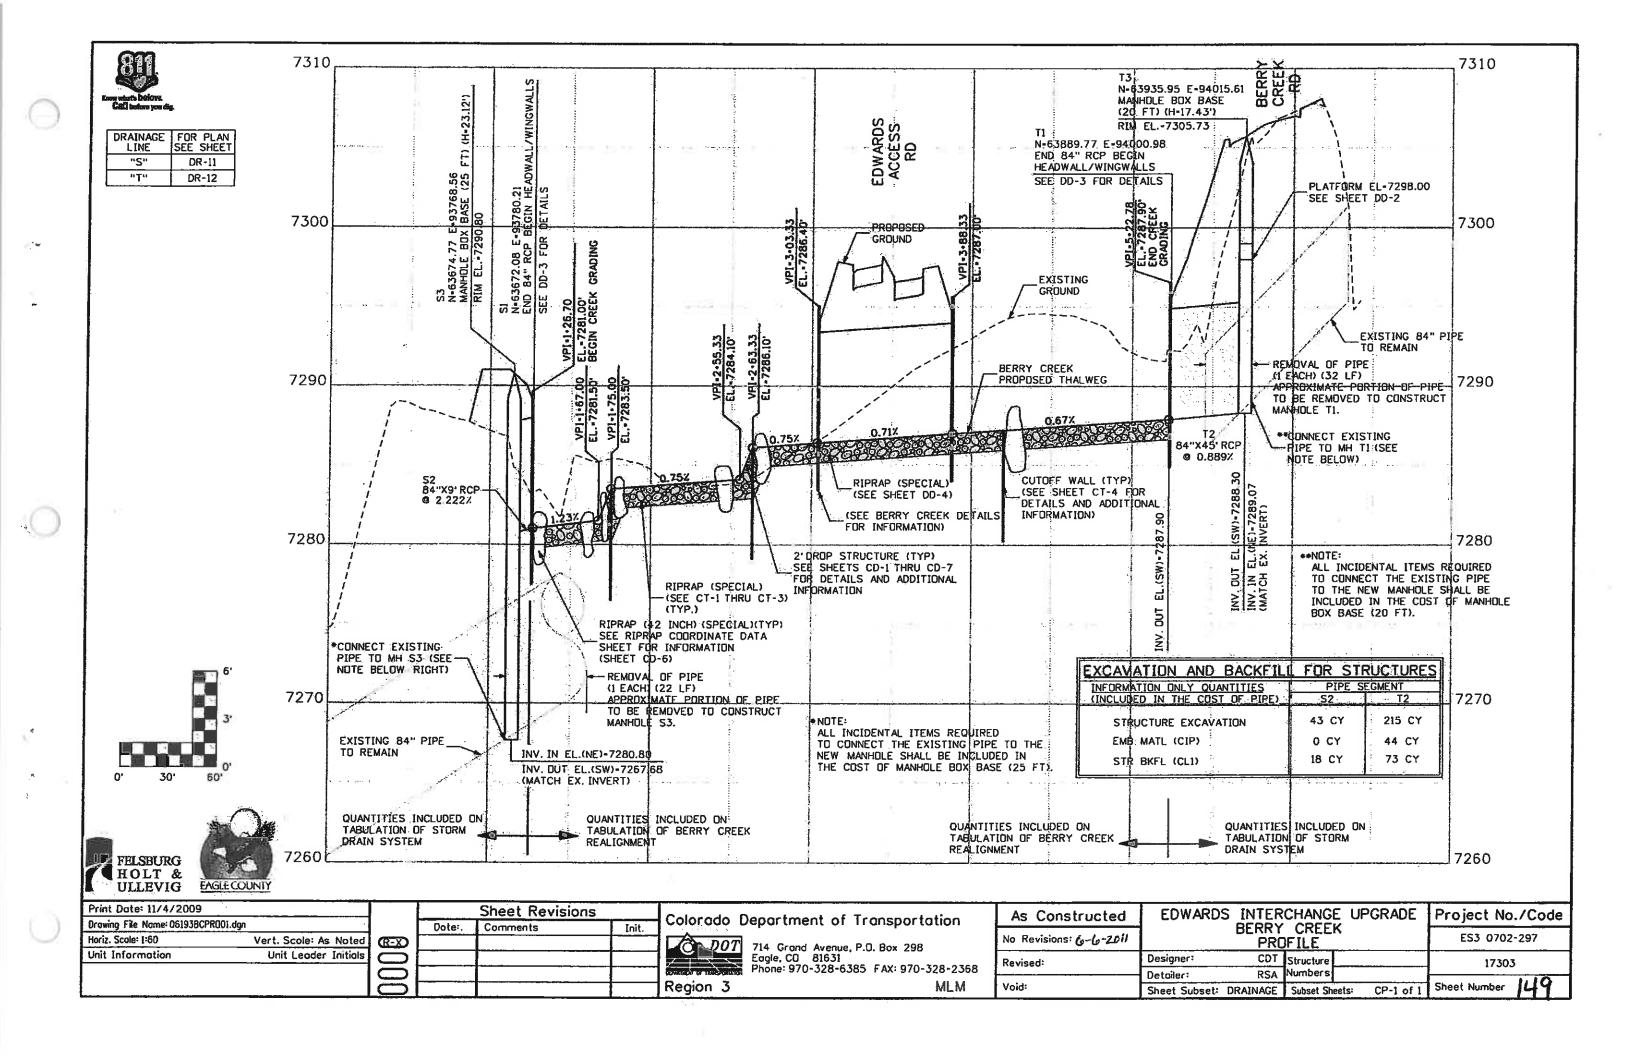
Colorado Department of Transportation

	© DOT	714 Grand Avenue, P.O. Box 298 Eagle, CO 81631
1	DEPARTMENT OF TRANSPORTATION	Phone: 970-328-6385 FAX: 970-328-2368
	Region 3	MLM

As Constructed				PGRADE	Project No.	./Code
No Revisions: 6-6-2011			CREEK C LAYDUT		ES3 0702	297
Revised:	Designer:		Structure		17303	
	Detailer:	RSA	Numbers			1.17
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GRADING COORDINATE DATA

GRADING COURDINATE DATA						
POINT	NORTHING	EASTING	ELEVATION	DESCRIPTION		
. 1	63643.05	93722.39	7289.00	(FINISHED GRADE)		
2	63656.78	93726.09	7291.00	(FINISHED GRADE)		
3	63657.97	93723.51	7292.00	(FINISHED GRADE)		
5	63652.43	93742.77	7288.00	(FINISHED GRADE)		
6	63661.53 63676.85	93741.55 93745.80	7291.00	(FINISHED GRACE)		
7	63657.87	93754.10	7291.00	(FINISHED GRADE)		
8	63659.44	93769.30	7291.00	(FINISHED GRADE)		
9	63658.44	93774.53	7290.00	(FIN1SHED GRADE)		
10	63657.36	93783,21	7289.00	(FINISHED GRADE.)		
12	63640.83 63645.31	93756.89	7288.00	(FINISHED GRADE)		
13	63647.66	93764.69	7291.00 7291.50	(FINISHED GRADE)		
14	63649.78	93773.23	7291.00	(FINISHED GRADE)		
15	63651.11	93776.25	7290.00	(FINISHED GRADE)		
16	63651.85	93781.24	7289.00	(FINISHED GRADE)		
17	63654.54	93784.98	7288.00	(FINISHED GRADE)		
18	63655.47	93785.38	7286.00	(FINISHED GRADE)		
20	63634.15 63637.55	93776.59	7291.00	(FINISHED GRADE)		
21	63640.60	93779.39	7291.00	(F1N1SHED GRADE)		
22	63647.14	93785.65	7288.00	(FINISHED GRADE)		
23	63653.01	93786.34	7287.00	(FINISHED GRADE)		
24	63654.32	93792.72	7285.00	(FINISHED GRADE)		
25	63620.57	93777.00	7288.00	(FINISHED GRADE)		
26 27	63628.77 63632.75	93780.73 93783,24	7291.00 7291.50	(FINISHED GRADE)		
ŽB	63636.48	93785.35	7291.00	(FINISHED GRADE)		
29	63644.63	93789.29	7288.00	(FINISHED GRADE)		
30	63652.04	93797.50	7285.00	(FINISHEO GRADE)		
31	63662.49	93802,24	7282.00	(FINISHED GRADE)		
32	63610.11	93792.88	7287.00	(FINISHED GRADE)		
33 34	63621.73 63626.47	93796.30 93797.73	7291.08	(FINISHED GRADE)		
35	63631.54	93799.13	7291.50 7291.00	(FINISHED GRADE)		
36	63645.80	93810.86	7285.00	(FINISHED GRADE)		
37	63652.19	93814.35	7284.00	(FINISHED GRADE)		
38	63655.70	93816.27	7282,00	(FINISHED GRADE)		
39 40	63655.61	93818.51	7282.00	(FINISHED GRADE)		
41	63653.69   63601.91	93822.02	7283.00 7287.00	(FINISHED GRADE)		
42	63613.74	93828.84	7291.00	(FINISHED GRADE)		
43_	63618.97	93829.79	7291.50	(FINISHED GRADE)		
44	63623.60	93830.70	7291.00	(FINISHED GRADE)		
45	63632.49 (	93832.35	7288.00	(FINISHED GRADE)		
45	63637.36	93833.32	7287.00	(FINISHED GRADE)		
48	63643.25 63648.60	93833.72	7286.00 7284.00	(FINISHED GRADE)		
49	63601.30	93833.77	7287.00	(FINISHED GRADE)		
50	63584,05	93850.32	7287.00	(FIN)SHED GRADE)		
51	63569.26	93841.75	7287.00	(FINISHED GRADE)		
52	63586.53	93879.95	7288.00	(FINISHED GRADE)		
53 54	63604.31   63607.20	93856.87 93852.95	7288.00	(FINISHED GRADE)		
55	63613.19	93852.66	7289.00 7291.00	(FINISHED GRADE)		
56	63618.31	93852.51	7291.50	(FINISHED GRADE)		
57	63623.20	93852.40	7291.00	(FINISHED GRADE)		
58	63632.23	93852.68	7288.00	(FINISHED GRADE)		
59	63638.25	93852.75	7287.00	(FIN1SHED GRADE)		
60	63645,27	93851.63 93851.21	7286.00	(FINISHED GRADE)		
62	63649.29 63627.37	93914.76	7284.00 7289.00	(FINISHED GRADE) (FINISHED GRADE)		
63	63631.82	93928.62	7292.00	(FINISHED GRADE)		
64	63640.33	93919.88	7290.00	(FINISHED GRADE)		
65	63636.71	93902.16	7290.00	(FINISHED GRADE)		
66	63626.44	93896.39	7289.68	(FINISHED GRADE)		
67	63630.53	93891.98	7291.00	(FINISHED GRADE)		
69	63633.89 63636.55	93887.87	7291.50 7291.00	(FINISHED GRADE)		
70	63642.85	93877.19	7288.00	(FINISHED GRADE)		
71	63648.07	93872.98	7287.00	(FINISHED GRADE)		
72	63653.87	93869.09	7286.00	(FINISHED GRADE)		
73	63657,21	93866.85	7284.00	(FINISHED GRADE)		
74 75	63638.33 63662.27	93932.01	7293.00	(FINISHED GRADE)		
<u> </u>	UJUUE - E/	10 10 LO LO	7293.00	(FINISHED GRADE)		

# GRADING COORDINATE DATA (CONTINUED)

POINT	NORTHING	EASTING	ELEVATION	DESCRIPTION
76	63692.39	93918.60	7291.00	(FINISHED GRADE)
77	63693.08	93916.71	7291.00	(F1N1SHED GRADE)
78 79	63691.64	93915.78	7291.00	(FINISHED GRADE)
80	63657.90 63659.81	93910.91	7291.00 7291.50	(FINISHED GRADE) (FINISHED GRADE)
BI	63661.54	93901.59	7291.00	(FINISHED GRADE)
.82	63664.21	93892.97	7288.00	(FINISHED GRADE)
83	63666.45	93887.27	7287.00	(FINISHED GRADE)
84	63669.51	93881.48	7286.00	(FINISHED GRADE)
85	63671.16 63678.90	93877.83	7284.00 7284.00	(FINISHED GRADE)
87	63700.34	93921.18	7292.00	(FINISHED GRADE)
88	63708.58	93918.12	7291.00	(FIN)SHED GRADE)
89	63698.52	93912.92	7291.50	(FINISHED GRADE)
90	63685.88	93911.14	7291.50	(FINISHED GRADE)
91	63704.00 63695.48	93910.95 93905.69	7291.00 7291.00	(FINISHED GRADE)
93	63689.36	93905.97	7291.00	(FINISHED GRADE) (FINISHEO GRADE)
94	63708.39	93902.91	7288.00	(FINISHED GRADE)
95	63695.14	93896.57	7288.00	(FINISHED GRADE)
96	63685.28	93897.22	7288.00	(FINISHED GRADE)
97	63709.16	93900.61	7287.00	(FINISHED GRADE)
99	63697,02 63689,00	93889.73 93889.97	7287,00 7287,00	(FINISHED GRADE)
100	63697.66	93888.01	7286.00	(FINISHED GRADE)
101	63694.37	93886.12	7285.00	(FINISHED GRADE)
102	63690.57	93886.30	7285.00	(FINISHED GRADE)
103	63690.66	93760.19	7292.00	(FINISHED GRADE)
104	63688.66 63683.67	93769.09	7291.00 7290.00	(FINISHED GRADE) (FINISHED GRADE)
106	63673.01	93776.47	7290.00	(FINISHED GRADE)
107	63706.77	93778.22	7291.00	(FINISHED GRADE)
10B	63700.04	93785.52	7290.00	(FINISHED GRADE)
109	63693.89	93791.54	7289.00	(FINISHED GRADE)
110	63683.71 63685.09	93788.90 93791.11	7289.00 7288.00	(FINISHED GRADE)
112	63684.21	93791.27	7286.00	(FINISHED GRADE)
113	63686.60	93794.04	7287.00	(FINISHED GRADE)
114	63725.64	93797.37	7291.00	(FINISHED GRADE)
115	63717.92	93803.53	7290.00	(FINISHED GRADE)
116 117	63698.43 63684.86	93801.62 93810.42	7289.00 7288.00	(FINISHED GRADE) (FINISHED GRADE)
118	63669.84	93804.87	7282.00	(FINISHED GRADE)
119	63736.39	93818.66	7291.00	(FINISHED GRADE)
120	63727.31	93822,79	7290.00	(FINISHED GRADE)
121	63694.29	93821.83	7289.00	(FINISHED GRADE)
122 123	63676.36 63670.08	93826.54 93824.22	7288.00 7286.00	(FINISHED GRADE)
	63661.85	93819.63	7282.00	(FINISHED GRADE)
125	63660.00	93820.91	7282.00	(FINISHED GRADE)
126	63658.08	93824.42	7283.00	(FINISHED GRADE)
	63744.02	93832.93	7291.00	(FINISHED GRADE)
	63738.27	93841.25	7290.00	(FINISHED GRADE)
	63693.92 63669.74	93840.66 93835.58	7289.00 7288.00	(FINISHED GRADE)
	63666.28	93836.72	7287.00	(FINISHED GRADE)
132	63659.28	93835.04	7286.00	(FINISHED GRAGE)
	63655.36	93834.22	7284.00	(FINISHED GRADE)
	63669.10 63666.16	93846.80	7288.00	(FINISHED GRADE) (FINISHED GRADE)
	63659.27	93848.52	7287.00 7286.00	(FINISHED GRADE)
	63655.25	93849.37	7284.00	(FINISHED GRADE)
138	63671.96	93853.64	7288.00	(FINISHED GRADE)
	63669.36	93855.13	7287,00	(FINISHED GRADE)
	63663.66	93859.16	7286.00	(FINISHED GRADE)
	63660.17 63677.00	93861.13	7284.00 7287.00	(FINISHED GRADE) (FINISHED GRADE)
	63673.69	93868.69	7286.00	(FINISHED GRADE)
144	63671.79	93872.21	7284.00	(FINISHED GRADE)
45	63689.97	93864.47	7288.00	(FINISHED GRADE)
	63682.76	93870.32	7287.00	(FINISHED GRADE)
	63680.31 63700.26	93875.84	7284.00	(FINISHED GRADE)
	63696.50	93871.47	7289.00 7288.00	(FINISHED GRADE) (FINISHED GRADE)
	63695.34	93874.63	7287.00	(FINISHED GRADE)
	63693.87	93878.36	7285.00	(FINISHED GRADE)



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Drawing File Name: 06193BCDET01.dgm			Date:	Comments	Init.
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Unit Information	Unit Leader Initials				1
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Colorado	Department of	) f	Transportation
- A	500		

		714 Grand Avenue, P.( Eagle, CD 81631	
1	Company of the Company	Phone: 970-328-6385	FAX: 970-328-236
	Region 3		MLM

	As Constructed	EDWARDS INTERC	Project No./Code	
	No Revisions 6-6-2011	GRADING COOF		ES3 0702-297
i	Revised:	Designer: CDT	17303	
	Void:		Numbers	Sheet Number 150
		Sheet Subset: DRAINAGE	Subset Sheets: CD-1 of 8	Sheet Marriser 190



### GRADING COORDINATE DATA (CONTINUED)

GIZAD	TING COL	TROTINATE	DATA (CI	JIN I TINOED)
POINT	NORTHING	EASTING	ELEVATION	DESCRIPTION
152	63703.77		7289.00	(FINISHED GRADE)
153	63696.68	93881.69	7285.00	(FINISHED GRADE)
154	63700.32	93883.77	7286.00	(FINISHED GRADE)
155	63717.89	93892.15	7289.00	(FINISHED GRADE)
156	63714.64		7287.00	(FINISHED GRADE)
157	63751.76		7291.00	(FINISHED GRADE)
158	63755.21	93860.97	7291.00	(FINISHED GRADE)
159	63748.79	93879.57	7291.00	(FINISHED GRADE)
160	63731.56	93901.48	7291.00	(FINISHED GRADE)
161	63733.82	93903.36	7292.00	(FINISHED GRADE)
162	63731.43	93905.56	7291.00	(FINISHED GRADE)
163	63742.50	93860.92	7290.00	(FINISHED GRADE)
164	63739.52	93876.70	7290.00	(FINISHED GRADE)
165	63732.94	93888 42	7290.00	(FINISHED GRADE)
166	63728.71	93898.22	7290.00	(FINISHED GRADE)
167		93989.63	7292.00	(FINISHED GRADE)
168	63778.99	93989.51	7291.00	(FINISHED GRADE)
169		93993.03	7291.00	(FINISHED GRADE)
170	63781.61	93996.34	7290.00	(FINISHED GRADE)
171		93999.03	7288.00	(FINISHED GRADE)
172	63807.28	93973.60	7292.00	(FINISHED GRADE)
173	63/44.0/	93996.01	7291.00	(FINISHED GRADE)
174	63796.20	94003.84	7290.00	(FINISHED GRADE)
175 176	63794.24		7288.00	(FINISHED GRADE)
177	63811.94		7291.00	(FINISHED GRADE)
178	63815.39	94003.08 94006.88	7290.00	(FINISHED GRADE)
179	63824.85	93962.74	7288.00	(FINISHED GRADE)
180		93989.88	7292,00 7291.00	(FINISHED GRADE)
181		93997.07	7290.00	(FINISHED GRADE)
182	63030.71	94000.85	7288.00	(FINISHED GRADE)
	63840.61		7292.00	(FINISHED GRADE)
		93983.73	7291.00	(FINISHED GRADE)
185			7290.00	(FINISHED GRADE)
186	63853.52		7288.00	(FINISHED GRADE)
187			7292.00	(FINISHED GRADE)
188	63864.56		7291.00	(FINISHED GRADE)
189			7288,00	(FINISHED GRADE)
190	63874.27	93984.71	7292.00	(FINISHED GRADE)
	63877.60	93980.76	7294.00	(FINISHED GRADE)
192	63B75.30		7292.00	(FINISHED GRADE)
193	63874.32		7291.00	(FINISHED GRADE)
194		93985.59	7293.00	(FINISHED GRADE)
	63882.87	93985.58	7295.00	(FINISHED GRADE)
			1 As 1 8 6	

## GRADING COURDINATE DATA (EDWARDS ACCESS RD.)

POINT	NORTHING	EASTING	ELEVATION	DESCRIPTION
500	63758.27	93821,47	7297.00	(FINISHED GRADE)
501	63771.84	93881.68	7298.00	(FINISHED GRADE)
502	_63756.89	93903.24	7298.00	(FINISHED GRADE)
503	63745.67	93916.91	7298.00	(FINISHED GRADE)
504	63741.82	93919.96	7298.00	(FINISHED GRADE)
505	63689.96	93938.15	7297.00	(FINISHED GRADE)
506	63662.67	93940.11	7296.00	(FINISHED GRADE)
507	63630.64	93937.96	7295.00	(FINISHED GRADE)
508	63615.91	93932.22	7294.00	(FINISHED GRADE)
509	63596.34	93921.85	7293.00	(FINISHED GRADE)
510	63576.58	93901.80	7292.00	(F(NISHED GRADE)
511	63563.66	93872.78	7291.00	(FINISHED GRADE)

## GRADING COORDINATE DATA (CONTINUED)

POINT	NORTHING.	EASTING	ELEVATION	DESCRIPTION
196	63884.43	93988.38	7292.00	(FINISHED GRADE)
197	63887.24	93989.60	7296.00	(FINISHED GRADE)
198	63891.65	93998.36	7296.00	(FINISHED GRADE)
199	63759.44	93995.55	7294.00	(FINISHED GRADE)
200	63757.88	94003.37	7292,00	(FINISHED GRADE)
201	63755.72	94006.38	7293.00	(FINISHED GRADE)
202	63752.68	94004.13	7293.00	(FINISHEO GRADE)
203	63747.54	94004.43	7293.00	(FINISHED GRADE)
204	63734.74	94009.51	7293.00	(FINISHED GRADE)
205	63760.67	94016.67	7294.00	(FINISHED GRADE)
206	63768.61	94012,10	7291.00	(FINISHED GRADE)
207	63771.60	94009.56	7290.00	(FINISHED GRADE)
208	63774.45	.94006.72	7288.00	(FINISHED GRADE)
209	63764.91	94039.35	7298.00	(FINISHED GRADE)
210	63784.57	94025.09	7291.00	(FINISHED GRADE)
211	63790.43	94018.95	7290.00	(FINISHED GRADE)
				(FINISHED GRADE)
212	63791.20	94015.02	7288.00	
213	63772.75	94055.92	7302.00	(FINISHED GRADE)
214	63792.28	94060.44	7302.00	(FINISHED GRADE)
215	63805.87	94061.03	7302.00	(FINISHED GRADE)
216	63818.54	94053.64	7300.00	(FINISHED GRADE)
217	63816.37	94026.52	7291.00	(FINISHED GRADE)
218	63815.72	94019.06	7290.00	(FINISHED GRADE)
219	63814.55	94015.23	7288.00	(FINISHED GRADE)
220	63839.17	94040.53	7298.00	(FINISHED GRADE)
221	63849.90	94032.65	7297.00	(FINISHED GRADE)
222	63841.82	94016.53	7291.00	(FINISHED GRADE)
223	63838.94	94009.89	7290.00	(FINISHED GRADE)
224	63837.28	94006,25	7288.00	(FINISHED GRADE)
225	63861.34	94026.43	7296.00	(FINISHEO GRADE)
226	63857.73	94011.77	7291.00	(FINISHED GRADE)
227	63856.08	94004.83	7290.00	(FINISHED GRADE)
228	63854.40	94001.06	7288.00	(FINISHED GRADE)
229	63874.25	94023.46	7296.00	(FINISHED GRADE)
230	63879.48	94017.44	7295.00	(FINISHED GRADE)
231	<u>63874.68 </u>	94014.06	7293.00	(FINISHED GRADE)
232	63871.20	94009.63	7291.00	(FINISHED GRADE)
233	63868.48	94004.04	7290.00	(FINISHED GRADE)
234	63867.84	94000.02	7288.00	(FINISHED GRADE)
235	63891.50	94019.05	7295.00	(FINISHED GRADE)
236	63889.71	94013.99	7294.00	(FINISHED GRADE)
237	63883.98	94010.09	7294.00	(FINISHED GRADE)
238	63889.01	94006.69	7294.00	(FINISHED GRADE)
239	63890.37	94002.41	7295.00	(FINISHED GRADE)
600	63793.94	93960.69	7298.00	(FINISHED GRADE)
601	63814.90	93947.70	7298.00	(FINISHED GRADE)
602	63842.05	93939.36	7299.00	(FINISHED GRADE)
603	63867.12	93947.77	7300.00	(FINISHED GRADE)
604	63887.09	93960.33	7301.00	(FINISHED GRADE)
605	63899.33	93972.00	7302.00	(FINISHED GRADE)
606	63907.30	93983.47	7303.00	(FINISHED GRADE)
607	63916.34	93994.24	7304.00	(FINISHED GRADE)
608	63921.94	94007.95	7305.00	(FINISHED GRADE)
609	63923.83	94017.48	7306.00	(FINISHED GRADE)
610	63924.17	94029.52	7307.00	(FINISHED GRADE)
611	63922.89	94042.34	7308.00	(FINISHED GRADE)
612	63919.83	94055.29	7309.00	(FINISHED GRADE)
613	63914.89	94067.99	7310.00	(FINISHED GRADE)
614	63907.56	94080.93	7311.00	(FINISHED GRADE)
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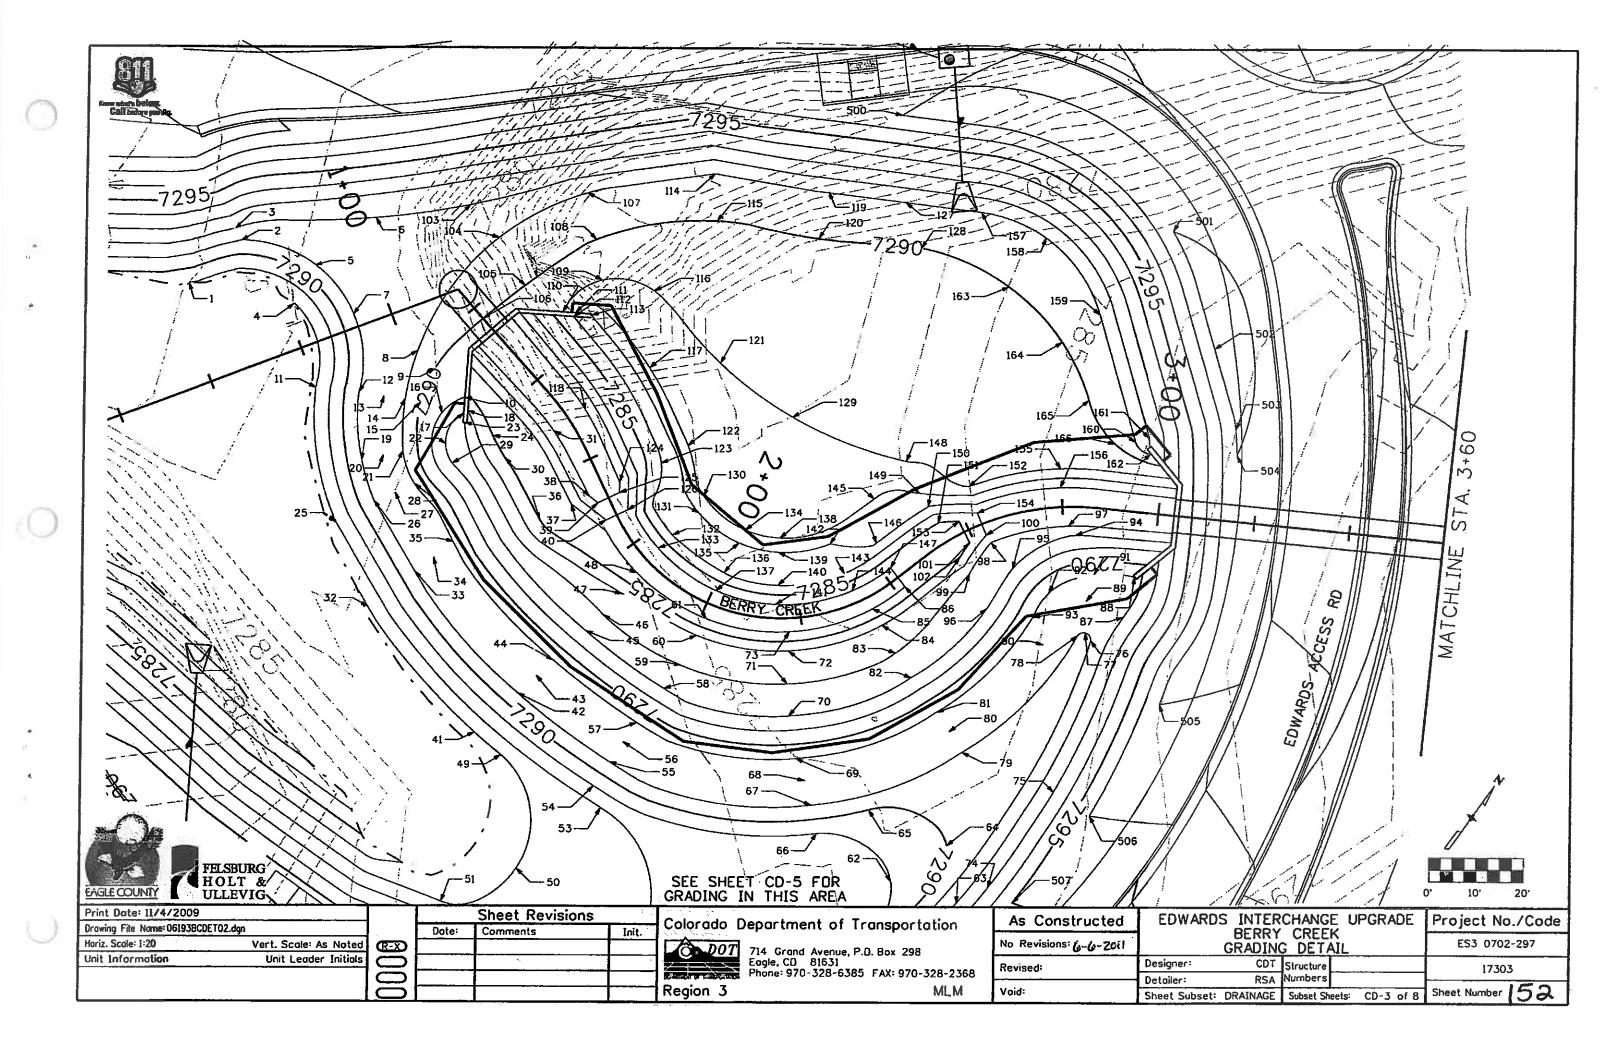


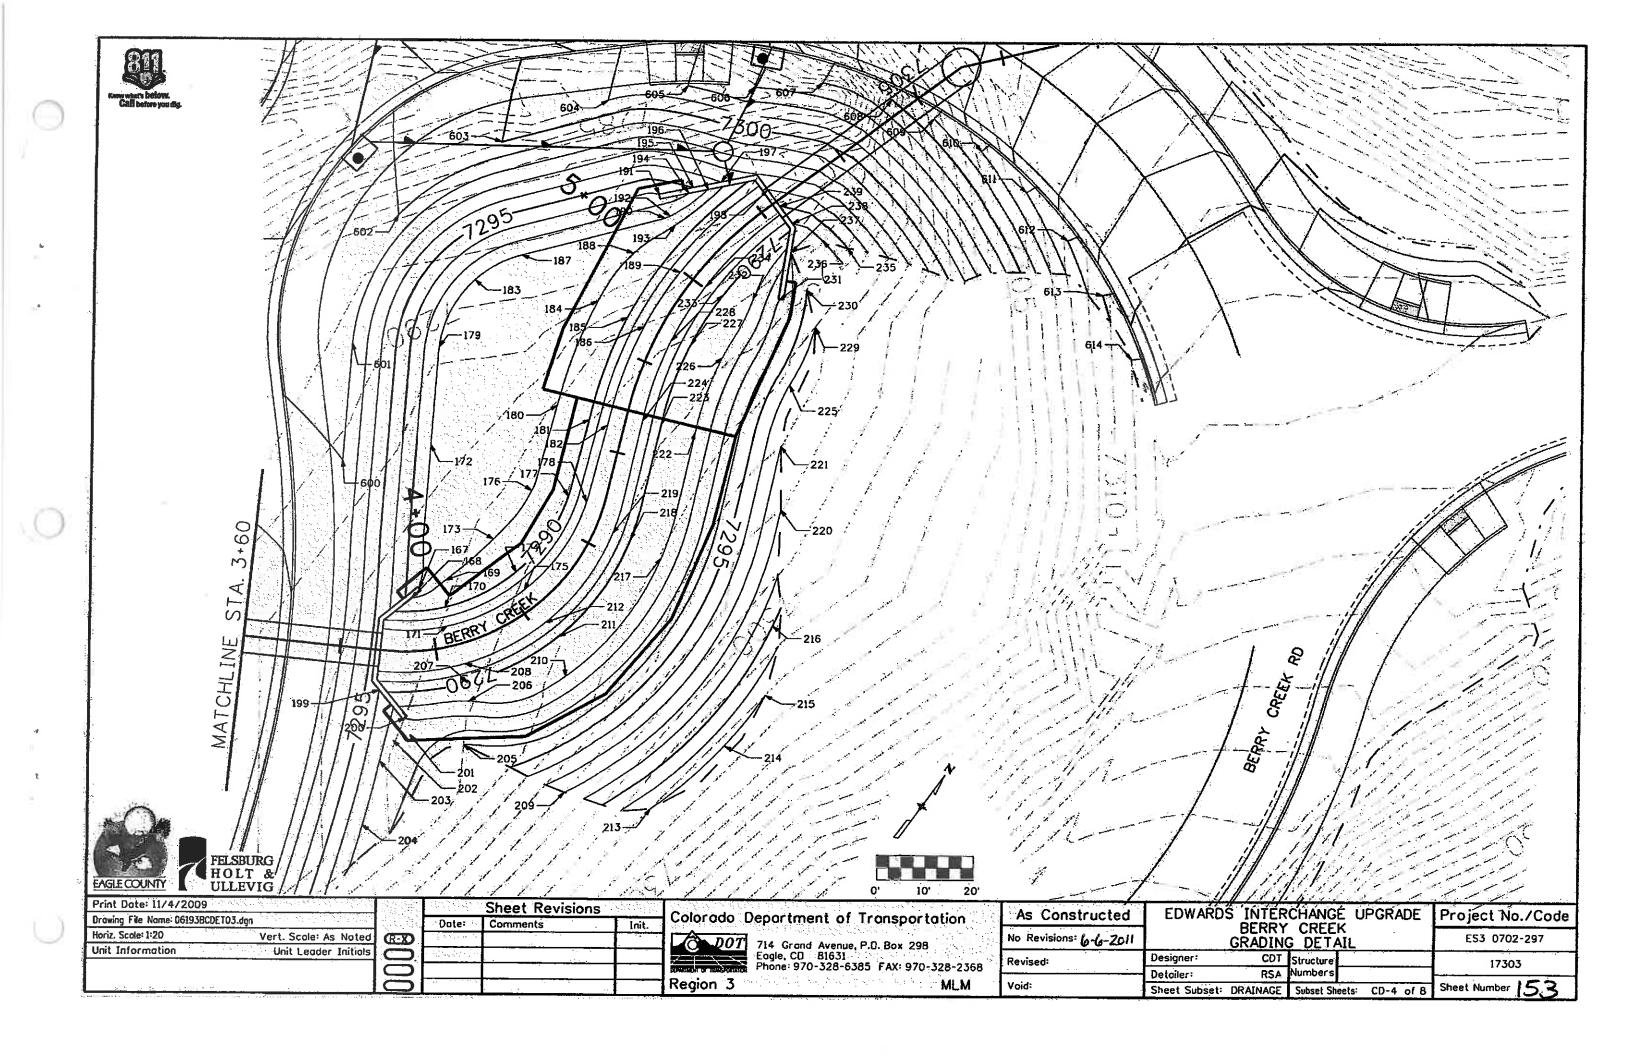
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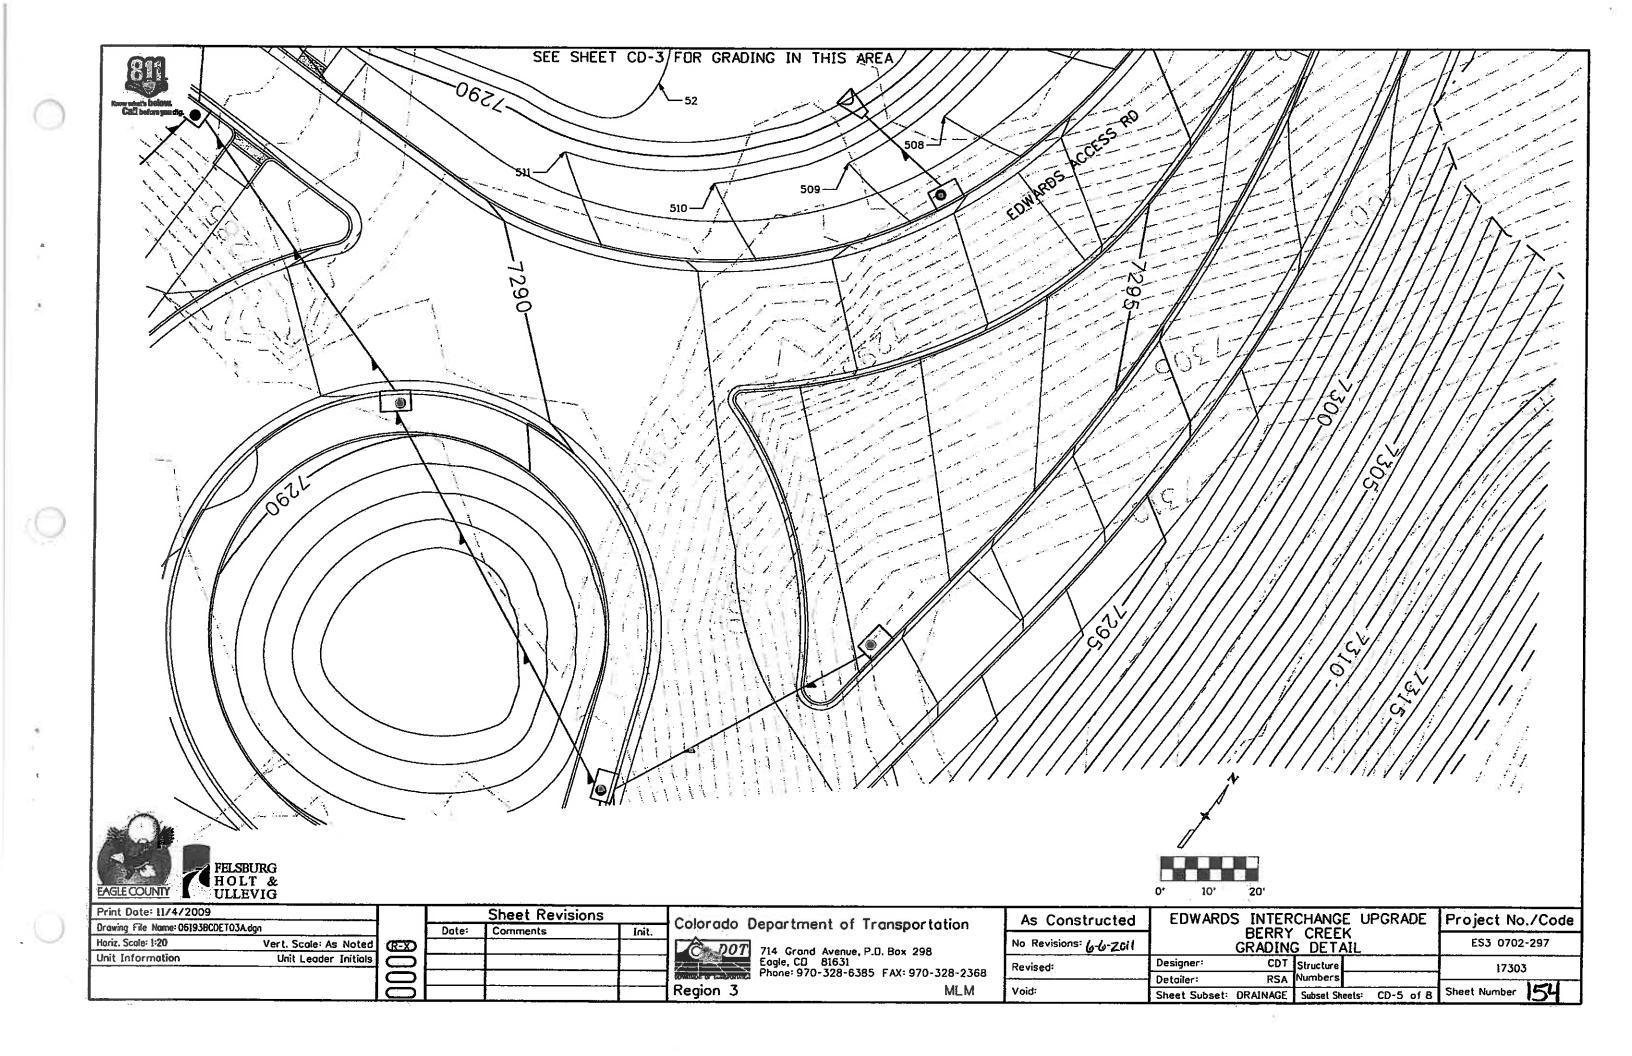
Colorado Department of Transportation

0 001	714 Grand Avenue, P.D. Bo Eagle, CD 81631	x 298
	Eagle, CD 81631	
Transfer of the second	Phone: 970-328-6385 FAX	X: 970-328-236
Region 3		MLM

	As Constructed	EDWARDS INTERCHA BERRY C	ANGE UPGRADE	Project No./Code
1	No Revisions: 6-6-2011	GRADING COURD	ES3 0702-297	
	Revised:	Designer: CDT Stru	17303	
ł		Detailer: RSA Num		3
i	Void:	Sheet Subset: DRAINAGE Sub	osel Sheets: CD-2 of 8	Sheet Number 5









RIPRAP (18 INCH) POINT CHART

-	POINT	NORTHING	EASTING	ELEVATION	DESCRIPTION
F	RI	63686.41	93789.44	7288.20	LIMITS OF BURIED RIPRAP (18 INCH)
ŀ	- <u>R2</u> -	63690,65	93796.22	7287.70	LIMITS OF BURIED RIPRAP (18 INCH)
ŀ	R3 R4	63681.50	93814.63	7287.00	LIMITS OF SURIED RIPRAP (18 INCH)
ŀ	R5	63670.18 63668.75	93832.05	7287.20 7286.80	LIMITS OF BURIED RIPRAP (18 INCH)
ŀ	R6	63678.03	93861.46	7287.10	LIMITS OF BURIED RIPPAP (18 INCH)
r	R7	63696.60	93870.10	7287.60	LIMITS OF BURIED RIPRAP (18 INCH) LIMITS OF BURIED RIPRAP (18 INCH)
r	R8	63719.14	93884.44	7288.80	LIMITS OF BURIED RIPRAP (18 INCH)
r	R9	63732.78	93900.48	7290.50	LIMITS OF BURIED RIPRAP (18 INCH)
L	RIØ	63735.68	93901.25	7291.32	LIMITS OF BURIED RIPRAP (18 INCH)
L	R11	63733.62	93908.98	7292.90	LIMITS OF BURIED RIPRAP (18 INCH)
_	R12	63731.69	93908.47	7292.35	LIMITS OF BURIED RIPRAP (18 INCH)
_	R13	63732.72	93904.60	7291.65	LIMITS OF BURIED RIPRAP (18 INCH)
_	<u>R14</u>	63731.75	93904.35	7291.30	LIMITS OF BURIED RIPRAP (18 INCH)
_	<u>R15</u>	63729.17	93914.01	7287.60	LIMITS OF BURIED RIPRAP (18 INCH)
_	RIG	63718.36	93920.27	7287.60	LIMITS OF BURIED RIPRAP (18 INCH)
_	R17	63708.69	93917.69	7290.40	LIMITS OF BURIED RIPRAP (18 INCH)
-	R18	63708.44	93918.66	7291,10	LIMITS OF BURIED RIPRAP (18 INCH)
-	R19 R20	63712.30	93919,69	7292.10	LIMITS OF BURIED RIPRAP (18 INCH)
-	R21	63711.79	93921.62	7292.50	LIMITS OF BURIED RIPRAP (18 INCH)
-	R22	63688.78	93919.56 93904.79	7290.72	LIMITS OF BURIED RIPRAP (18 INCH)
_	R23	63668.05	93902.50	7290.10 7290.00	LIMITS OF BURIED RIPRAP (18 INCH)
-	R24	63648.72	93893.47	7290.10	LIMITS OF BURIEO RIPRAP (18 INCH) LIMITS OF BURIEO RIPRAP (18 INCH)
-	R25	63634.61	93878.97	7290.00	LIMITS OF BURIED RIPRAP (18 INCH)
_	RŽ6	63625.70	93862.57	7290.20	LIMITS OF BURIED RIPRAP (18 INCH)
-	R27	63624.56	93834.47	7290,20	LIMITS OF BURIEO RIPRAP (18 INCH)
	R28	63628.82	93809.16	7290.28	LIMITS OF BURIED RIPRAP (18 INCH)
	R29	63638.87	93783.79	7290.00	LIMITS OF BURIED RIPRAP (18 INCH)
_	R30	63655.16	93782.23	7288.40	LIMITS OF BURIED RIPRAP (18 INCH)
	R31	63656.22	93783.92	7288.20	LIMITS OF BURIED RIPRAP (18 INCH)
	R32	63652.83	93786.05	7286.70	LIMITS OF BURIED RIPRAP (18 INCH)
	R33	63653.27	93786.75	7286.30	LIMITS OF BURIED RIPRAP (18 INCH)
	R34	63665.99	93778.80	7282.40	LIMITS OF BURIED RIPRAP (18 INCH)
	R35	63678.17	93781.61	7282.40	LIMITS OF BURIED RIPRAP (18 INCH)
	R36	63686.12	93794.33	7286.30	LIMITS OF BURIED RIPRAP (18 INCH)
	R37	63686.83	93793,89	7286.60	LIMITS OF BURIED RIPRAP (18 INCH)
	R38_	63684.71	93790.50	7287.80	LIMITS OF BURIED RIPRAP (18 INCH)
	R39	63754.42	94006.59	7293.00	LIMITS OF BURIED RIPRAP (18 INCH)
	R40 R41	63756.48	93998.86	7292.95	LIMITS OF BURIEO RIPRAP (18 INCH)
	R42	63758.42 63757.38	93999.38	7292.50 7291.60	LIMITS OF BURIEO RIPRAP (18 INCH) LIMITS OF BURIEO RIPRAP (18 INCH)
	R43	63758.35	94003.50	7291.40	LIMITS OF BURIED RIPRAP (18 INCH)
	R44	63760.93	93993.84	7288.30	LIMITS OF BURIED RIPRAP (18 INCH)
	R45	63771.75	93987.58	7288.50	LIMITS OF BURIED RIPRAP (18 INCH)
	R46	63781.41	93990.16	7291.30	LIMITS OF BURIED RIPRAP (18 INCH)
	R47		93989.19	7291.70	LIMITS OF BURIED RIPRAP (18 INCH)
	R48	63777.80	93988.16	7292.65	LIMITS OF BURIED RIPRAP (18 INCH)
Ī	R49	63778.32	93986.23	7293.10	LIMITS OF BURIED RIPRAP (18 INCH)
	R50	63786.05	93988.29	7291.40	LIMITS OF BURIEO RIPRAP (18 INCH)
	R51	63784.08	93995.66	7290.00	LIMITS OF BURIED RIPRAP (18 INCH)
	R52	63801.67	94001.11	7290.00	LIMITS OF BURIED RIPRAP (18 INCH)
_	R53	63814.65	93999.73	7290.00	LIMITS OF BURIED RIPRAP (18 INCH)
	154	63833.14	93992,21	7290.10	LIMITS OF BURIED RIPRAP (18 INCH)
	355	63830.38	93985.44	7290.70	LIMITS OF BURIED RIPRAP (18 INCH)
	₹56 ₹57	63843.15 63876.02	93981-16	7290.70	LIMITS OF BURIED RIPRAP (18 INCH)
	158	63882.77	93976.57	7293.80 7294.80	LIMITS OF BURIED RIPRAP (18 INCH)
	159	63881.41	93984.24	7294.20	LIMITS OF BURIED RIPRAP (18 INCH)
	160	63877.61	93980.75	7293.50	LIMITS OF BURIED RIPRAP (18 INCH)
	161	63876.94	93981.48	7293.20	LIMITS OF BURIED RIPRAP (18 INCH)
	162	63891.66	93995.02	7289,10	LIMITS OF BURIED RIPRAP (18 INCH)
	₹63	63887.89	94006.93	7289.20	LIMITS OF BURIED RIPRAP (18 INCH)
	₹64	63874.57	94013.84	7292.50	LIMITS OF BURIED RIPRAP (18 INCH)
	₹65	63875.03	94014.73	7292.70	LIMITS OF BURIED RIPRAP (18 INCH)
	₹66	63878.5B	94012.89	7292.90	LIMITS OF BURIED RIPRAP (18 INCH)
	67	63879.50	94014.66	7293.60	LIMITS OF BURIED RIPRAP (18 INCH)
	168	63872.90	94018.09	7293.55	LIMITS OF BURIED RIPRAP (18 INCH)
	169	63846.02	94023.86	7293.40	LIMITS OF BURIED RIPRAP (18 INCH)
	70	63828.28	94031.08	7293.20	LIMITS OF BURIED RIPRAP (18 INCH)
		63807.38	94035.88	7293.20	LIMITS OF BURIED RIPRAP (18 INCH)
	72	63786.61 63769.58	94034.07	7293.30	LIMITS OF BURIED RIPRAP (18 INCH)
м	73	03/07.08	94025.97	7293.00	LIMITS OF BURIED RIPRAP (IB INCH)

RIPRAP (42 INCH) (SPECIAL) POINT CHART

IPR.	AP (42	INCH) (SF	ELEVATION	INT CHART  OESCRIPTION
BI	63678.26	93786.84	7285.00	TOP OF RIPRAP (42 INCH) (SPECIAL
82	63674.16	93782.65	7283.50	TOP OF RIPRAP (42 INCH) (SPECIAL
B3	63670.86	93784.58	7283.50	TOP OF RIPRAP (42 INCH) (SPECIAL
B4	63668.27	93781.40	7283.50	TOP OF RIPRAP (42 INCH) (SPECIAL
85	63661.79	93784.70	7285.50	TOP OF RIPRAP (42 INCH) (SPECIAL
<u>86</u>	63661.90	93800.05	7285.00	TOP OF RIPRAP (42 INCH) (SPECIAL
<u>87</u> 88	63672.86 63659.12	93804.59	7284.00	TOP OF RIPRAP (42 INCH) (SPECIAL
B9	63662.22	93808.65	7284.00 7283.50	TOP OF RIPRAP (42 INCH) (SPECIAL TOP OF RIPRAP (42 INCH) (SPECIAL
B10	63657.B3	93811.40	7283.50	TOP OF RIPRAP (42 INCH) (SPECIAL
B11	63664.03	93815.11	7283.50	TOP OF RIPRAP (42 INCH) (SPECIAL
B12	63664.89	93820.86	7285.00	TOP OF RIPRAP (42 INCH) (SPECIAL
B13	63660.20	93822.77	7284.50	TOP OF RIPRAP (42 INCH) (SPECIAL
314 315	63654.65	93817.51	7283.50	TOP OF RIPRAP (42 INCH) (SPECIAL
316	63656.03 63651.16	93822.35	7284.50 7285.50	TOP OF RIPRAP (42 INCH) (SPECIAL TOP OF RIPRAP (42 INCH) (SPECIAL
317	63647.23	93820.26	7386.00	TOP OF RIPRAP (42 INCH) (SPECIAL
18	63647.10	93824.37	7286.00	TOP OF RIPRAP (42 INCH) (SPECIAL
319	63651.58	93827.80	7285.00	TOP OF RIPRAP (42 INCH) (SPECIAL
320	63656.26	93826-14	7285.00	TOP OF RIPRAP (42 INCH) (SPECIAL
321	63660.31	93829,11	7287.00	TOP OF RIPRAP (42 INCH) (SPECIAL
322	63647.09	93828.30	7286.00	TOP OF RIPRAP (42 INCH) (SPECIAL
323 324	63648.00 63657.11	93833.23 93851.93	7285.50	TOP OF RIPRAP (42 INCH) (SPECIAL
25	63648.31	93855.13	7285.50 7286.50	TOP OF RIPRAP (42 INCH) (SPECIAL TOP OF RIPRAP (42 INCH) (SPECIAL
26	63643.35	93853.62	7288.00	TOP OF RIPRAP (42 INCH) (SPECIAL
27	63644.60	93859.77	7288.00	TOP OF RIPRAP (42 INCH) (SPECIAL
28	63648.97	93864.01	7287.50	TOP OF RIPRAP (42 INCH) (SPECIAL
329	63653.35	93857.71	7287.00	TOP OF RIPRAP (42 INCH) (SPECIAL
336	63660.31	93868.53	7285.00	TOP OF RIPRAP (42 INCH) (SPECIAL
331 332	63661.99 63671.71	93874.46	7286.50	TOP OF RIPRAP (42 INCH) (SPECIAL
133	63676.35	93868.39 93866.47	7286.50 7286.00	TOP OF RIPRAP (42 INCH) (SPECIAL TOP OF RIPRAP (42 INCH) (SPECIAL
34	63675.91	93870.41	7287 50	TOP OF RIPRAP (42 INCH) (SPECIAL
35	63680,35	93870.79	7287.50	TOP OF RIPRAP (42 INCH) (SPECIAL
336	63677,56	93881.12	7286.00	TOP OF RIPRAP (42 INCH) (SPECIAL
37	63683.02	93878.65	7285.70	TOP OF RIPRAP (42 INCH) (SPECIAL
138	63686.92	93876.92	7286.00	TOP OF RIPRAP (42 INCH) (SPECIAL
39	63685.43 63694.31	93882.74 93875.96	7286.00 7287.50	TOP OF RIPRAP (42 INCH) (SPECIAL TOP OF RIPRAP (42 INCH) (SPECIAL
141	63690.63	93885.95	7286.50	TOP OF RIPRAP (42 INCH) (SPECIAL TOP OF RIPRAP (42 INCH) (SPECIAL
42	63692.67	93890.41	7288.50	TOP OF RIPRAP (42 INCH) (SPECIAL
43	63696.67	93883.46	7286.50	TOP OF RIPRAP (42 INCH) (SPECIAL
44	63700.51	93880.89	7288.50	TOP OF RIPRAP (42 INCH) (SPECIAL
45	63704.60	93879.71	7290.50	TOP OF RIPRAP (42 INCH) (SPECIAL
46 47	63705,29 63701,33	93884.01	7289.00	TOP OF RIPRAP (42 INCH) (SPECIAL
48	63697.22	93885.10 93888.70	7288.30 7287.50	TOP OF RIPRAP (42 INCH) (SPECIAL TOP OF RIPRAP (42 INCH) (SPECIAL
49	63700.38	93893.91	7289.00	TOP OF RIPRAP (42 INCH) (SPECIAL
50	63701.07	93899.83	7290.00	TOP OF RIPRAP (42 INCH) (SPECIAL
51	63709.08	93886.96	7289.00	TOP OF RIPRAP (42 INCH) (SPECIAL
52	63714.06	93887.68	7290.50	TOP OF RIPRAP (42 INCH) (SPECIAL
53	63723.12 63727.38	93906.17	7289.00	TOP OF RIPRAP (42 INCH) (SPECIAL
54 55	63712.42	93909.91	7290.00 7291.00	TOP OF RIPRAP (42 INCH) (SPECIAL TOP OF RIPRAP (42 INCH) (SPECIAL
56 T	63774.74	93991.21	7291.00	TOP OF RIPRAP (42 INCH) (SPECIAL
57	63775.90	93996.15	7289.50	TOP OF RIPRAP (42 INCH) (SPECIAL
58	63761.69	93997.77	7291.00	TOP OF RIPRAP (42 INCH) (SPECIAL
59	63765.75	93998.37	7289.50	TOP OF RIPRAP (42 INCH) (SPECIAL
50	63764.23	94001.91	7291.50	TOP OF RIPRAP (42 INCH) (SPECIAL
61 52	63764.86 63768.84	94007.19	7292.50 7291.50	TOP OF RIPRAP (42 INCH) (SPECIAL TOP OF RIPRAP (42 INCH) (SPECIAL
63	63770.02	94012.87	7292.30	TOP OF RIPRAP (42 INCH) (SPECIAL
54	63774.78	94013.70	7292.00	TOP OF RIPRAP (42 INCH) (SPECIAL
55	63777.21	94017.34	7292.00	TOP OF RIPRAP (42 INCH) (SPECIAL
66	63781.31	94015.22	7291.50	TOP OF RIPRAP (42 INCH) (SPECIAL
57	63787.75	94002.60	7290.50	TOP OF RIPRAP (42 INCH) (SPECIAL
58	63793.59	94013.42	7289.30	TOP OF RIPRAP (42 INCH) (SPECIAL
69 70	63793.74	94019.29	7291.50	TOP OF RIPRAP (42 INCH) (SPECIAL
70   71	63805.08	94015.75 94008.57	7289.40	TOP OF RIPRAP (42 INCH) (SPECIAL)
72	63808.83	94003.18	7289.50 7291.80	TOP OF RIPRAP (42 INCH) (SPECIAL) TOP OF RIPRAP (42 INCH) (SPECIAL)
73	63809.97	94006.81	7290.50	TOP OF RIPRAP (42 INCH) (SPECIAL)

#### RIPRAP (42 INCH) (SPECIAL) POINT CHART (CONTINUED)

			<del>,</del>	· · · · · · · · · · · · · · · · · · ·
POINT	NORTHING	EASTING	ELEVATION	DESCRIPTION
B74	63809.12	94010.51	7289.00	TOP OF RIPRAP (42 INCH) (SPECIAL)
B75	63808.19	94014.12	7289.00	TOP OF RIPRAP (42 INCH) (SPECIAL)
B76	63807.11	94018.67	7290.50	TOP OF RIPRAP (42 INCH) (SPECIAL)
B77	63812.04	94017.02	7290.00	TOP OF RIPRAP (42 INCH) (SPECIAL)
B78	63816.58	94019.72	7291.70	TOP OF RIPRAP (42 INCH) (SPECIAL)
B79	63814.13	94004.89	7290.50	TOP OF RIPRAP (42 INCH) (SPECIAL)
880	63835.58	94008.29	7290.00	TOP OF RIPRAP (42 INCH) (SPEC(AL)
B81	63842.85	93997,39	7289.50	TOP OF RIPRAP (42 INCH) (SPECIAL)
B82	63847.49	93994.15	7290.50	TOP OF RIPRAP (42 INCH) (SPECIAL)
883	63862.17	93988.62	7291.80	TOP OF RIPRAP (42 INCH) (SPECIAL)
884	63869.00	93991.44	7291.00	TOP OF RIPRAP (42 INCH) (SPECIAL)
B85	63869.39	94000.75	7290.00	TOP OF RIPRAP (42 INCH) (SPECIAL)
B86	63873.49	93993.39	7290.00	TOP OF RIPRAP (42 INCH) (SPECIAL)
B87	63878.43	93990.81	7291.50	TOP OF RIPRAP (42 INCH) (SPECIAL)
B88	63874.55	94002.96	7290.50	TOP OF RIPRAP (42 INCH) (SPECIAL)
B89	63876.80	_94007.71	7292.00	TOP OF RIPRAP (42 INCH) (SPECIAL)
B90	63879.44	94003.35	7290.50	TOP OF RIPRAP (42 INCH) (SPECIAL)
891	63877.66	94000.67	7289.50	TOP OF RIPRAP (42 INCH) (SPECIAL)
B92	63882.59	93993.11	7291.00	TOP OF RIPRAP (42 INCH) (SPECIAL)
B93	63888.43	93995.31	7290.50	TOP OF RIPRAP (42 INCH) (SPECIAL)
B94	63884.73	93997.10	7289.20	TOP OF RIPRAP (42 INCH) (SPECIAL)
B95	63882.27	94000.14	7289.20	TOP OF RIPRAP (42 INCH) (SPECIAL)
B96	63883.66	94003.50	7290.00	TOP OF RIPRAP (42 INCH) (SPECIAL)
897	63886,10	94006.00	7291.00	TOP OF RIPRAP (42 INCH) (SPECIAL)

### TABULATION OF BERRY CREEK REALIGNMENT

RIPRAP (18 INCH)	TOPSO IL	RIPRAP (42 INCH) (SPECIAL)	RIPRAP (SPECIAL)	CONCRETE CLASS B	
C.Y.	C.Y.	EACH	C.Y.	C.Y.	
525	230	97	447	35	

#### NOTES:

- 1 QUANTITIES ARE CARRIED FORWARD TO THE SUMMARY OF APPROXIMATE QUANTITIES SHEETS.
- 2. TOPSOIL QUANTITY ONLY INCLUDES WHAT IS SHOWN ON TYPICAL SECTIONS FOR BERRY CREEK CT-) THRU CT-4.
- 3. SEE SHEET DD-4 FOR RIPRAP (SPECIAL) DETAILS.
- 4. ELEVATION IS GIVEN FOR TOP OF RIPRAP (42 INCH) (SPECIAL) IS APPROIMATE AND SHALL BE ADJUSTED IN THE FIELD AS NECESSARY. SEE SHEET CT-4 FOR PLACEMENT DETAILS.



FELSBURG

Print Date: 11/4/2009	·		Sheet Revisions			
Drawing File Name: 06193BCDE	TO4,dgn		Date:	Comments	Init.	
Hariz, Scale: 1:1	Vert. Scale: As Noted	(R-X)	•	<del>                                     </del>		
Unit Information	Unit Leader Initials			T		

Colorado Department of Transportation



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As Constructed	EDWARDS INTERCHANGE UPGRADE BERRY CREEK			UPGRADE	Project No./Code	
No Revisions: 6-6-201	RIPRAP COORDINATE DATA				ES3 0702-297	
Revised:	Designer:		Structure		17303	
	Detailer:	RSA	Numbers			
Void:	Sheet Subset:	DRAINAGE	Subset Sheets	CD-6 of 8	Sheet Number   55	

