Oversight / NHS

FHWA OVERSIGHT DNO #YES

NATIONAL HIGHWAY SYSTEM DNO #YES

# DEPARTMENT OF TRANSPORTATION STATE OF COLORADO

Project Number - IM 070A-003
Project Code - 16701

R.O.W. Projects
R.O.W. Project Description
Project Number Project Code -

Related Projects: P. E. UNDER PROJECT:

FIELD INSPECTION REVIEW 02/28/08


HIGHWAY CONSTRUCTION BID PLANS OF PROPOSED FEDERAL AID PROJECT NO. IM 070A-003 INTERSTATE 70

EAGLE, SUMMIT, CLEAR CREEK, JEFFERSON COUNTY CONSTRUCTION PROJECT CODE NO. 16701

#### TABULATION OF LENGTH & DESIGN DATA

	FE	FEET				
ST	RDADV		MAJOR			
v	I-70	)	STA.			
MILEPOST Approach to Project MP 176	STA. BEGINNING	STA. EN	ND	TDTA DIST (		
MP 177 EB MP 183 EB MP 184 EB MP 185 EB MP 195 EB MP 203 EB MP 205 EB MP 210 WB MP 211 WB MP 211 WB MP 212 WB MP 223 WB MP 223 WB MP 228 WB MP 228 WB MP 229 WB MP 243 WB MP 254 WB End of Project MP 254	10+00.00 10+00.00 10+00.00 10+00.00 10+00.00 10+00.00 10+00.00 10+00.00 10+00.00 10+00.00 10+00.00 10+00.00 10+00.00 10+00.00 10+00.00 10+00.00 10+00.00 10+00.00	36+50.0 24+00.0 33+00.0 39+00.0 24+00.0 17+50.0 19+00.0 22+00.0 19+00.0 22+00.0 44+00.0 23+50.0	00 00 00 00 00 00 00 00 00 00 00 00 00	2650 1400 1300 2900 1400 750 750 1700 1900 900 1200 2800 3400 1300 900.1	000000000000000000000000000000000000000	
TOTAL				27500	0.0	****
SUMMARY OF PROJECT LENGTH	ET		MILES			
ROADWAY (NET LENGTH)	0.00		5.2			
PROJECT GROSS LENGTH			411,	840.0		78.0

SHEET NO.	TITLE SHEET DESCRIPTION
2 3	STANDARD PLANS LIST
3	TYPICAL SECTIONS
4 5 - 6	GENERAL NOTES SUMMARY OF APPROXIMATE QUANTITIES
	TABULATIONS
7 8	MILEPOST INFORMATION
9 - 12	STATION LOCATION PLANS
13 - 18	BDRING DETAILS
19	SPECIAL LIGHT STANDARD DETAILS
20 - 21	TELECOMMUNICATIONS
22 - 45	LIGHTING PLAN
46 - 50	STORMWATER MANAGEMENT PLAN
51	TABULATION OF TRAFFIC ENGINEERING ITEMS
52 - 62	SIGNING PLAN
63 - 73	FIBER COMMUNICATION PLANS
74 - 90	CONDUIT PLAN AND SWMP SITE MAP

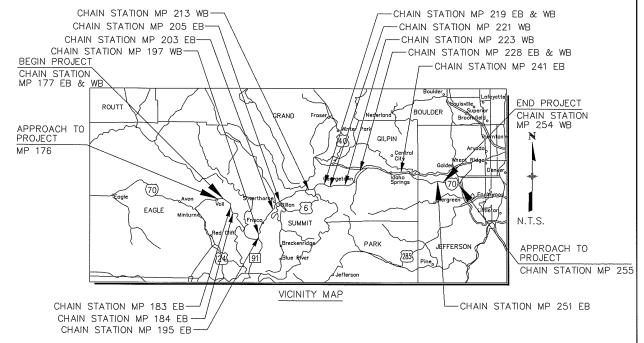

Computer	File Inform	<u>ation</u>				
Creation Date:	02/18/08	Initials:	SRB			
Last Modification Date:	02/25/08	Initials:	SRB			
Full Path: S:\Tranproj\100000508\16701\Consultants\Plot_Sets\FIR						
Drawing File Name:		gets.0	01.dgn			
Scale: NTS	1	Jnits: EN	GLISH			

١	ndex of Revisions	 
		<b>L</b> ∂ DO
		DEPARTMENT OF TRANSPORTA
		 REGION I

OT Region 1
18500 East Colitox
Autora, CO 80011
Phone: (303) 365-7340
FAX: (303) 355-7343

0	4601 DTC Blvd.
	Suite 700 Denver, CO 80237 Phone: (303) 221-7275 Fax: (303) 221-7276

As Constructed	Contract Information	Project No./Code		
No. Revisions:	Contractor:	IM 070A-003		
	Resident Engineer:	1101 0707( 000		
Revised:	Project Engineer:	16701		
	Project Started: Project Accepted:			
Void:	Comments:	Sheet Number: 1		

	NEW OR M STANDARD REVISED <u>TITLE</u>	PAGE NUMBER	PLAN NEW OR M STANDARD <u>NUMBER REVISED</u> <u>TITLE</u>	PAGE NUMBER	PLAN NEW OR NUMBER REVISED	S STANDARD TITLE	PAGE NUMBER
■ M-100-1	STANDARD SYMBOLS (3 SHEETS)	1-3	☐ M-607-1 ☐ WRE FENCES AND GATES (3 SHEETS)	84-86	S-612-1 DELINEATOR INSTALLA	TIONS (5 SHEETS)	131-135
	☐ APPROACH ROADS	4	☐ M-607-2 ☐ CHAIN LINK FENCE (3 SHEETS)	87-89	■ S-614-1 □ GROUND SIGN PLACEM	ENT (2 SHEETS)	136-137
	☐ DITCH TYPES	5	☐ M-607-3 ☐ BARRIER FENCE	90	■ S-614-2 □ CLASS I SIGNS	· ·	138
	SUPERELEVATION CROWNED AND	6-8	☐ M-607-4 ☐ DEER FENCE AND GATES (2 SHEETS)	91-92	■ S-614-3 □ CLASS II SIGNS		139
	DIVIDED HIGHWAYS (3 SHEETS)		☐ M-607-10 ☐ PICKET SNOW FENCE	93	■ S-614-4 □ CLASS III SIGNS (3 SF	(EETS)	140-142
	SUPERELEVATION STREETS (2 SHEETS)	9-10	☐ M-607-15 ☐ ROAD CLOSURE GATE (9 SHEETS)	94-102	S-614-5 BREAK-AWAY SIGN SL	JPPORT DETAILS	143144
M-206-1	<ul> <li>EXCAVATION AND BACKFILL FOR STRUCTURES</li> <li>(2 SHEETS)</li> </ul>	11-12	☐ M-608-1 ☐ CURB RAMPS (4 SHEETS)	103-106	FOR GROUND SIGNS (	•	415 410
☐ M-206-2	EXCAVATION AND BACKFILL FOR BRIDGES (2 SHEETS	S) 13-14	☐ M-609-1 ☐ CURBS, GUTTERS, AND SIDEWALKS (3 SHEETS)	107-109	■ S-614-6 □ CONCRETE FOOTINGS / FOR CLASS III SIGNS (		145-146
■ M-208-1	☐ TEMPORARY EROSION CONTROL (7 SHEETS)	15-21	☐ M-611-1 ☐ CATTLE GUARD (2 SHEETS)	110-111	■ S-614-8 □ TUBULAR STEEL SIGN	SUPPORT DETAILS (5 SHEETS)	147151
	☐ MAILBOX SUPPORTS (2 SHEETS)	22-23	■ M-613-1 □ ROADWAY LIGHTING (4 SHEETS)	112-115	■ S-614-10 □ MARKER ASSEMBLY IN	STALLATIONS	152
☐ M-214-1	☐ PLANTING DETAILS	24	☐ M-614-1 ☐ RUMBLE STRIPS (3 SHEETS)	116-118	☐ S-614-12 ☐ STRUCTURE NUMBER I	NSTALLATION	153
	CONCRETE PAVEMENT JOINTS (5 SHEETS)	25-29	☐ M-614-2 ☐ SAND BARREL ARRAYS (2 SHEETS)	119-120	■ S-614-14 □ FLASHING BEACON AN	D SIGN INSTALLATIONS (3 SHEETS)	S) 154-156
☐ M-510-1	☐ STRUCTURAL PLATE PIPE H-20 LOADING	30	☐ M-615-1 ☐ EMBANKMENT PROTECTOR TYPE 3	121	■ S-614-20 □ TYPICAL POLE MOUNT	SIGN INSTALLATIONS	157
□ M-601-1	☐ SINGLE CONCRETE BOX CULVERT (2 SHEETS)	31-32	☐ M—615—2 ☐ EMBANKMENT PROTECTOR TYPE 5	122	☐ S-614-21 ☐ CONCRETE BARRIER SI	GN POST INSTALLATIONS	158
	□ DOUBLE CONCRETE BOX CULVERT (2 SHEETS)	33-34	☐ M-616-1 ☐ INVERTED SIPHON	123	■ S-614-22 □ TYPICAL MULTI-SIGN I	NSTALLATIONS	159
	☐ TRIPLE CONCRETE BOX CULVERT (2 SHEETS)	35-36	☐ M-620-1 ☐ FIELD LABORATORY CLASS 1	124	☐ S-614-40 ☐ TYPICAL TRAFFIC SIGN	AL INSTALLATION DETAILS	160-166
	☐ HEADWALL FOR PIPES	37	☐ M-620-2 ☐ FIELD LABORATORY CLASS 2	125	(7 SHEETS)		
	☐ TYPE "S" SADDLE HEADWALLS FOR PIPE	38	☐ M-620-11 ☐ FIELD OFFICE CLASS 1	126	☐ S-614-40A ☐ ALTERNATIVE TRAFFIC (5 SHEETS)	SIGNAL INSTALLATION DETAILS	167–171
☐ M-601-12	☐ HEADWALLS AND PIPE OUTLET PAVING	39	☐ M-620-12 ☐ FIELD OFFICE CLASS 2	127	☐ S-614-50 ☐ MONOTUBE OVERHEAD	SIGNS (14 SHEETS)	172-185
	☐ WINGWALLS FOR PIPE OR BOX CULVERTS	40	☐ M-629-1 ☐ SURVEY MONUMENTS (2 SHEETS)	128-129	■ S-627-1 □ PAVEMENT MARKINGS	(5 SHEETS)	186-190
		41-42			■ S-630-1 □ TRAFFIC CONTROLS FO	OR HIGHWAY CONSTRUCTION	191-202
	☐ REINFORCED CONCRETE PIPE	43			(12 SHEETS)		
□ M-603-3	□ PRECAST CONCRETE BOX CULVERT	44			■ S-630-2 □ BARRICADES, DRUMS, AND VERTICAL PANELS	CONCRETE BARRIERS (TEMP)	203
☐ M-603-10	☐ CONCRETE AND METAL END SECTIONS (2 SHEETS)	45-46			S-630-3  FLASHING BEACON (PO	=	204
	☐ INLET, TYPE C	47			= 5-000-0 El l'Excilité BEXOON (l'é	MIABLE) DETAILS	20+
	☐ INLET, TYPE D	48					
□ M-604-12	☐ CURB INLET TYPE R (2 SHEETS)	49-50					
☐ M-604-13	☐ CONCRETE INLET TYPE 13	51	THE CTANDARD OF AN CHEETS INDICATED HEREOU BY				
□ M-604-20	☐ MANHOLES (3 SHEETS)	52-54	THE STANDARD PLAN SHEETS INDICATED HEREON BY A MARKED BOX ARE TO BE USED TO CONSTRUCT THIS	.			
□ M-604-25	☐ VANE GRATE INLET (5 SHEETS)	55-59	PROJECT.				
☐ M-605-1	SUBSURFACE DRAINS	60	111000011				
	☐ GUARDRAIL TYPE 3 W—BEAM (16 SHEETS)	61-76					1
C 14 COC 47	C ALLEGERIA TIME 7 C CLUDE DIRECTO (4 CUECTO)	77 00			_	11	

☐ M-606-13 ☐ GUARDRAIL TYPE 7 F-SHAPE BARRIER (4 SHEETS)


☐ M-606-14 ☐ PRECAST TYPE 7 CONCRETE BARRIER (3 SHEETS)


77-80

81-83

COLORADO DEPARTMENT OF TRANSPORTATION STANDARD PLANS LIST M&S STANDARDS July 04, 2006

Computer File Information Creation Date: 02/18/08 Initials: SRB	$\overline{}$	Index of Revisions	$\exists$ $\vdash$	POT Region 1	<b>PBS</b> I	As Constructed	STANDARD PLANS LIST	Project No./Code
Last Modification Date: 02/18/08 Initials: SRB	<b>5</b>			18500 East Colfax Aurora, CO 80011 Phone: (303) 365-7340		No. Revisions:	STANDARD PLANS LIST	IM 070A-003
Full Path: S: \Tranproj\100000508\16701\Consultants\Plot_Sets\FIR  Drawing File Name: qespn01.dqn	$\Rightarrow$		- N	EPARTMENT OF TRANSPORTATION FAX: (303) 365-7343	Suite 700 Denver, CO 80237	Revised:	Designer:         SRB         Structure           Detailer:         SRB         Numbers	16701
Scale: Units: ENGLISH	$\prod$		1	REGION I DW	Phone: (303) 221-7275 Fax: (303) 221-7276	Void:	Sheet Subset: Standard Subset Sheets:	Sheet Number: 2

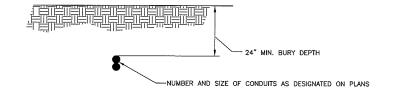

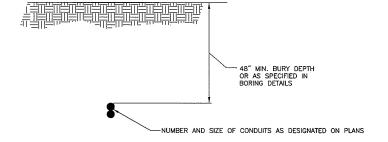

# **TRENCHING**

#### NOTE:

1. THIS WORK SHALL BE PAID AS: ITEM 613, ( ) INCH ELECTRICAL CONDUIT (PLASTIC). LATERALS LESS THAN 100' LONG ASSUMED TO BE STICK-TYPE CONDUIT (PVC SCHEDULE 80), AND LATERALS GREATER THAN 100' LONG ASSUMED TO BE REEL TYPE CONDUIT (HDPE SDR 13.5).

## DIRECTIONAL BORE

#### NOTE:

1. DIRECTIONAL BORES SHALL BE PAID AS ITEM 613, 3" ELECTRICAL CONDUIT BORED. LINEAR FOOT PRICE SHALL BE FULL PAYMENT FOR ALL CONDUITS IN BUNDLE AS DESIGNATED ON PLANS.

Computer File Information Creation Date: 02/18/08 Initials: SRB		Index of Revisions		Region 1	<b>PBSI</b>	As Constructed	TVDICAL	CECTIONS	Project No./Code
Last Modification Date: 02/22/08 Initials: SRB				DOT 18500 East Colfox Aurora, CO 80011 Phone: (303) 365–7340	,	No. Revisions:	TYPICAL	SECTIONS	IM 070A-003
Full Path: S:\Tranproj\100000508\16701\Consultants\Plot_Sets\FIR  Drawing File Name: boringts.dan	=		$\exists$	DEPARTMENT OF TRANSPORTATION FAX: (303) 365-7343	Suite 700 Denver, CO 80237	Revised:		Structure Numbers	16701
Scale: Units: ENGLISH	=		$\dashv$	REGION I DW	Phone: (303) 221-7275 Fax: (303) 221-7276	Void:	Datailor. Onb	Subset Sheets:	Sheet Number: 3

- 1. THE CONTRACTOR SHALL LIMIT CONSTRUCTION ACTIVITIES TO THOSE AREAS WITHIN THE LIMITS OF RIGHT OF WAY. CONTRACTOR SHALL INDEMNIFY AND HOLD COOT SAFE AND HARMLESS FROM ANY CLAIMS OF DAMAGES ARISING FROM THE CONTRACTOR'S USE OF PROPERTY OUTSIDE THE LIMITS OF
- DEPTH OF MOISTURE AND DENSITY CONTROL FOR THIS PROJECT SHALL BE AS FOLLOWS:

FULL DEPTH OF EMBANKMENTS

MINIMUM R VALUE OF 70 REQUIRED IN TOP TWO FEET

BASES OF CUTS AND FILLS ~ 0.5 FT DEPTH

EXCAVATION REQUIRED FOR COMPACTION OF BASES OF CUTS AND FILLS SHALL BE CONSIDERED AS INCIDENTAL TO THAT OPERATION AND WILL NOT BE PAID FOR SEPARATELY.

- 3. TYPE OF COMPACTION FOR THIS PROJECT WILL BE AASHTO T-180.
- 4. FULL COMPLIANCE PAVEMENT MARKINGS AND ROADSIDE DELINEATION SHALL BE IN PLACE AT THE END OF EACH WORKING DAY UNLESS OTHERWISE APPROVED BY THE ROGINEER.
- IF ANY SOIL CONTAMINATION IS SUSPECTED WHILE EXCAVATING, IMMEDIATELY CONTACT THE ENGINEER.
- THE CONTRACTOR SHALL NOT STOCKPILE ANY MATERIAL WITHIN CDOT ROW UNLESS APPROVED BY THE ENGINEER.
- THE CONTRACTOR SHALL SUBMIT A PLAN ADDRESSING LOCAL DRAINAGE DURING EACH PHASE OF CONSTRUCTION TO THE ENGINEER FOR REVIEW. THIS SHALL NOT BE PAID FOR SEPARATELY BUT SHALL BE INCLUDED IN THE WORK.
- CONTROL OF SURFACE RUNOFF AND REPAIR OF DAMAGES RESULTING FROM RUNOFF IS SOLEY THE RESPONSIBILITY OF THE CONTRACTOR AND SHALL BE INCLUDED IN THE COST OF THE WORK.
- ALL REMOVED MATERIALS WILL BECOME THE PROPERTY OF THE CONTRACTOR AND SHALL BE REMOVED FROM THE SITE.
- 10. ALL SHOULDERS AND OTHER PAVED AREAS SHALL BE SWEPT ON A DAILY BASIS
  TO REMOVE ANY FOREION DEBRIS FROM THE SHOULDER AND TRAVELED WAY.
  ALL SWEEPING OPERATIONS SHALL BE DONE BY A PICK-UP TYPE BROOM
  AND SHALL NOT BE PAID FOR SEPARATELY BUT SHALL BE INCLUDED IN
  THE WORLD.
- 11. THE CONTRACTOR SHALL PROTECT ALL EXISTING UTILITIES DURING CONSTRUCTION AND IS RESPONSIBLE FOR ANY DAMAGE THERETO.

#### GENERAL NOTES

- 12. NO UTILITY RESEARCH WAS PERFORMED IN THE DESIGN OF THIS PROJECT. THE 20. UTILITY INFORMATION SHOWN ON THE PLANS ARE PLOTTED FROM THE BEST AVAILABLE INFORMATION. THE CONTRACTOR IS FULLY RESPONSIBLE FOR LOCATING ALL EXISTING UTILITES AND AVOIDING THEM. REFER TO PARAGRAPH 105.10 OF THE STANDARD SPECIFICATIONS. THE CONTRACTOR SHALL CALL 1-800-922-1987 FOR UTILITY LOCATIONS AT LEAST TWO WORKING DAYS PRIOR TO ANY DIGGING, NOT INCLUDING THE DAY OF NOTIFICATION. CONDUIT RUNNING LINE ALIGNMENT MAYBE MOVED TO AVOID EXISTING UTILITIES WITH THE APPROVAL OF THE ENGINEER. CONTRACTOR SHALL NOTIFY ENGINEER IMBEDIATELY OF ANY UTILITY CONFLICT WHICH CANNOT BE READILY RESOLVED AND WHICH MAY REQUIRE REDESIGN OF ANY PART OF THE PROJECT.
- 13. IT IS ESTIMATED THAT 48 HOURS OF POTHOLING WILL BE REQUIRED FOR THE PROJECT, AND WILL BE PAID UNDER ITEM 203, POTHOLING, THE CONTRACTOR SHALL SUBMIT A POTHOLING PLAN TO THE ENGINEER AT THE PRECONSTRUCTION CONFERENCE FOR APPROVAL WHICH DESCRIBES A PLAN FOR POTHOLING ALL EXISTING FACILITIES WHICH MAY BE IMPACTED BY CONSTRUCTION.
- 14. IT SHOULD BE ASSUMED THAT THE CONTRACTOR WILL ENCOUNTER BOULDERS AND ROCKS DURING ALL EXCAVATIONS INCLUDING LIGHT FOUNDATIONS, SITE GRADING, CONDUIT TRENCHING, CONDUIT BORING, AND IGN FOOTINGS. THE CONTRACTOR WILL BE REQUIRED TO EITHER AVOID OR REMOVE BOULDERS AND ROCKS WHEN ENCOUNTERED. THE COST OF THIS WORK SHALL NOT BE PAID FOR SEPARATELY, BUT SHALL BE INCLUDED IN THE COST OF THE WORK.
- DUST PALLIATIVE AND WATER SHALL NOT BE PAID FOR SEPARATELY, BUT SHALL BE INCLUDED IN THE WORK.
- IT IS ESTIMATED THAT 20 DELINEATORS WILL BE RESET AS DIRECTED BY THE ENGINEER.
- 17. IT IS ESTIMATED THAT 400 LINEAR FEET OF FENCE (PLASTIC) (ITEM 607) WILL BE REQUIRED FOR THE PROJECT TO PROTECT MISSCELLANEOUS ITEMS DURING CONSTRUCTION AS DIRECTED BY THE ENGINEER. FENCE SHALL BE RESET AS DIRECTED BY THE ENGINEER. NO ADDITIONAL PAYMENT SHALL BE MADE TO RESET FINCE
- 18. TWO SANITARY FACILITY SHALL BE PROVIDED FOR THE ENGINEER'S USE AND SHALL BE TRAILER MOUNTED FOR EASY MOBILITY AROUND JOBSITE. THE CONTRACTOR SHALL MOVE THE FACILITY AROUND THE JOB SITE AS DIRECTED BY THE FACILITY FIN
- IT IS ESTIMATED THAT 1 LUMP SUM FOR MOBILIZATION (ITEM 626) WILL BE REQUIRED FOR THE PROJECT. IT IS ANTICIPATED THAT MORE THAN ONE MOBILIZATION WILL BE REQUIRED FOR MULTIPLE ACTIVITIES.

- NO FUELS, LUBRICANTS OR OTHER HAZARDOUS MATERIALS WILL BE STORED ALONG THE CORRIDOR.
- WHEREVER FOUND IN THESE PLANS OR ACCOMPANYING PROJECT SPECIAL PROVISIONS, THE TERM EJMT IS DEFINED AS "EISENHOWER—JOHNSON MEMORIAL TUNNELS.
- 22. THE CONTRACTOR SHALL KEEP ONE SET OF PLANS, REVIEWED SHOP DRAWINGS AND WORKING DRAWINGS AVAILABLE ON THE PROJECT SITE AT ALL TIMES. THIS SET SHALL BE DEFINED AS THE "CONSTRUCTION DRAWINGS." THE CONTRACTOR SHALL NOTE ON THESE CONSTRUCTION DRAWINGS ALL CHANGES AND DEVIATIONS FROM THE WORK SHOWN ON THE PLANS, SHOP DRAWINGS AND WORKING DRAWINGS. THE CONSTRUCTION DRAWINGS SHALL BE KEPT CURRENT AS THE WORK PROGRESSES AND NOTATION SHALL BE MADE WITHIN SEVEN DAYS OF THE CHANGE OR DEVIATION. THE FIRST SHEET OR PAGE OF EACH SET OF CONSTRUCTION DRAWINGS SHALL BE STAMPED "AS CONSTRUCTED" AND SIGNED BY THE CONTRACTOR. UPON COMPLETION OF THE WORK AND PRIOR TO FINAL PAYMENT, THE CONSTRUCTION DRAWINGS SHALL BE SUBMITTED TO THE ENGINEER.
- 23. AERIAL TOPOGRAPHIC MAPPING APPROXIMATELY 15 YEARS OLD WAS USED TO DESIGN THIS PROJECT. IT IS THE CONTRACTORS RESPONSIBILITY TO VERIFY THE EXISTING CONDITIONS AT EACH SITE.
- 24. IT IS ESTIMATED THAT 40 HRS OF BLADING WILL BE REQUIRED ON PROJECT AS DIRECTED BY THE ENGINEER.
- 25. IT IS ESTIMATED THAT 2 GROUND SIGNS WILL BE RESET AS DIRECTED BY THE ENGINEER.

CALL UTILITY NOTIFICATION CENTER OF COLORADO 1-800-922-1987

CALL 2-BUSINESS DAYS IN ADVANCE BEFORE YOU DIG, GRADE, OR EXCAVATE FOR THE MARKING OF UNDERGROUND MEMBER UTILITIES

Computer File Information Creation Date: 02/18/08 Initials: SRB	Index of Revisions	 Region 1	DDCI	As Constructed	OFNED	L NOTEC	Project No./Co	de	
Last Modification Date: 02/22/08 Initials: SRB		 18500 East Colfax Aurora, CO 80011	<b>PBS</b> y	No. Revisions:	GENERA	L NOTES	IM 070A-003		
Full Path: S:\Tranproj\100000508\16701\Consultants\Plot_Sets\FIR		Phone: (303) 363-7340	Suite 700	Revised:	Designer: SRB	Structure	16701		
Drawing File Name: geno01.dgn		DEGION I DW	Denver, CO 80237 Phone: (303) 221-7275		Detailer: SRB	Numbers		-	
Scale: Units: ENGLISH	1 1	REGION I DW	Fox: (303) 221-7276	Void:	Sheet Subset: General	Subset Sheets:	Sheet Number:	4	

# SUMMARY OF APPROXIMATE QUANTITIES

	INDEX	CONTRA	i I		TRAFFIC							TO	TALS
BOOK	PAGE SH	EET ITEM N	CONTRACT ITEM	UNIT	PLAN	AS CONST.	PLAN	AS CONST.				PLAN	AS CONST.
		202-008	10 REMOVAL OF GROUND SIGN	EACH	2							2	
		202-008	21 REMOVAL OF SIGN PANEL	EACH	6							6	
		203-015	DO BLADING	HOUR	40							40	
		203-015	POTHOLING	HOUR	48							48	
		208-000	02 EROSION LDG (12 INCH)	LF	3320							3320	
		210-000	90 RESET DELINEATOR	EACH	20							20	
		210-008	IO RESET GROUND SIGN	EACH	2							2	
		212-000	D6 SEEDING (NATIVE)	ACRE	1							1	
		213-000	2 MULCHING (WEED FREE HAY)	ACRE	1						i	1	
		213-000	MULCH TACKIFIER	LB	200							200	
		607-1152	5 FENCE (PLASTIC)	LF	500					İ		500	
		612-002	DO LOCATION MARKER (FIBER OPTIC) (DOME)	EACH	36							36	
		612-002	O LOCATION MARKER (UTILITY) (FLAT SLAT)	EACH	36							36	
		613-003	3 INCH ELECTRICAL CONDUIT (BORED)	LF	500							500	
		613-0112	5 1-1/4 INCH ELECTRICAL CONDUIT (PLASTIC)	LF	9845							9845	
		613-0120	2 INCH ELECTRICAL CONDUIT (PLASTIC)	LF	1900							1900	
		613-0125	0 2-1/2 INCH ELECTRICAL CONDUIT (PLASTIC)	LF	2510							2510	
		613-0130	0 3 INCH ELECTRICAL CONDUIT (PLASTIC)	LF	2700							2700	
		613-0425	2-1/2 INCH ELECTRICAL CONDUIT (LIQUIDTIGHT FLEXIBLE METAL)	ĻF	50							50	1
		613-0703	4 PULL BOX (24X36X18)	EACH	21							21	
		613-1001	0 WIRING (SPECIAL)	LS	1							1	
		613-3435	LIGHT STANDARD METAL (35 F00T)	EACH	11								
		613-343	LIGHT STANDARD METAL (35 FOOT) (SPECIAL) (1 ARM)	EACH	235							235	
		613-4001	2 LIGHT STANDARD FOUNDATION SPECIAL	EACH	235							235	
		613-5010	0 LIGHTING CONTROL CENTER	EACH	16					"		 16	
		613-7040	0 LUMINAIRE HIGH PRESSURE SODIUM (400 WATT)	EACH	5					l		5	
		613-7515	0 LUMINAIRE METAL HALIDE (150 WATT)	EACH	481							481	
		614-0001	2 SIGN PANEL (CLASS II)	SF	358							 358	<u> </u>
		614-0061	2 STEEL SIGN POST (W 6X12)	LF	57							57	
		614-0082	1 STEEL SIGN POST (W 8X21)	LF	65							65	
		614-0158	5 STEEL SIGN SUPPORT (2-1/2 INCH ROUND SCH 80) (PDST)	LF	294							294	<b> </b>
		614-0158	8 STEEL SIGN SUPPORT (2-1/2 INCH ROUND SCH 80) (SLIPBASE)	EACH	24							24	
		614-0300	CONCRETE FOOTING (TYPE 1)	EACH	4							4	

Computer File	Information	ľ
Creation Date: 02/18/08	Initials: SRB	(
Last Modification Date: 02/18/08	Initials: SRB	C
Full Path: S:\Tranproj\100000508\1	6701\Consultants\Plot_Sets\FIR	(
Drawing File Name:	soq01.dgn	(
Scale:	Units: ENGLISH	(

IIIGGA	OI IVENISIONS	•	
			DO:
_		<del> </del>	DEPARTMENT OF TRANSPORTA
			i
1			REGION I

POT Region 1 18500 East Colfox Aurora, CO 80011 Phone: (303) 365-7340 PAX: (303) 365-7343 N I DW

0	4601 DTC Blvd, Suite 700 Denver, CO 80237 Phone: (303) 221-7275 Fox: (303) 221-7276
---	---

As Constructed	5	SUMM	4RY	OF		Project No./(	Code
No. Revisions:	APPRO)	<b>TAMIX</b>	E QI	ITITNAL	ES	IM 070A-00	3
Revised:	Designer:		Structure Numbers			16701	
Void:	Detailer: Sheet Subset:	SRB Summary	Subset St		1 of 2	Sheet Number:	5

# SUMMARY OF APPROXIMATE QUANTITIES

	INDEX		CONTRACT			TRA	FFIC					ſ	то	TALS
воок	PAGE	SHEET	ITEM NO.	CONTRACT ITEM	UNIT	PLAN	AS CONST.	PLAN	AS CONST.				PLAN	AS CONST.
			61401585	STEEL SIGN SUPPORT (2-1/2 INCH ROUND SCH 80) (POST)	LF	294							294	
			61401588	STEEL SIGN SUPPORT (2-1/2 INCH ROUND SCH 80) (SLIPBASE)	EACH	24							24	
			614-03001	CONCRETE FOOTING (TYPE 1)	EACH	4							4	
			614-03004	CONCRETE FOOTING (TYPE 4)	EACH	5							5	
			614-10128	BLANKOUT SIGN (FIBER OPTIC)	EACH	5							5	
			614-72830	COMMUNICATIONS CABINET	EACH	7							7	
			614-80000	FLASHING BEACON	EACH	4							4	
			614-86105	TELEMETRY (FIELD)	EACH	2							2	
			614-87010	FIBER OPTIC CABLE (SINGLE MODE) (12 FIBER)	LF	1000							1000	
			620-00020	SANITARY FACILITY	EACH	2							2	
			626-00000	MOBILIZATION	LS	1							1	
			630-00000	FLAGGING	HOUR	756							756	
			630-00007	TRAFFIC CONTROL INSPECTION	DAY	42							42	
			630-00012	TRAFFIC CONTROL MANAGEMENT	DAY	105							105	
			630-80341	CONSTRUCTION TRAFFIC SIGN (PANEL SIZE A)	EACH	6							6	
			630-80342	CONSTRUCTION TRAFFIC SIGN (PANEL SIZE B)	EACH	33							33	
			630-80343	CONSTRUCTION TRAFFIC SIGN (PANEL SIZE C)	EACH	26							26	
			630-80344	CONSTRUCTION TRAFFIC SIGN (SPECIAL)	SF	94							94	
			630-80355	PORTABLE MESSAGE SIGN PANEL	EACH	1							1	
			630-80358	ADVANCE WARNING FLASHING OR SEQUENCING ARROW PANEL (C TYPE)	EACH	1							1	
			630-80360	DRUM CHANNELIZING DEVICE	EACH	50							50	
			630-80380	TRAFFIC CONE	EACH	400							400	
			630-85040	IMPACT ATTENUATOR (TRUCK MOUNTED ATTENUATOR) (TEMPORARY)	EACH	1							1	
			700-70010	F/A MINOR CONTRACT REVISIONS	FA	0							0	
			700-70011	F/A PARTNERING	FA	0					<u> </u>		0	
			700-70023	F/A ON-THE-JOB TRAINEE	FA	1							1	
			700-70028	F/A ESB PROGRAM	FA	1							1	
			700-70380	F/A EROSION CONTROL	FA	1		-					1	

Computer File Information Creation Date: 02/18/08 Initials: SRB		Index of Revisions	DOT	Region 1 18500 East Colfax	PBSV	As Constructed	SUMMARY OF	Project No./Code
Last Modification Date: 02/18/08 Initials: SRB				Aurora, CO 80011 Phone: (303) 365-7340		No. Revisions:	APPROXIMATE QUANTITIES	IM 070A-003
Full Path: S:\Tranproj\100000508\16701\Consultants\Plot_Sets\FIR  Drawing File Name: soq02.dgn	=		DEPARTMENT OF TRANSPORTATION	FAX: (303) 365-7343	Suite 700 Denver, CO 80237	Revised:	Designer:         SRB         Structure           Detailer:         SRB         Numbers	16701
Scale: Units: ENGLISH			REGION I	DW	Phone: (303) 221-7275 Fax: (303) 221-7276	Void:	Sheet Subset: Summary Subset Sheets: 2 of 2	Sheet Number: 6

# TABULATION OF CONUDIT, PULL BOXES, CABINETS AND MARKERS


		FIBER OF	TIC CABLE E MODE)	LOCATI	ION MARKER (FIBER OPTIC)					CTRICAL CONDUIT	2-1/2 INCH ELE (PL	CTRICAL CONDUIT ASTIC)	2 INCH ELECTI (PLA	RICAL CONDUIT ASTIC)	3 INCH ELECT	TRICAL CONDUIT ASTIC)		
LOCATION	PULLBOX (24×36)	6 STRANDS	144 STRANDS	RUNNING LINE LOCATION MARKER	PULL BOX AND MANHOLE LOCATION MARKER	TOTAL	LOCATION MARKET (UTILITY) (FLAT SLAT)	R 3 INCH ELECTRICAL CONDUIT (BORED)	STICK-TYPE (PVC SCHEDULE 80)	REEL TYPE (HOPE SOR 13.5)	STICK-TYPE (PVC SCHEDULE 80)	REEL TYPE (HOPE SOR 13.5)	STICK-TYPE (PVC SCHEDULE 80)	REEL TYPE (HDPE SOR 13.5)	STICK-TYPE (PVC SCHEDULE 80)	REEL TYPE (HOPE SDR 13.5)	2-1/2 INCH ELECTRICAL CONDUIT (LIQUID TIGHT, FLEXIBLE, METAL)	Communications Cabinet
	EA	ĿF	U	EACH	EACH	EACH	EACH	LF.	UF	UF.	UF.	UF	LF.	UF .	UF	UF	LF	EACH
MP 177 EB - STA 10+00 TO 36+50	5	120			4		4											1
MP 183 EB STA 10+00 TO 24+00	2	60			2		2		10			1700				175		1
MP 184 EB - STA 10+00 TO 23+00	3	60			2		2	150										1
MP 195 EB - STA 10+00 TO 24+00	3	120			4		4											
SHEET 1								200		165								
SHEET 2										870	10					2525		
MP 196 WB - STA 10+00 TO 17+50	1	60			2		2			1000		100						1
MP 203 EB - STA 10+00 TO 17+00		60			2		2											
SHEET 1																		
SHEET 2		ļ														1		
MP 205 EB STA 10+00 TO 38+00	1	60			2		2											
MP 219 EB & WB - STA 10+00 TO 27+00, STA 10+00 TO 29+00		120			4		4			3550				150				1
MP 221 WB - STA 10+00 TO 19+00	1	60			2		2		50					1170				1
MP 223 WB - STA 10+00 TO 22+00	1	60			2		2											1
SHEET 1		60																
SHEET 2													30	-	ļ			
MP 228 EB & WB - STA 10+00 TO 38+00, STA 10+00 TO 44+00		120			4		4											
SHEET 1										1500		700		100				
SHEET 2										500						<b> </b>		
MP 241 EB - STA 10+00 TO 23+00	2	60		**********	2		2	150		2200				450				
MP 251 EB - STA 10+00 TO 19+00	2	60			2		2											
SHEET 1		60																
SHEET 2																<u> </u>		
MP 254 EB - STA 10+00 TO 23+50		60			2		2											
					T							·						
PROJECT TOTALS	21	1,080	0	0	36	0	36	500	60	9,785	10	2,500	30	1,870	0	2,700	50	7


Computer File Information		Index of Revisions	 Region 1		As Constructed			Project No./Code
Creation Date: 02/18/08 Initials: SRB			 1 18500 East Colfax	PBSI		I TABULAT	IONS	, ,
Last Modification Date: 02/25/08 Initials: SRB			 Aurora, CO 80011 Phone: (303) 365-7340	l <i>B</i>	No. Revisions:			IM 070A-003
Full Path: S: \Tranproj\100000508\16701\Consultants\Plot_Sets\FiR			DEPARTMENT OF TRANSPORTATION FAX: (303) 365-7343	Suite 700	Revised:	Designer: SRB Struc	ture	16701
Drawing File Name: bsta01.dgn			 1	Denver, CO 80237 Phone: (303) 221-7275	No Noca.	Detailer: SRB Numb		10701
Scole: Units: ENGLISH	0		 REGION I DW	Fox: (303) 221-7276	Void:	Sheet Subset: Tabs Subset	t Sheets: 1 of 1	Sheet Number:
						· · · · · · · · · · · · · · · · · · ·		·


MILE POST	SHEET NO.	INTERCHANGE/CHAIN STATION
177		EB Chain Station
180		Vail East Entrance Interchange
183		EB Chain Station
184		EB Chain Station
190		Shrine Pass Road Interchange
195		EB Chain Station
195		Copper Mountain, SH 91 Interchange
197		WB Chain Station
198		Officers Gulch Interchange
201		Frisco Main Street Interchange
203		SH9/Frisco Interchange
203		EB Chain Station; Frisco Overlook
205		Silverthorne Interchange
205		EB Chain Station
211		Hamilton Gulch Interchange
213		WB Chain Station
216		US6/Loveland Pass Interchange
218		Herman Gulch Interchange
219	-	EB Chain Station
219		WB Chain Station
221		Bakerville Interchange
221		WB Chain Station
223		WB Chain Station
226		Silver Plume Interchange
227		Georgetown Hill
228		EB Chain Station
228		WB Chain Station
232		Empire, US 40 Interchange
233		Lawson Interchange
234		Downieville Interchange
235	-	Dumont Interchange
238		Fall River Road Interchange
239	***************************************	West Idaho Springs Interchange
240		Mount Evans, SH 103 Interchange
241		East Idaho Springs, County Road 314 Interchange
241		EB Chain Station
242		Twin Tunnels
243		Hidden Valley Interchange
244		Golden, US 6 to SH 119 Interchange
247		Hyland Hills Interchange
248		Beaver Brook Interchange
251		EB Chain Station
251		El Rancho Interchange
252		Evergreen Parkway, SH 74 Interchange
253		Chief Hosa Interchange
254		Genesse Park Interchange


NOTES: THIS TABLE SHOWS THE STATION AND SHEET REFERENCE NUMBER FOR EACH CHAIN STATION IN THE PROJECT AREA. INTERCHANGES ARE ALSO SHOWN FOR QUICK REFERENCE.


	Computer File In Creation Date: 02/18/08		$\overline{}$	Index of Rev	/isions	TA DOM	Region 1	DDCI	As Constructed			Project No./Code
	Last Modification Date: 02/18/08	Initials: SRB Initials: SRB				$\bigcirc$ $DOT$	Aurora, CO 80011	<b>PBS</b> J	No. Revisions:	MILEPOST	INFORMATION	IM 070A-003
	Full Path: S:\Tranproj\100000508\16701 Drawing File Name:	\Consultants\Plot_Sets\FIR 16701milepostinfo.dgn	$\mathbb{R}$			DEPARTMENT OF TRANSPORTATION	EAV. (707) 705 7747	Suite 700 Denver, CO 80237	Revised:		B Structure	16701
ļ	Scale:	Units: ENGLISH				REGION I	DW	Phone: (303) 221-7275 Fax: (303) 221-7276	Void:		B Numbers It Subset Sheets:	Sheet Number:

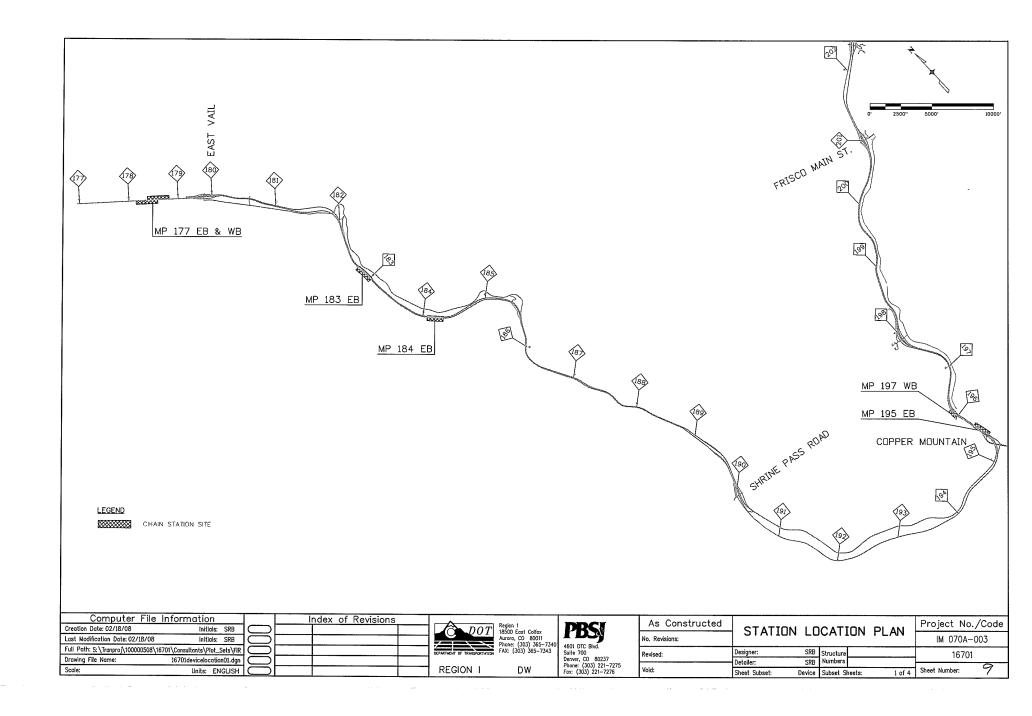

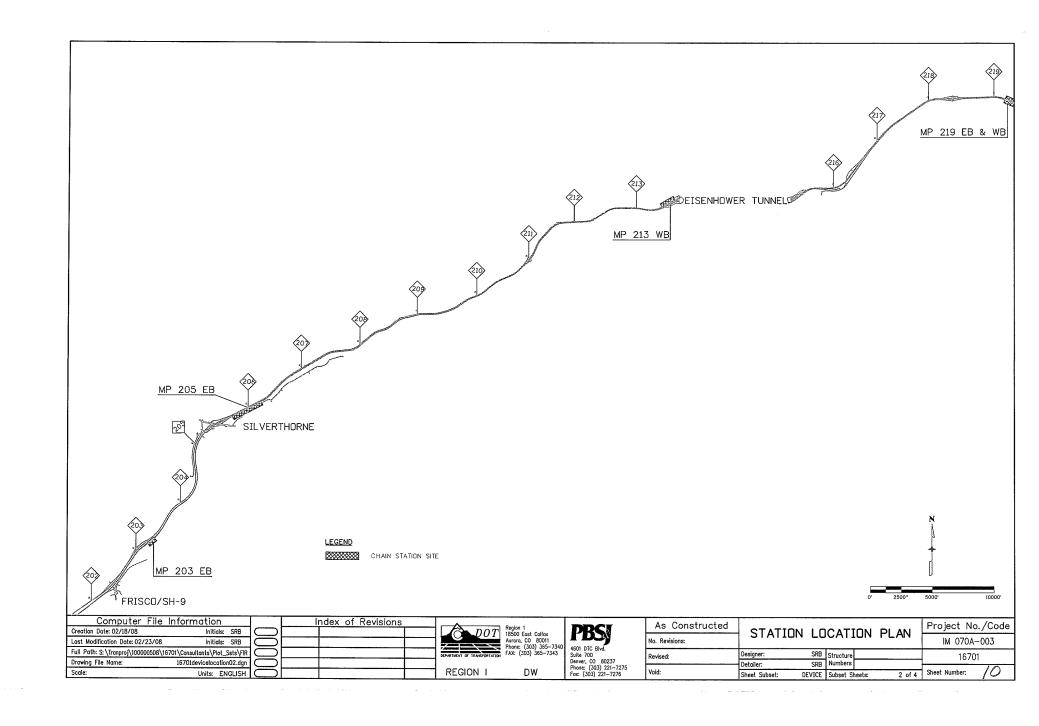

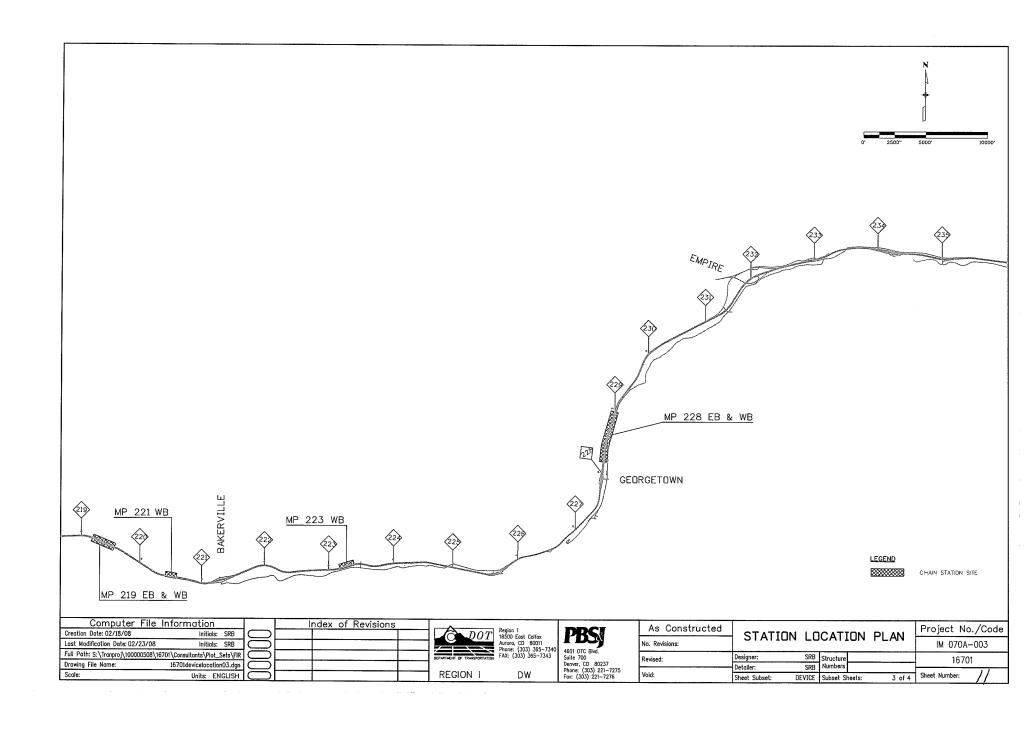

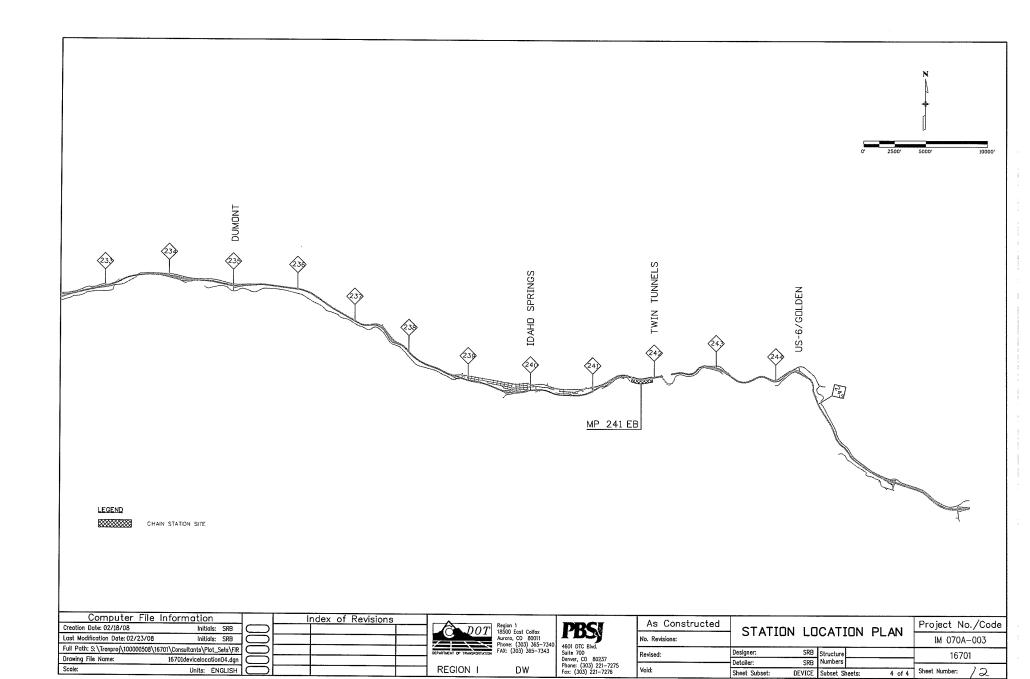

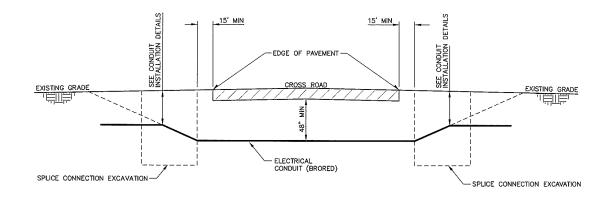


 $\frac{\text{CROSS ROAD DIRECTIONAL BORE PROFILE}}{\text{N.T.S}}$ 

#### NOTES:

- CONTRACTOR SHALL CONFORM TO THE APPLICABLE AGENCY REQUIREMENTS AND SPECIFICATION FOR BORE CROSSINGS
- CLEARANCE BETWEEN EXISTING ROAD BASE AND TOP OF PROPOSED CASING SHALL BE A MINIMUM OF 48 INCHES OR AS SPECIFIED BY THE ENGINEER.
- 3. MINIMUM DEPTH OF 48 INCHES MUST BE ACHIEVED AT LEAST 15 FEET FROM EDGE OF PAVEMENT AS NO EXCAVATION IS ALLOWED WITHIN 15 FEET.
- EXCAVATIONS REQUIRE SEEDING AND MULCHING.
- CONDUIT SPLICE CONNECTION EXCAVATION AND CONDUIT SPLICE SHALL NOT BE PAID SEPARATELY, BUT SHALL BE INCLUDED IN THE WORK.
- CONTRACTOR SHALL BACKFILL AND REGRADE SITE TO MATCH EXISTING CONDITIONS.
- CONTRACTOR MUST REPAIR ANY DAMAGE TO PAVEMENT CAUSED BY ERRANT BORING AT THEIR COST.

Computer File Information Creation Date: 02/18/08 Initials: SRB	$\overline{}$	Index of Revisions	Region 1	<b>PBSV</b>	As Constructed	DODING DETAILS	Project No./Code
Lost Modification Date: 02/18/08 Initials: SRB	$\equiv$		18500 East Colfax Aurora, CO 80011 Phone: (303) 365-7340		No. Revisions:	BORING DETAILS	IM 070A-003
Full Path: S:\Tranproj\10000508\16701\Consultants\Plot_Sets\FIR  Drawing File Name: bore-01.dan			DEPARTMENT OF TRANSPORTATION FAX: (303) 365-7343	4001 010 DIVO.	Revised:	Designer: SRB Structure	16701
	=		250001	Phone: (303) 221-7275		Detailer: SRB Numbers	
Scale: Units: ENGLISH	$\bigcirc$		REGION I DW	Fax: (303) 221-7276	Void:	Sheet Subset: Boring Subset Sheets: 1 of 6	Sheet Number: / 3

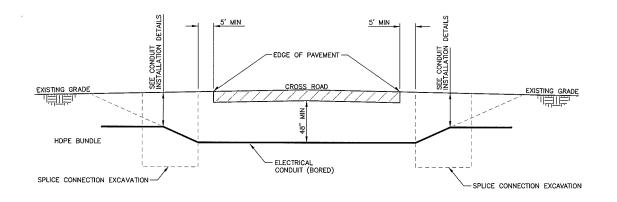


LOCAL ROAD/DIRECTIONAL BORE PROFILE
N.T.S

#### NOTES:

- CONTRACTOR SHALL CONFORM TO THE APPLICABLE AGENCY REQUIREMENTS AND SPECIFICATION FOR BORE CROSSINGS
- CLEARANCE BETWEEN EXISTING ROAD BASE AND TOP OF PROPOSED CASING SHALL BE A MINIMUM OF 48 INCHES OR AS SPECIFIED BY THE ENGINEER.
- 3. MINIMUM DEPTH OF 48 INCHES MUST BE ACHIEVED AT LEAST 15 FEET FROM EDGE OF PAVEMENT AS NO EXCAVATION IS ALLOWED WITHIN 15 FEET.
- EXCAVATIONS REQUIRE SEEDING AND MULCHING.
- 5. CONDUIT SPLICE CONNECTION EXCAVATION AND CONDUIT SPLICE SHALL NOT BE PAID SEPARATELY, BUT SHALL BE INCLUDED IN THE WORK.
- CONTRACTOR SHALL BACKFILL AND REGRADE SITE TO MATCH EXISTING CONDITIONS.
- 7. CONTRACTOR MUST REPAIR ANY DAMAGE TO PAVEMENT CAUSED BY ERRANT BORING AT THEIR COST.

Computer File Information Creation Date: 02/18/08 Initials: SRB		Index of Revisions	DOT	Region 1	<b>PBS</b>	As Constructed	DUD	ING DETAILS	Project No./Code
Last Modification Date: 02/18/08 Initials: SRB	$\mathbb{I}$			18500 East Colfax Aurora, CO 80011 Phone: (303) 365-7340		No. Revisions:	) BUK	ING DETAILS	IM 070A-003
Full Path: S:\Tranproj\100000508\16701\Consultants\Plot_Sets\FIR	0		DEPARTMENT OF TRANSPORTATION	FAX: (303) 365-7343	Suite 700	Revised:	Designer:	SRB Structure	16701
Drawing File Name: bore-02.dgn					Denver, CO 80237 Phone: (303) 221-7275		Detailer:	SRB Numbers	1,,,
Scale: Units: ENGLISH			REGION I	DW	Fax: (303) 221-7276	Void:	Sheet Subset:	Boring Subset Sheets:	2 of 6 Sheet Number:

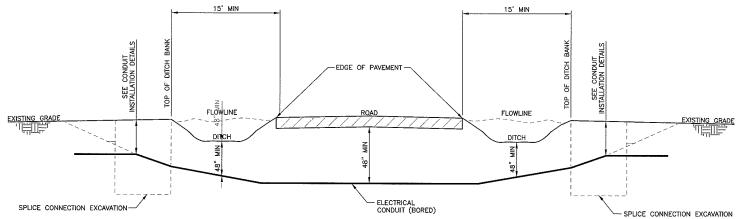

# ROAD AND DITCH DIRECTIONAL BORE PROFILE

#### NOTES:


- CONTRACTOR SHALL CONFORM TO THE APPLICABLE AGENCY REQUIREMENTS AND SPECIFICATION FOR BORE CROSSINGS
- CLEARANCE BETWEEN EXISTING ROAD BASE AND TOP OF PROPOSED CASING SHALL BE A MINIMUM OF 48 INCHES OR AS SPECIFIED BY THE ENGINEER.
- 3. MINIMUM DEPTH OF 48 INCHES MUST BE ACHIEVED AT LEAST 15 FEET FROM EDGE OF PAVEMENT AS NO EXCAVATION IS ALLOWED WITHIN 15 FEET.
- 4. EXCAVATIONS REQUIRE SEEDING AND MULCHING.
- 5. CONDUIT SPLICE CONNECTION EXCAVATION AND CONDUIT SPLICE SHALL NOT BE PAID SEPARATELY, BUT SHALL BE INCLUDED IN THE WORK.
- CONTRACTOR SHALL BACKFILL AND REGRADE SITE TO MATCH EXISTING CONDITIONS.
- CONTRACTOR MUST REPAIR ANY DAMAGE TO PAVEMENT CAUSED BY ERRANT BORING AT THEIR COST.

Computer File Information Creation Date: 02/18/08 Initials: SRB		Index of Revisions	 DOT Region 1 18500 East Colfor	n	BSV	As Constructed		ODINO	DETAIL	_	Project No	o./Code
Last Modification Date: 02/18/08 Initials: SRB	$\equiv$		18500 East Colfa Aurora, CO 8001 Phone: (303) 365		DTC Blvd.	No. Revisions:		BORING	DETAILS	5	IM 070A-	-003
Full Path: S: \Tranproj\100000508\16701\Consultants\Plot_Sets\FIR	$\subseteq$		DEPARTMENT OF TRANSPORTATION FAX: (303) 365-	343 Suite	700	Revised:	Designer:	SRB	Structure		1670	)1
Drawing File Name: bore-03.dgn	$\bigcirc$				rer, CO 80237 ne: (303) 221-7275		Detailer:	SRB	Numbers			<del>`</del>
Scale: Units: ENGLISH (			REGION I DW	Fox:	(303) 221-7276	Void:	Sheet Subset:	Boring	Subset Sheets:	3 of 6	Sheet Number:	15



#### NOTES:

- CONTRACTOR SHALL CONFORM TO THE APPLICABLE AGENCY REQUIREMENTS AND SPECIFICATION FOR BORE CROSSINGS.
- 2. CLEARANCE BETWEEN EXISTING ROAD BASE AND TOP OF PROPOSED CASING SHALL BE A MINIMUM OF 48 INCHES OR AS SPECIFIED BY THE ENGINEER.
- MINIMUM DEPTH OF 48 INCHES MUST BE ACHIEVED AT LEAST 5 FEET FROM EDGE OF PAVEMENT.
- 4. EXCAVATIONS AND DISTURBANCE LIMITS REQUIRE SEEDING AND MULCHING.
- REFER TO SPECIAL PROVISIONS FOR REQUIREMENTS ON HANDLING AND DISPOSING OF BORING SLUDGE.
- 6. CONDUIT SPLICE CONNECTION EXCAVATION AND CONDUIT SPLICE SHALL NOT BE PAID SEPARATELY, BUT SHALL BE INCLUDED IN THE WORK.
- 7. CONTRACTOR SHALL BACKFILL AND REGRADE SITE TO MATCH EXISTING CONDITIONS.
- CONTRACTOR MUST REPAIR ANY DAMAGE TO PAVEMENT CAUSED BY ERRANT BORING AT THEIR COST.

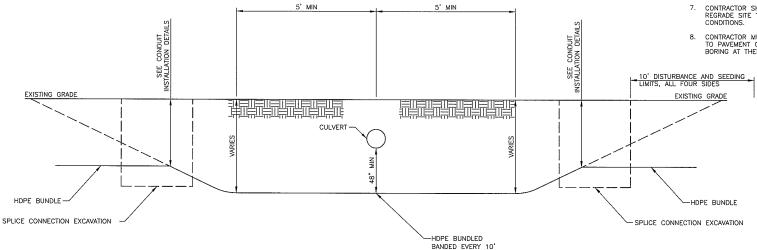

## CULVERT DIRECTIONAL BORE PROFILE

N.T.S.


#### NOTE:

REFER TO CONDUIT INSTALLATION DETAILS FOR CASES WHERE TRENCH CROSSES OVER TOP OF CULVERT.

Computer File Information Creation Date: 02/18/08 Initials: SRB	—}	Index of Revisions	DOT	Region 1	<b>PBSI</b>	As Constructed	DODIN	G DETAILS	Project No./Code
Last Modification Date: 02/22/08 Initials: SRB	≓!		( -)01	18500 East Colfax Aurora, CO 80011 Phone: (303) 365-7340		No. Revisions:	BOKTIA	G DETAILS	IM 070A-003
Full Path: S:\Tranproj\100000508\16701\Consultants\Plot_Sets\FIR	$\supseteq$		DEPARTMENT OF TRANSPORTATION	FAX: (303) 365-7343	Suite 700	Revised:		RB Structure	16701
Drawing File Name: bore-04.dgn	<b></b> 2ŀ		DEGLON	DW	Denver, CO 80237 Phone: (303) 221-7275 Fax: (303) 221-7276		Detailer: S	RB Numbers	- 1/
Scale: Units: ENGLISH			REGION I	DW	Fax: (303) 221-7276	Void:	Sheet Subset: Bor	ing Subset Sheets: 4	of 6 Sheet Number: /6





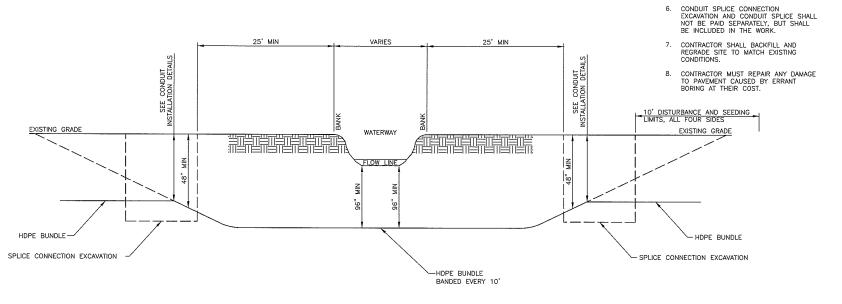

NOTES:

CONTRACTOR SHALL CONFORM TO THE APPLICABLE AGENCY REQUIREMENTS AND SPECIFICATION FOR BORE CROSSINGS.

2. CLEARANCE BETWEEN EXISTING BOTTOM OF WATERWAY AND TOP OF PROPOSED CASING SHALL BE A MINIMUM OF 96 INCHES OR AS SPECIFIED BY THE ENGINEER.

3. MINIMUM DEPTH OF 96 INCHES MUST BE ACHIEVED AT LEAST 25 FEET FROM EDGE OF WATERWAY AS NO EXCAVATION IS ALLOWED WITHIN 25 FEET OF THE BANKS. 4. EXCAVATIONS AND DISTURBANCE LIMITS REQUIRE SEEDING AND MULCHING. REFER TO SPECIAL PROVISIONS FOR REQUIREMENTS ON HANDLING AND DISPOSING OF BORING SLUDGE.

#### WATERWAY DIRECTIONAL BORE PROFILE

N.T.S.

#### NOTE:

SENSITIVE ENVIRONMENTAL AREA. NO PARKING, NO WORK AND NO STORING OF EQUIPMENT OR SUPPLIES IN THESE SENSITIVE ENVIRONMENTAL AREAS.


Computer File Information Creation Date: 02/18/08 Initials: SRB	Index of Revisions	DOT Region 1 18500 East Colfax	PBSV	As Constructed	BORING DETAILS	Project No./Code
Last Modification Date: 02/22/08 Initials: SRB		Auroro, CO 80011 Phone: (303) 365-7340		No. Revisions:	BUNING DETAILS	IM 070A-003
Full Path: S: \Tranproj\10000508\16701\Consultants\Plot_Sets\FIR  Drawing File Name: bore-05.dan		DEPARTMENT OF TRANSPORTATION FAX: (303) 365-7343		Revised:	Designer: SRB Structure	16701
Scale: Units: ENGLISH		REGION I DW	Phone: (303) 221-7275	Void:	Detailer:   SRB   Numbers	Sheet Number: / 17



CALL 2 BUSINESS DAYS IN ADVANCE BEFORE YOU DID, GRADE OR EXCANATE FOR THE MERCHAN BEFORE THE MERCHAN BEFORE THE MERCHAN OF INDERCENDING

#### NOTES:

- . CONTRACTOR SHALL CONFORM TO THE APPLICABLE AGENCY REQUIREMENTS AND SPECIFICATION FOR BORE CROSSINGS.
- 2. CLEARANCE BETWEEN EXISTING GRDUND AND TOP OF PROPOSED CASING SHALL BE A MINIMUM OF 96 INCHES OR AS SPECIFIED BY THE ENGINEER.
- 3. MINIMUM DEPTH OF 48 INCHES MUST BE ACHIEVED AT LEAST 25 FEET FROM EDGE OF WETLAND PERIMETER AS NO EXCAVATION IS ALLOWED WITHIN 25 FEET OF THE WETLAND PERIMETER.
- 4. EXCAVATIONS AND DISTURBANCE REQUIRE SEEDING AND MULCHING.
- 5. REFER TO SPECIAL PROVISIONS FOR REQUIREMENTS ON HANDLING AND DISPOSING OF BORING SLUDGE.
- 6. CONDUIT SPLICE CONNECTION EXCAVATION AND CONDUIT SPLICE SHALL NOT BE PAID SEPARATELY, BUT SHALL BE INCLUDED IN THE WORK.
- CONTRACTOR SHALL BACKFILL AND REGRADE SITE TO MATCH EXISTING CONDITIONS.
- 8. CONTRACTOR MUST REPAIR ANY DAMAGE TO PAVEMENT CAUSED BY ERRANT BORING AT THEIR COST.

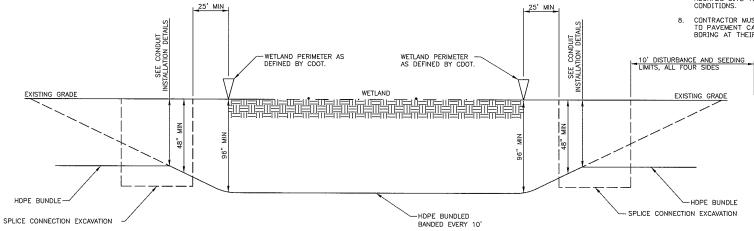


# WETLAND DIRECTIONAL BORE PROFILE N.T.S.

#### NOTE:

SENSITIVE ENVIRONMENTAL AREA. NO PARKING, NO WORK AND NO STORING OF EQUIPMENT OR SUPPLIES IN THESE SENSITIVE ENVIRONMENTAL AREAS.

Computer File Information Creation Date: 02/18/08 Initials: SRB		Index of Revisions	DOT	Region 1	<b>PBS</b>	As Constructed	DODINO	DETAILO	Project No./Code
Last Modification Date: 02/22/08 Initials: SRB	))		$\bigcirc DOT$	18500 East Colfax Aurora, CO 80011 Phone: (303) 365-7340		No. Revisions:	BUKING	DETAILS	IM 070A-003
Full Path: S: \Tranproj\100000508\16701\Consultants\Plot_Sets\FIR			DEPARTMENT OF TRANSPORTATION	CAN. (707) 300 3747	Suite 700	Revised:	Designer: SRB	Structure	16701
Drawing File Name: bore-06.dgn	0				Denver, CO 80237 Phone: (303) 221-7275		Detailer: SRB	Numbers	/~
Scale: Units: ENGLISH			REGION I	DW	Fox: (303) 221-7276	Void:	Sheet Subset: BORING	Subset Sheets: 6 c	f 6 Sheet Number: / 🖔

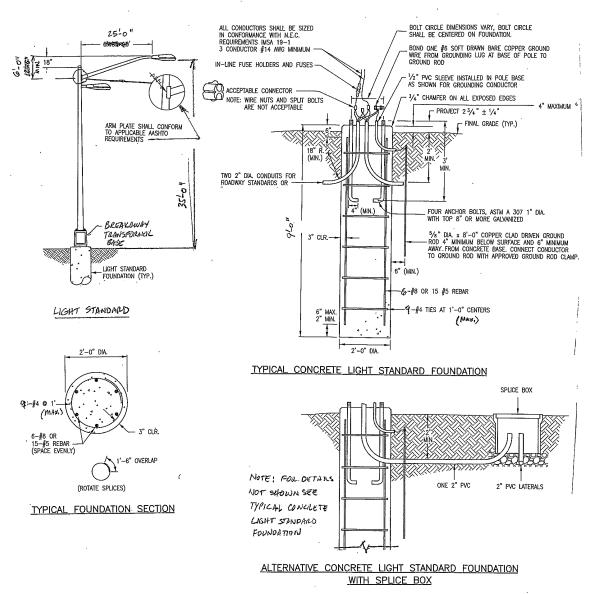

#### GENERAL NOTES

- 1. REFER TO THE ROADWAY PLANS FOR THE ACTUAL CONFIGURATION AND LOCATION OF LIGHT STANDARDS.
- FOR CONDUIT, PULL OR SPLICE BOX, CONTROL CENTER, AND CABINET DETAILS SEE STANDARD PLAN M-613-1 SHEET 4 OF 4.
- LIGHT STANDARDS SHALL NOT BE PLACED IN DITCHES OR OTHER LOW AREAS. EMBANKMENT AND BACKFILL SHALL BE COMPACTED IN ACCORDANCE WITH SECTION 203.
- POLE CAPS ARE REQUIRED.
- BREAK-AWAY TRANSFORMER BASES SHALL BE INCLUDED ON ALL LIGHT STANDARDS, FOR DETAILS SEE STANDARD PLAN NO. M-613-1 SHEET 2 OF 4.
- CONCRETE FOR CAISSON FOUNDATIONS SHALL BE AIR ENTRAINED CLASS BZ CONCRETE IN ACCORDANCE WITH SECTION 503 OF THE STANDARD SPECIFICATIONS.
- DRILLED FOUNDATION CONCRETE SHALL REACH THE SEVEN DAY PREDICTED STRENGTH PRIOR TO INSTALLING THE LIGHT SYANDARD.
- DRILLED SHAFT FOUNDATIONS SHALL BE PLACED AGAINST UNDISTURBED EARTH, PRECAST CONCRETE FOUNDATIONS ARE NOT ALLOWED.
- 9. CABINET BASE OR PAD AND LEVELLING CONCRETE SHALL BE CLASS B CONCRETE.
- 10. REINFORCING STEEL FOR FOUNDATIONS SHALL BE GRADE 60.
- 11. WELDING OF STEEL SHALL CONFORM TO THE REQUIREMENTS OF ANSIAWS D1.1 ALL AREAS TO BE WELDED SHALL BE GROUND TO BRIGHT METAL. ALL WELDING AND REQUIRED TESTING SHALL BE COMPLETE BEFORE ANY MATERIAL IS GALVANIZED. ALL CIRCUMFERENTIAL WELDS SHALL NE NON-DISTRUCTIVELY TESTED USING THE ENHANCED MAGNETIC PARTICLE METHOD IN ACCORDANCE WITH SUBSECTION 509.18 (D) OF THE STANDARD SPECIFICATIONS. THE ACCEPTANCE CRITERIA IS STATED IN TABLE 6.1 OF ANSI/AWS D1.1.
- LIGHT STANDARDS SHALL BE DESIGNEDAND CONSTRUCTED TO THE DESIGN CRITERIA LISTED ON THIS SHEET AND IN THE SPECIAL PROVISIONS.
- 13. WORKING DRAWINGS AND DESIGN CALCULATIONS SHALL BE SUBMITTED TO THE ENGINEER.

#### LUMINARIE AND ELECTRIC NOTES

- 1. LUMINAIRES WITH LAMPS RATED MORE THAN 3200 LUMENS SHALL BE IESNA FULL CUTOOF DISTRIBUTION
- 2. FLAT LENS IS REQUIRED ON ALL INSTALLATIONS.
- 3. PHOTO ELECTRIC CONTROLS SHALL BE LOCATED AT THE LIGHTING CONTROL CENTER. SEE CDOT STANDARD PLAN NO. M-613-1 SHEET 4 OF 4. DETAILS FOR ADDITIONAL INFORMATION.

#### DESIGN CRITERIA

#### **GENERAL**

- 1. LIGHT STANDARDS AND FOUNDATIONS SHALL BE DESIGNED IN ACCORDANCE WITH THE AASHTO STANDARD SPECIFICATIONS FOR STRUCTURAL SUPPORTS FOR HIGHWAY SIGNS, LUMINAIRES, AND TRAFFIC SIGNALS, 4<sup>TM</sup> EDITIONS INCLUDING INTERIMS THROUGH 2006. LIGHT STANDRS SHALL BE DESIGNED AND CONSTRUCTED TO THE FATIGUE REQUIREMENTS IN THESE PUBLICATIONS.
- A DESIGN WIND VELOCITY OF 100 MPH AND ONE 12' LANE WITH A 65 MPH TRUCK-INDUCED GUST LOADING SHALL BE USED FOR DESIGN.
- GALLOPING LOADS ARE EXCLUDED FROM FATIGUE DESIGN AND CATEGORY 2 IMPORTANCE FACTORS SHALL BE USED.

#### FOUNDATION DESIGN


- 1. FOUNDATIONS HAVE BEEN DESIGNED FOR THE FOLLOWING SOIL PARAMETERS:
  - SOIL DENSITY Y = 110 LB./CU. FT.
  - SOIL COHESION = 750 LB./SQ.FT. FOR MEDIUM DENSITY COHESIONLESS SOIL
  - SOIL CORESION = 750 LB.75Q.FT. FOR MEDIUM BENSITY CORESION SOIL PANGLE = 30° FOR MEDIUM DENSE COHENSIONLESS SOIL
  - SF = 1.25 FOR TORSIONAL RESISTANCE AND 3.0 FOR FLEXURAL RESISTANCE
- THE CONTRACTOR SHALL OBTAIN SOIL SAMPLES PRIOR TO FOUNDATION CONSTRUCTION TO VERIFY THAT AS-DESIGNED SOIL PROPERTIES ADEQUATELY MATCH THE IN-SITU SOIL PROPERTIES. THE CONTRACTOR SHALL FORWARD COPIES OF THE SOIL DATA TO THE ENGINEER PRIOR TO FOUNDATION CONSTRUCTION.
- THE CONTRACTOR SHALL STOP FOUNDATION INSTALLATION AND CONTACT THE ENGINEER IF ANY OF THE
  FOLLOWING SOIL CONDITIONS ARE ENCOUNTERED DURING DRILLING:
  - (A) THE SOIL HAS A HIGH ORGANIC CONTENT OR CONSISTS OF STAURATED SILT AND CLAY
  - (B) THE SITE WILL NOT SUPPORT THE WEIGHT OF THE DRILLING RIG
  - (C) THE FOUNDATION SOILS ARE NOT HOMOGENIOUS
  - (D) FIRM BEDROCK IS ENCOUNTERED


PRELIMINARY


SPECIAL LIGHT STANDARD DETAILS

CHAIN STATIONS



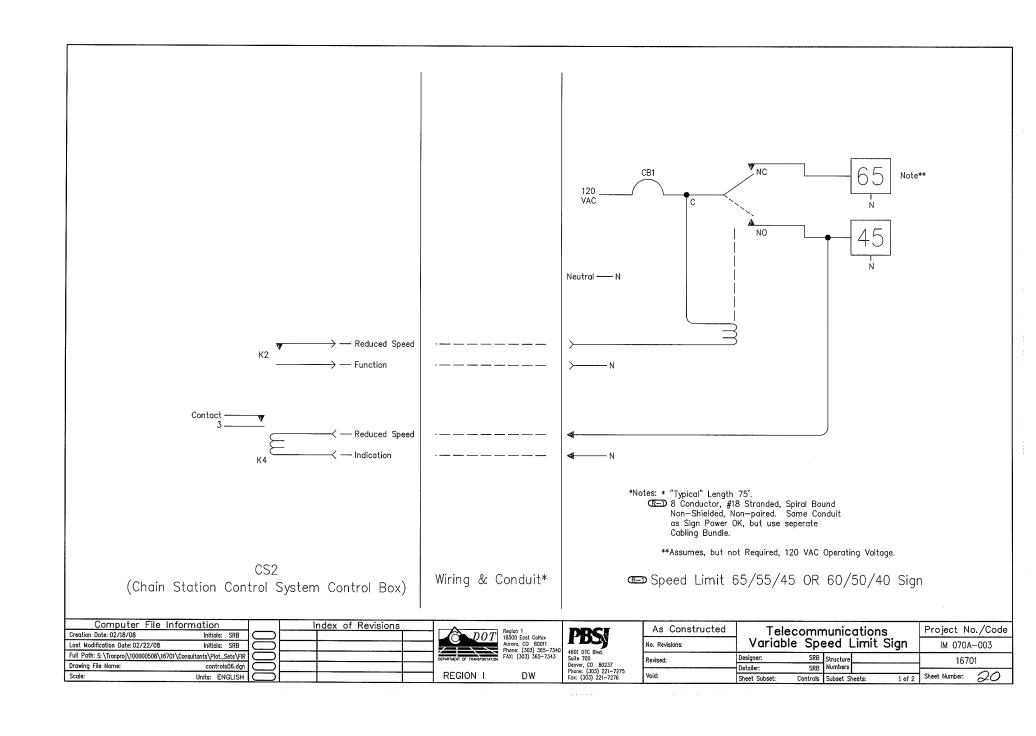

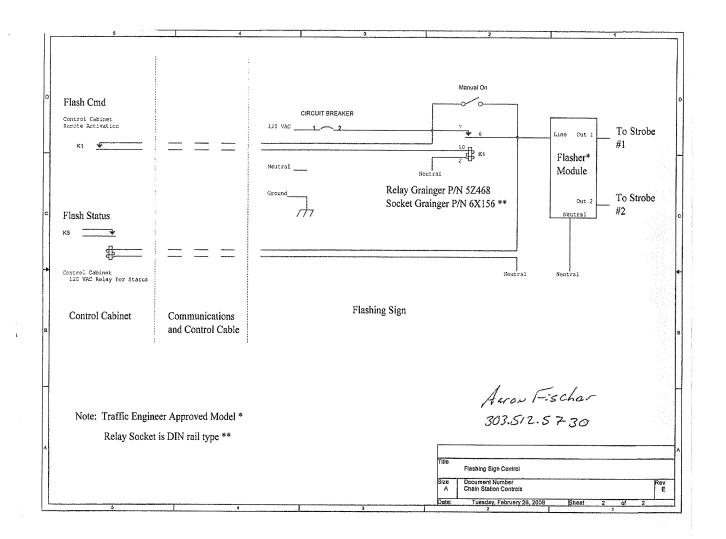

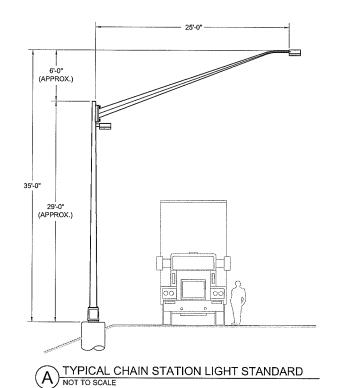

CLANTON & ASSOCIATES

# TABULATION OF APPROXIMATE QUANTITIES

ITEM NUMBER	LONG DESCRIPTION	UNIT	QUANTITY	NOTES
613-01200	2 INCH ELECTRICAL CONDUIT (PLASTIC)	LF	29,500	
613-10010	WIRING (SPECIAL)	LS	35	
613-34350	LIGHT STANDARD METAIL (35 FOOT)	EA	11	
613-34351	LIGHT STANDARD METAIL (35 FOOT) (SPECIAL) (1 ARM)	EA	235	
613-40101	LIGHT STANDARD FOUNDATION (SPECIAL)	EA	246	
613-50100	LIGHTING CONTROL CENTER	EA	18	1
613-75150	LUMINAIRE METAL HALIDE (150 WATT)	EA	481	

## NOTES:

1. LIGHTING CONTROL CENTER TO BE 'CABINET' TYPE PER CDOT STANDARD M-613-1.

# LEGEND:

- •• (1) 150W MH, FULL CUTOFF ROADWAY LUMINAIRE INSTALLED ON A 29' POLE.
- •••• (2) 150W MH, FULL CUTOFF ROADWAY LUMINAIRES INSTALLED ON A 29' PDLE AND 25'-0" MAST ARM.
- 24" DEEP TRENCH, BURY ELECTRICAL RACEWAY. RACEWAY TO BE (3\*4 THWN & 1\*4 GND).
- NEW LIGHTING CONTROL CENTER PER COOT STANDARD M-613-1.

# PRELIMINARY

SUBJECT TO REVISION

Computer File Information	Index of Revisions	Parley 1		As Constructed	LIGHTING DI AN	Project No./Code
Creation Date: Initials: GF		DOT 18500 East Colfax	PBSI	710 00110111000	LIGHTING PLAN	110,000 110.7 0000
Last Modification Date: Initials: JE		Aurora, CO 80011		No. Revisions:	TABULATIONS AND DETAIL	IM 070A-003
Full Path: Z:\VAIL CHAIN STATIONS\CURRNET\		Phone: (303) 365-7340  Phone: (303) 365-7343  PAX: (303) 365-7343		Revised:	Designer: GF Structure	16701
Drawing File Name:		1	Denver, CO 80237	venzer.	Detailer: JE Numbers	10/01
0 1 07750 70 0015		- DECION I DIV	Phone: (303) 221-7275	W. 11		
Scale: REFER TO BAR SCALE Units: ENGLISH	! !	REGION I DW	Fax: (303) 221-7276	Void:	Sheet Subset: LE Subset Sheets: 01 OF 24	Sheet Number: 22